DESIGN DEVELOPMENT ISSUED FOR QS REVIEW CIVIL ENGINEERING WORKS PACKAGE




DRAWING SCHEDULE					
DRG No.	DRAWING TITLE				
C1.01	COVERSHEET, DRAWING SCHEDULE AND LOCALITY PLAN				
C2.01	CONCEPT SEDIMENT AND EROSION CONTROL PLAN				
C2.11	SEDIMENT AND EROSION CONTROL DETAILS				
C3.01	BULK EARTHWORKS PLAN				
C4.01	SITEWORKS AND STORMWATER MANAGEMENT PLAN				
C5.01	UTILITY SERVICES IMPACT PLAN				
C5.11	UTILITY SERVICES SECTION - SHEET 1				
C5.12	UTILITY SERVICES SECTION - SHEET 2				
C5.13	UTILITY SERVICES SECTION - SHEET 3				

REVISION	DESCRIPTION	I	SSUED	VER'D	APP'D	DATE	CL
1	DESIGN DEVELOPMENT ISSUED FOR QS REVIEW		J.P		T.H	24.04.20	
2	ISSUED FOR REF		D.T		T.H	22.05.20	

Welcome to City of Parramatta DRAWING NOT TO BE USED FOR CONSTRUCTION UNLESS VERIFICATION

SPACKMAN MOSSOP == MICHAELS

THE COPYRIGHT OF THIS DRAWING REMAINS WITH NORTHROP

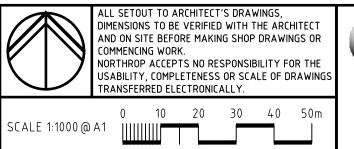





CHARLES STREET SQUARE

COVERSHEET, DRAWING SCHEDULE AND LOCALITY PLAN

NOT FOR CONSTRUCTION 182116 DRAWING NUMBER

DRAWING SHEET SIZE = A1

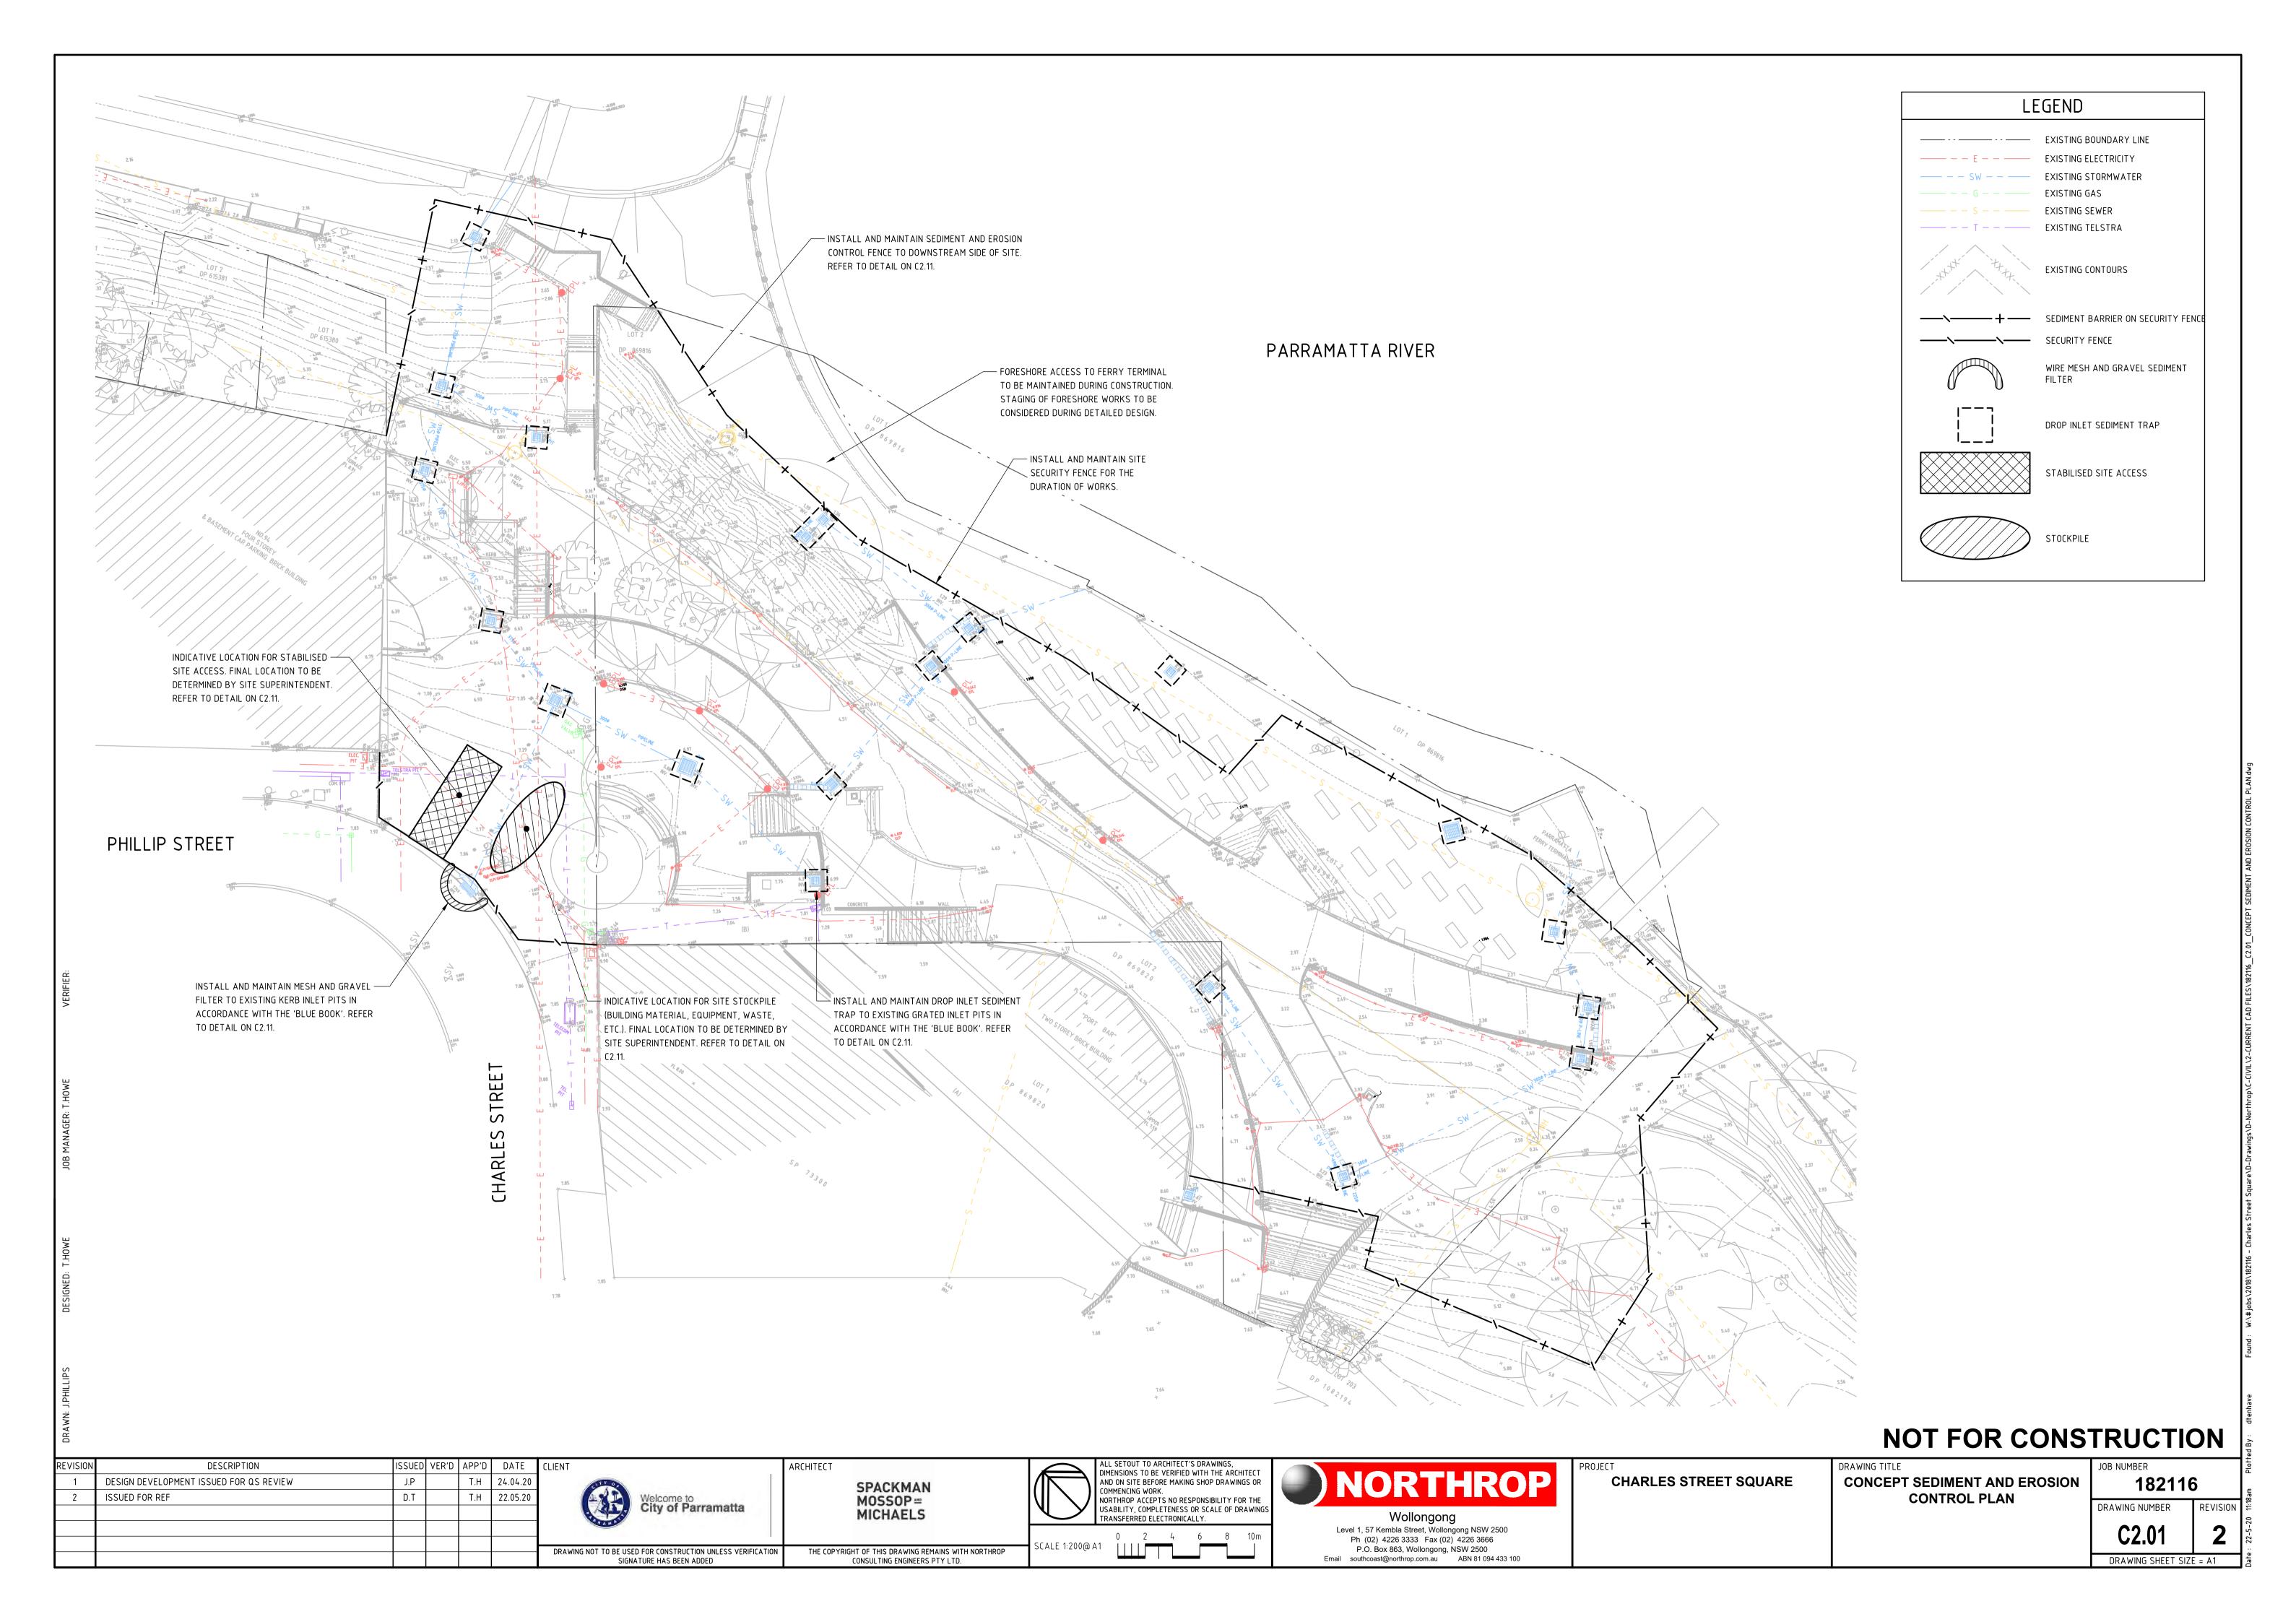


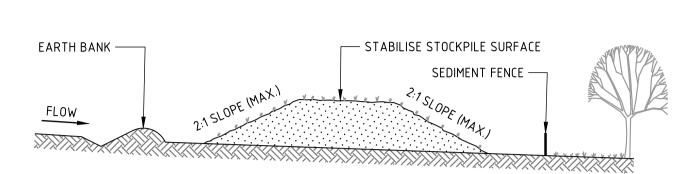

CONSTRUCTION NOTES

- 1. PLACE STOCKPILES MORE THAN 2m (PREFERABLY 5m) FROM EXISTING VEGETATION, CONCENTRATED WATER FLOW, ROADS AND HAZARD AREAS.
- 2. CONSTRUCT ON THE CONTOUR AS LOW, FLAT, ELONGATED MOUNDS.
- 3. WHERE THERE IS SUFFICIENT AREA, TOPSOIL STOCKPILES SHALL BE LESS THAN 2m IN HEIGHT.
- 4. WHERE THEY ARE TO BE IN PLACE FOR MORE THAN 10 DAYS, STABILISE FOLLOWING THE APPROVED ESCP OR SWMP TO REDUCE THE C-FACTOR TO LESS THAN 0.10.
- 5. CONSTRUCT EARTH BANKS (STANDARD DRAWING 5-5) ON THE UPSLOPE SIDE TO DIVERT WATER AROUND STOCKPILES AND SEDIMENT FENCES (STANDARD DRAWING 6-8) 1 TO 2m DOWNSLOPE.


STOCKPILE

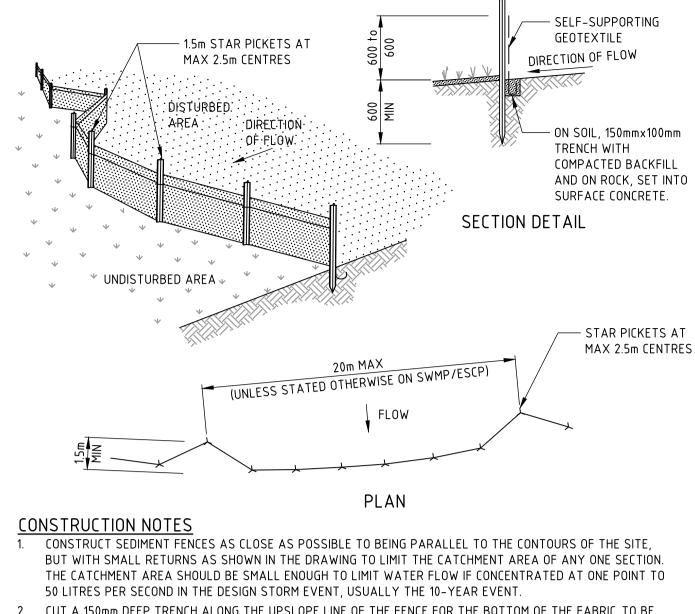

- 1.5m STAR PICKETS AT MAX 2.5m CENTRES

- 2. CUT A 150mm DEEP TRENCH ALONG THE UPSLOPE LINE OF THE FENCE FOR THE BOTTOM OF THE FABRIC TO BE ENTRENCHED.
- 3. DRIVE 1.5 METRE LONG STAR PICKETS INTO GROUND AT 2.5 METRE INTERVALS (MAX) AT THE DOWNSLOPE EDGE OF THE TRENCH. ENSURE ANY STAR PICKETS ARE FITTED WITH SAFETY CAPS.
- 4. FIX SELF-SUPPORTING GEOTEXTILE TO THE UPSLOPE SIDE OF THE POSTS ENSURING IT GOES TO THE BASE OF THE TRENCH. FIX THE GEOTEXTILE WITH WIRE TIES OR AS RECOMMENDED BY THE MANUFACTURER. ONLY USE GEOTEXTILE SPECIFICALLY PRODUCED FOR SEDIMENT FENCING. THE USE OF SHADE CLOTH FOR THIS PURPOSE IS NOT SATISFACTORY.
- 5. JOIN SECTIONS OF FABRIC AT A SUPPORT POST WITH A 150mm OVERLAP.
- 6. BACKFILL THE TRENCH OVER THE BASE OF THE FABRIC AND COMPACT IT THOROUGHLY OVER THE GEOTEXTILE.


SEDIMENT FENCE - LANDSCAPED AREAS

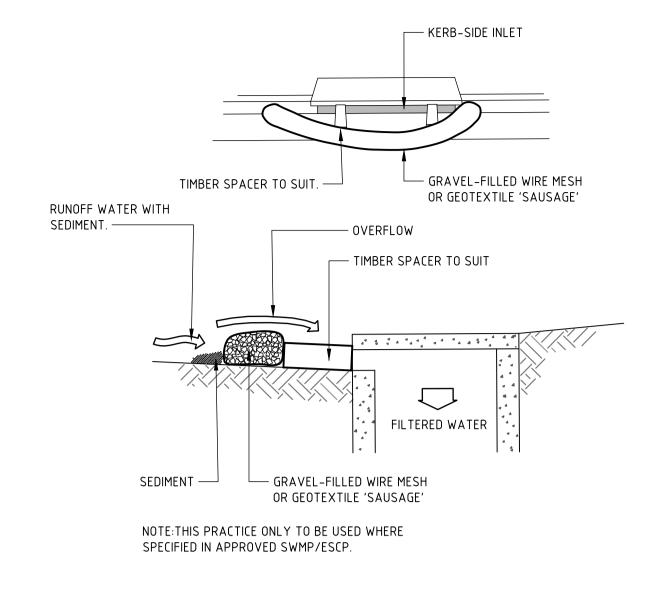

CONSTRUCTION NOTES

- 1. INSTALL FILTERS TO KERB INLETS ONLY AT SAG POINTS.
- 2. FABRICATE A SLEEVE MADE FROM GEOTEXTILE OR WIRE MESH LONGER THAN THE LENGTH OF THE INLET PIT AND FILL IT WITH 25mm TO 50mm GRAVEL.
- 3. FORM AN ELLIPTICAL CROSS-SECTION ABOUT 150mm HIGH x 400mm WIDE.
- 4. PLACE THE FILTER AT THE OPENING LEAVING AT LEAST A 100mm SPACE BETWEEN IT AND THE KERB INLET. MAINTAIN THE OPENING WITH SPACER BLOCKS.
- 5. FORM A SEAL WITH THE KERB TO PREVENT SEDIMENT BYPASSING THE FILTER.
- 6. SANDBAGS FILLED WITH GRAVEL CAN SUBSTITUTE FOR THE MESH OR GEOTEXTILE PROVIDING THEY ARE PLACED SO THAT THEY FIRMLY ABUT EACH OTHER AND SEDIMENT-LADEN WATERS CANNOT PASS BETWEEN.


WIRE MESH AND GRAVEL SEDIMENT FILTER SD6.11

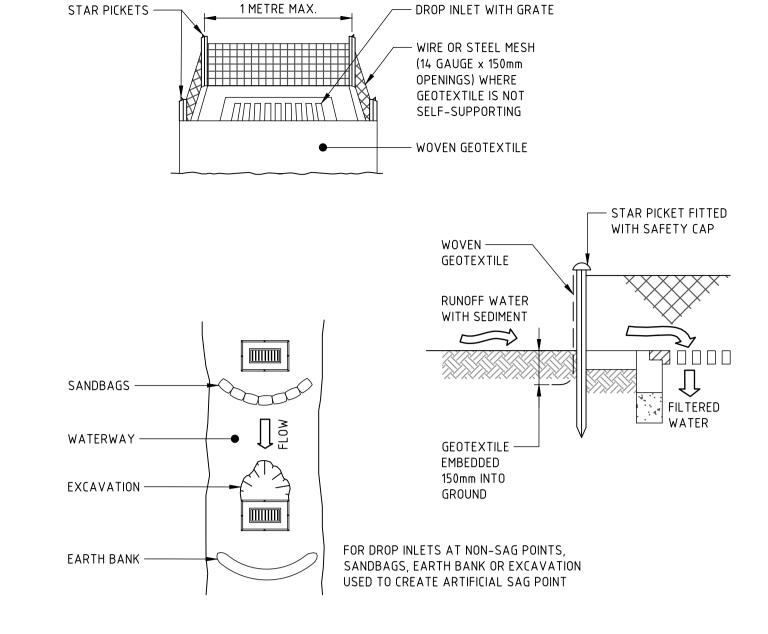

CONSTRUCTION NOTES

- 1. FABRICATE A SEDIMENT BARRIER MADE FROM GEOTEXTILE OR STRAW BALES.
- 2. FOLLOW STANDARD DRAWING 6-7 AND STANDARD DRAWING 6-8 FOR INSTALLATION PROCEDURES FOR THE STRAW BALES OR GEOFABRIC. REDUCE THE PICKET SPACING TO 1 METRE CENTRES.
- 3. IN WATERWAYS, ARTIFICIAL SAG POINTS CAN BE CREATED WITH SANDBAGS OR EARTH BANKS AS SHOWN IN
- 4. DO NOT COVER THE INLET WITH GEOTEXTILE UNLESS THE DESIGN IS ADEQUATE TO ALLOW FOR ALL WATERS TO BYPASS IT.


GEOTEXTILE INLET FILTER TRAPS SD6.12

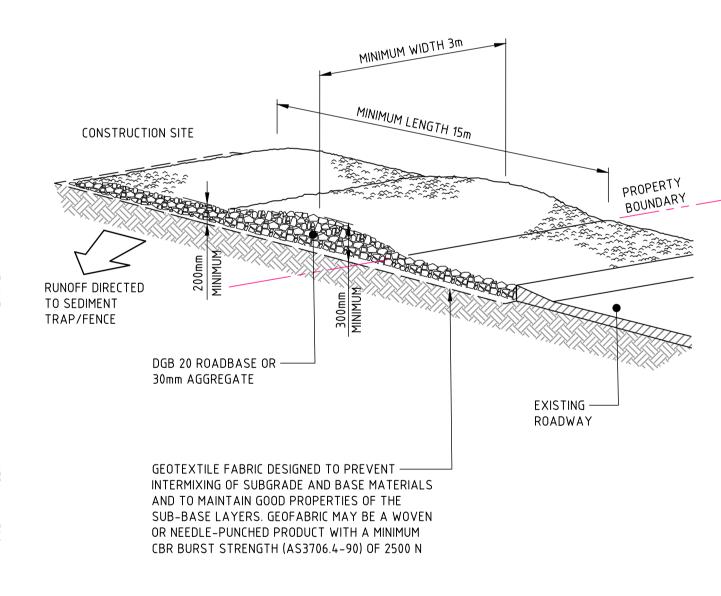

CONSTRUCTION NOTES

- STRIP THE TOPSOIL, LEVEL THE SITE AND COMPACT THE SUBGRADE.
- 2. COVER THE AREA WITH NEEDLE-PUNCHED GEOTEXTILE.
- 3. CONSTRUCT A 200mm THICK PAD OVER THE GEOTEXTILE USING ROAD BASE OR 30mm AGGREGATE. 4. ENSURE THE STRUCTURE IS AT LEAST 15 METRES LONG OR TO BUILDING ALIGNMENT AND AT LEAST 3 METRES
- 5. WHERE A SEDIMENT FENCE JOINS ONTO THE STABILISED ACCESS, CONSTRUCT A HUMP IN THE STABILISED ACCESS TO DIVERT WATER TO THE SEDIMENT FENCE.


SD6.14

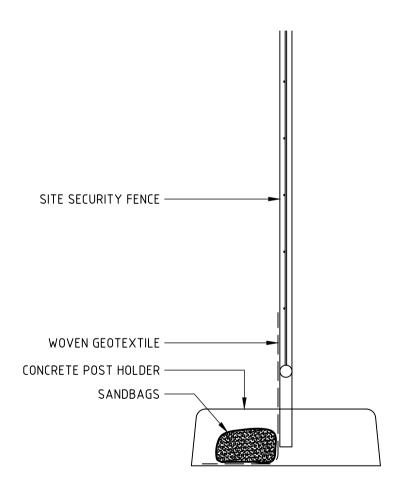

CONSTRUCTION NOTES

- PLACE SANDBAGS ALONG BASE OF FENCE ON TOP OF GEOTEXTILE.
- WIRE TIES OR AS RECOMMENDED BY THE MANUFACTURER. ONLY USE GEOTEXTILE SPECIFICALLY PRODUCED FOR SEDIMENT FENCING. THE USE OF SHADE CLOTH FOR THIS PURPOSE IS NOT SATISFACTORY.
- 3. JOIN SECTIONS OF FABRIC AT A SUPPORT POST WITH A 150mm OVERLAP.

SECURITY AND SEDIMENT FENCE - HARDSTAND AREAS

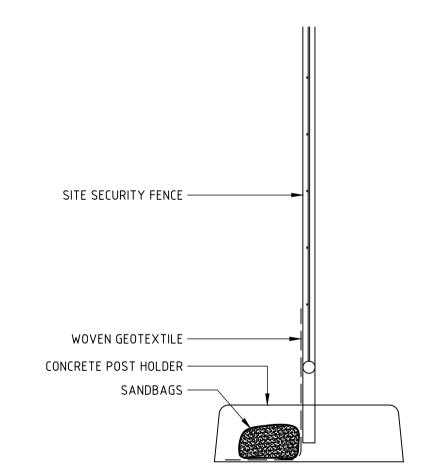

2. FIX SELF-SUPPORTING GEOTEXTILE TO THE UPSLOPE SIDE OF THE SECURITY FENCE. FIX THE GEOTEXTILE WITH

CHARLES STREET SQUARE

SEDIMENT AND EROSION CONTROL

NOT FOR CONSTRUCTION **DETAILS** DRAWING NUMBER

182116 REVISION

DRAWING SHEET SIZE = A1

STABILISED SITE ACCESS

REVISION	DESCRIPTION	ISSUED	VER'D	APP'D	DATE	T
1	DESIGN DEVELOPMENT ISSUED FOR QS REVIEW	J.P		T.H	24.04.20	l
2	ISSUED FOR REF	D.T		T.H	22.05.20	
						L
						l

City of Parramatta

DRAWING NOT TO BE USED FOR CONSTRUCTION UNLESS VERIFICATION

SPACKMAN MOSSOP == **MICHAELS**

THE COPYRIGHT OF THIS DRAWING REMAINS WITH NORTHROP

NORTHROP ACCEPTS NO RESPONSIBILITY FOR THE USABILITY, COMPLETENESS OR SCALE OF DRAWINGS
TRANSFERRED ELECTRONICALLY. 0.0 0.1 0.2 0.3 0.4 0.5n

COMMENCING WORK.


DIMENSIONS TO BE VERIFIED WITH THE ARCHITECT

AND ON SITE BEFORE MAKING SHOP DRAWINGS OF



Ph (02) 4226 3333 Fax (02) 4226 3666 P.O. Box 863, Wollongong, NSW 2500

Email southcoast@northrop.com.au ABN 81 094 433 100

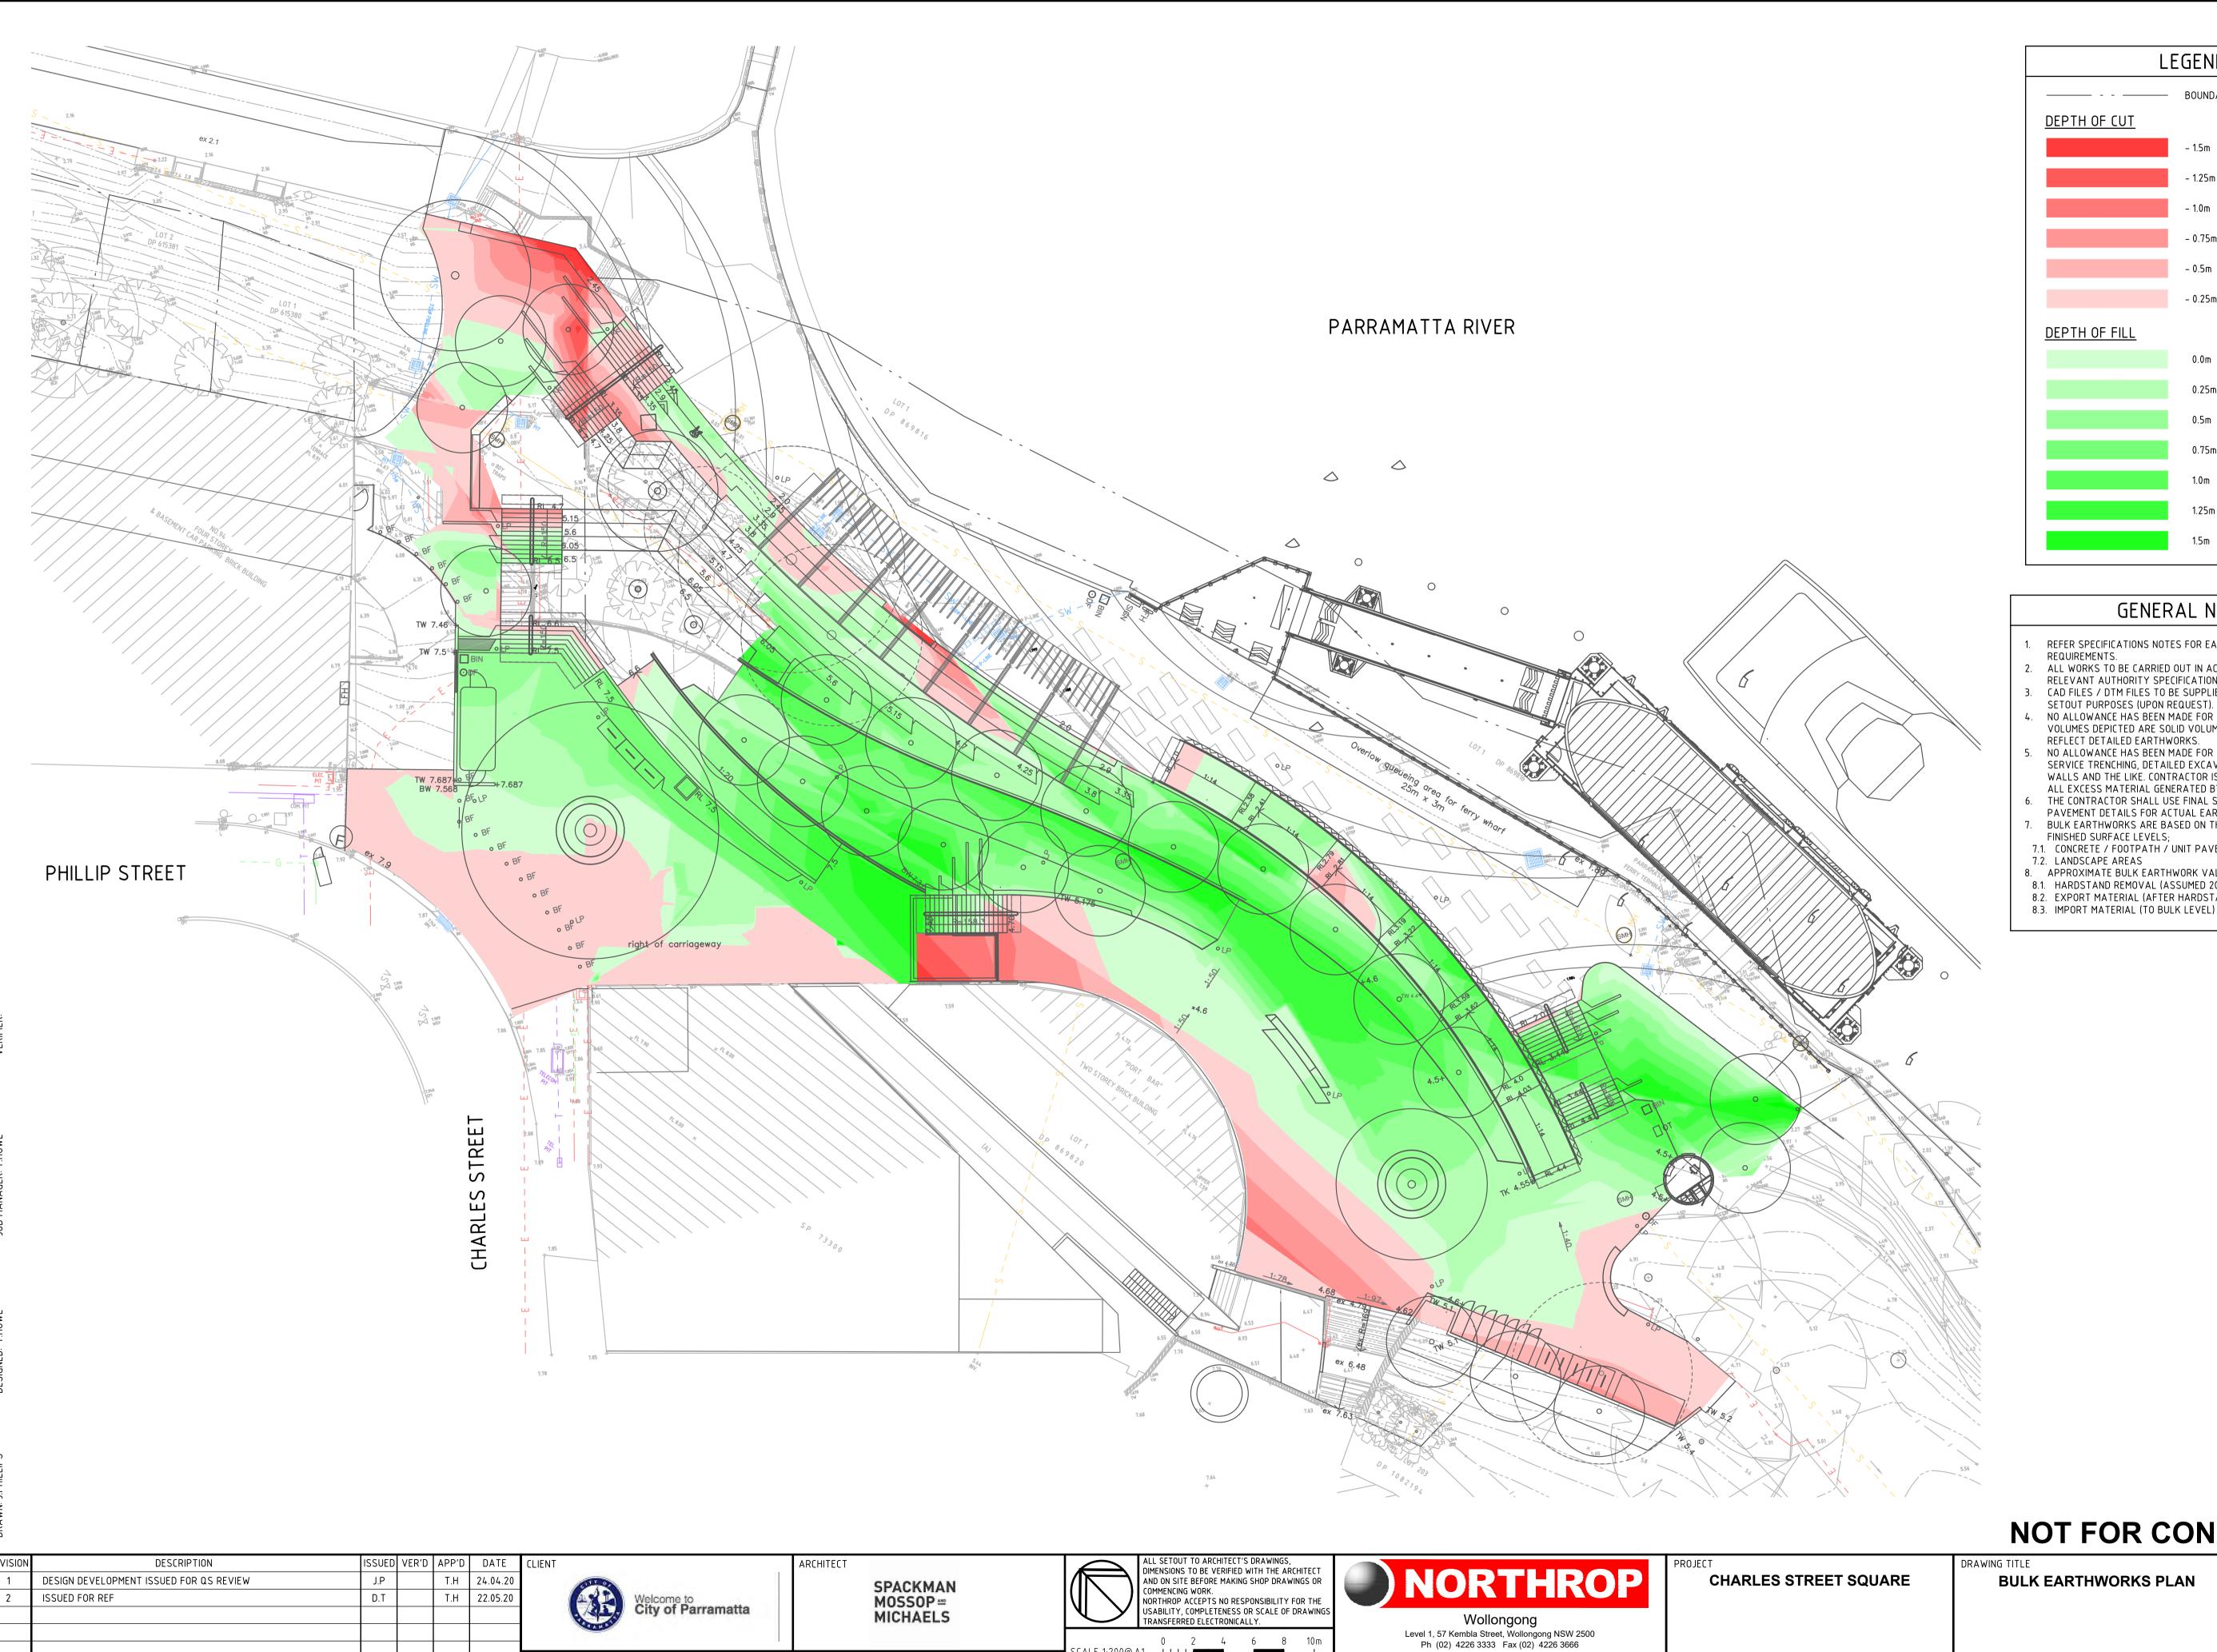




GENERAL NOTES:


- 1. REFER SPECIFICATIONS NOTES FOR EARTHWORKS GENERAL REQUIREMENTS.
- 2. ALL WORKS TO BE CARRIED OUT IN ACCORDANCE WITH COUNCIL /
- RELEVANT AUTHORITY SPECIFICATIONS AND DETAILS.
 3. CAD FILES / DTM FILES TO BE SUPPLIED IN AUTOCAD FORMAT FOR
- 4. NO ALLOWANCE HAS BEEN MADE FOR BULKING FACTORS. NOTE ALL VOLUMES DEPICTED ARE SOLID VOLUMES ONLY AND MAY NOT
- REFLECT DETAILED EARTHWORKS. NO ALLOWANCE HAS BEEN MADE FOR DETAILED EARTHWORKS; ie
- SERVICE TRENCHING, DETAILED EXCAVATION, FOOTINGS, RETAINING WALLS AND THE LIKE. CONTRACTOR IS TO ALLOW FOR REMOVAL OF ALL EXCESS MATERIAL GENERATED BY THE WORKS.
- THE CONTRACTOR SHALL USE FINAL SURFACE LEVELS AND TYPICAL PAVEMENT DETAILS FOR ACTUAL EARTHWORKS LEVELS.
- BULK EARTHWORKS ARE BASED ON THE FOLLOWING DEPTHS FROM
- FINISHED SURFACE LEVELS;
 7.1. CONCRETE / FOOTPATH / UNIT PAVERS 310mm
- 7.2. LANDSCAPE AREAS
- 8. APPROXIMATE BULK EARTHWORK VALUES AS FOLLOWS;
- 8.1. HARDSTAND REMOVAL (ASSUMED 200mm ACROSS SITE) 174 cu.m
- 8.2. EXPORT MATERIAL (AFTER HARDSTAND REMOVAL) 172 cu.m
- 8.3. IMPORT MATERIAL (TO BULK LEVEL) 992 cu.m

NOT FOR CONSTRUCTION

DRAWING NOT TO BE USED FOR CONSTRUCTION UNLESS VERIFICATION SIGNATURE HAS BEEN ADDED

THE COPYRIGHT OF THIS DRAWING REMAINS WITH NORTHROP

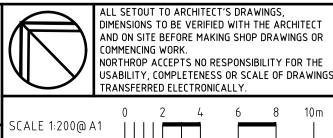

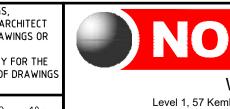


P.O. Box 863, Wollongong, NSW 2500
Email southcoast@northrop.com.au ABN 81 094 433 100


BULK EARTHWORKS PLAN


182116


DRAWING NUMBER

DRAWING SHEET SIZE = A1

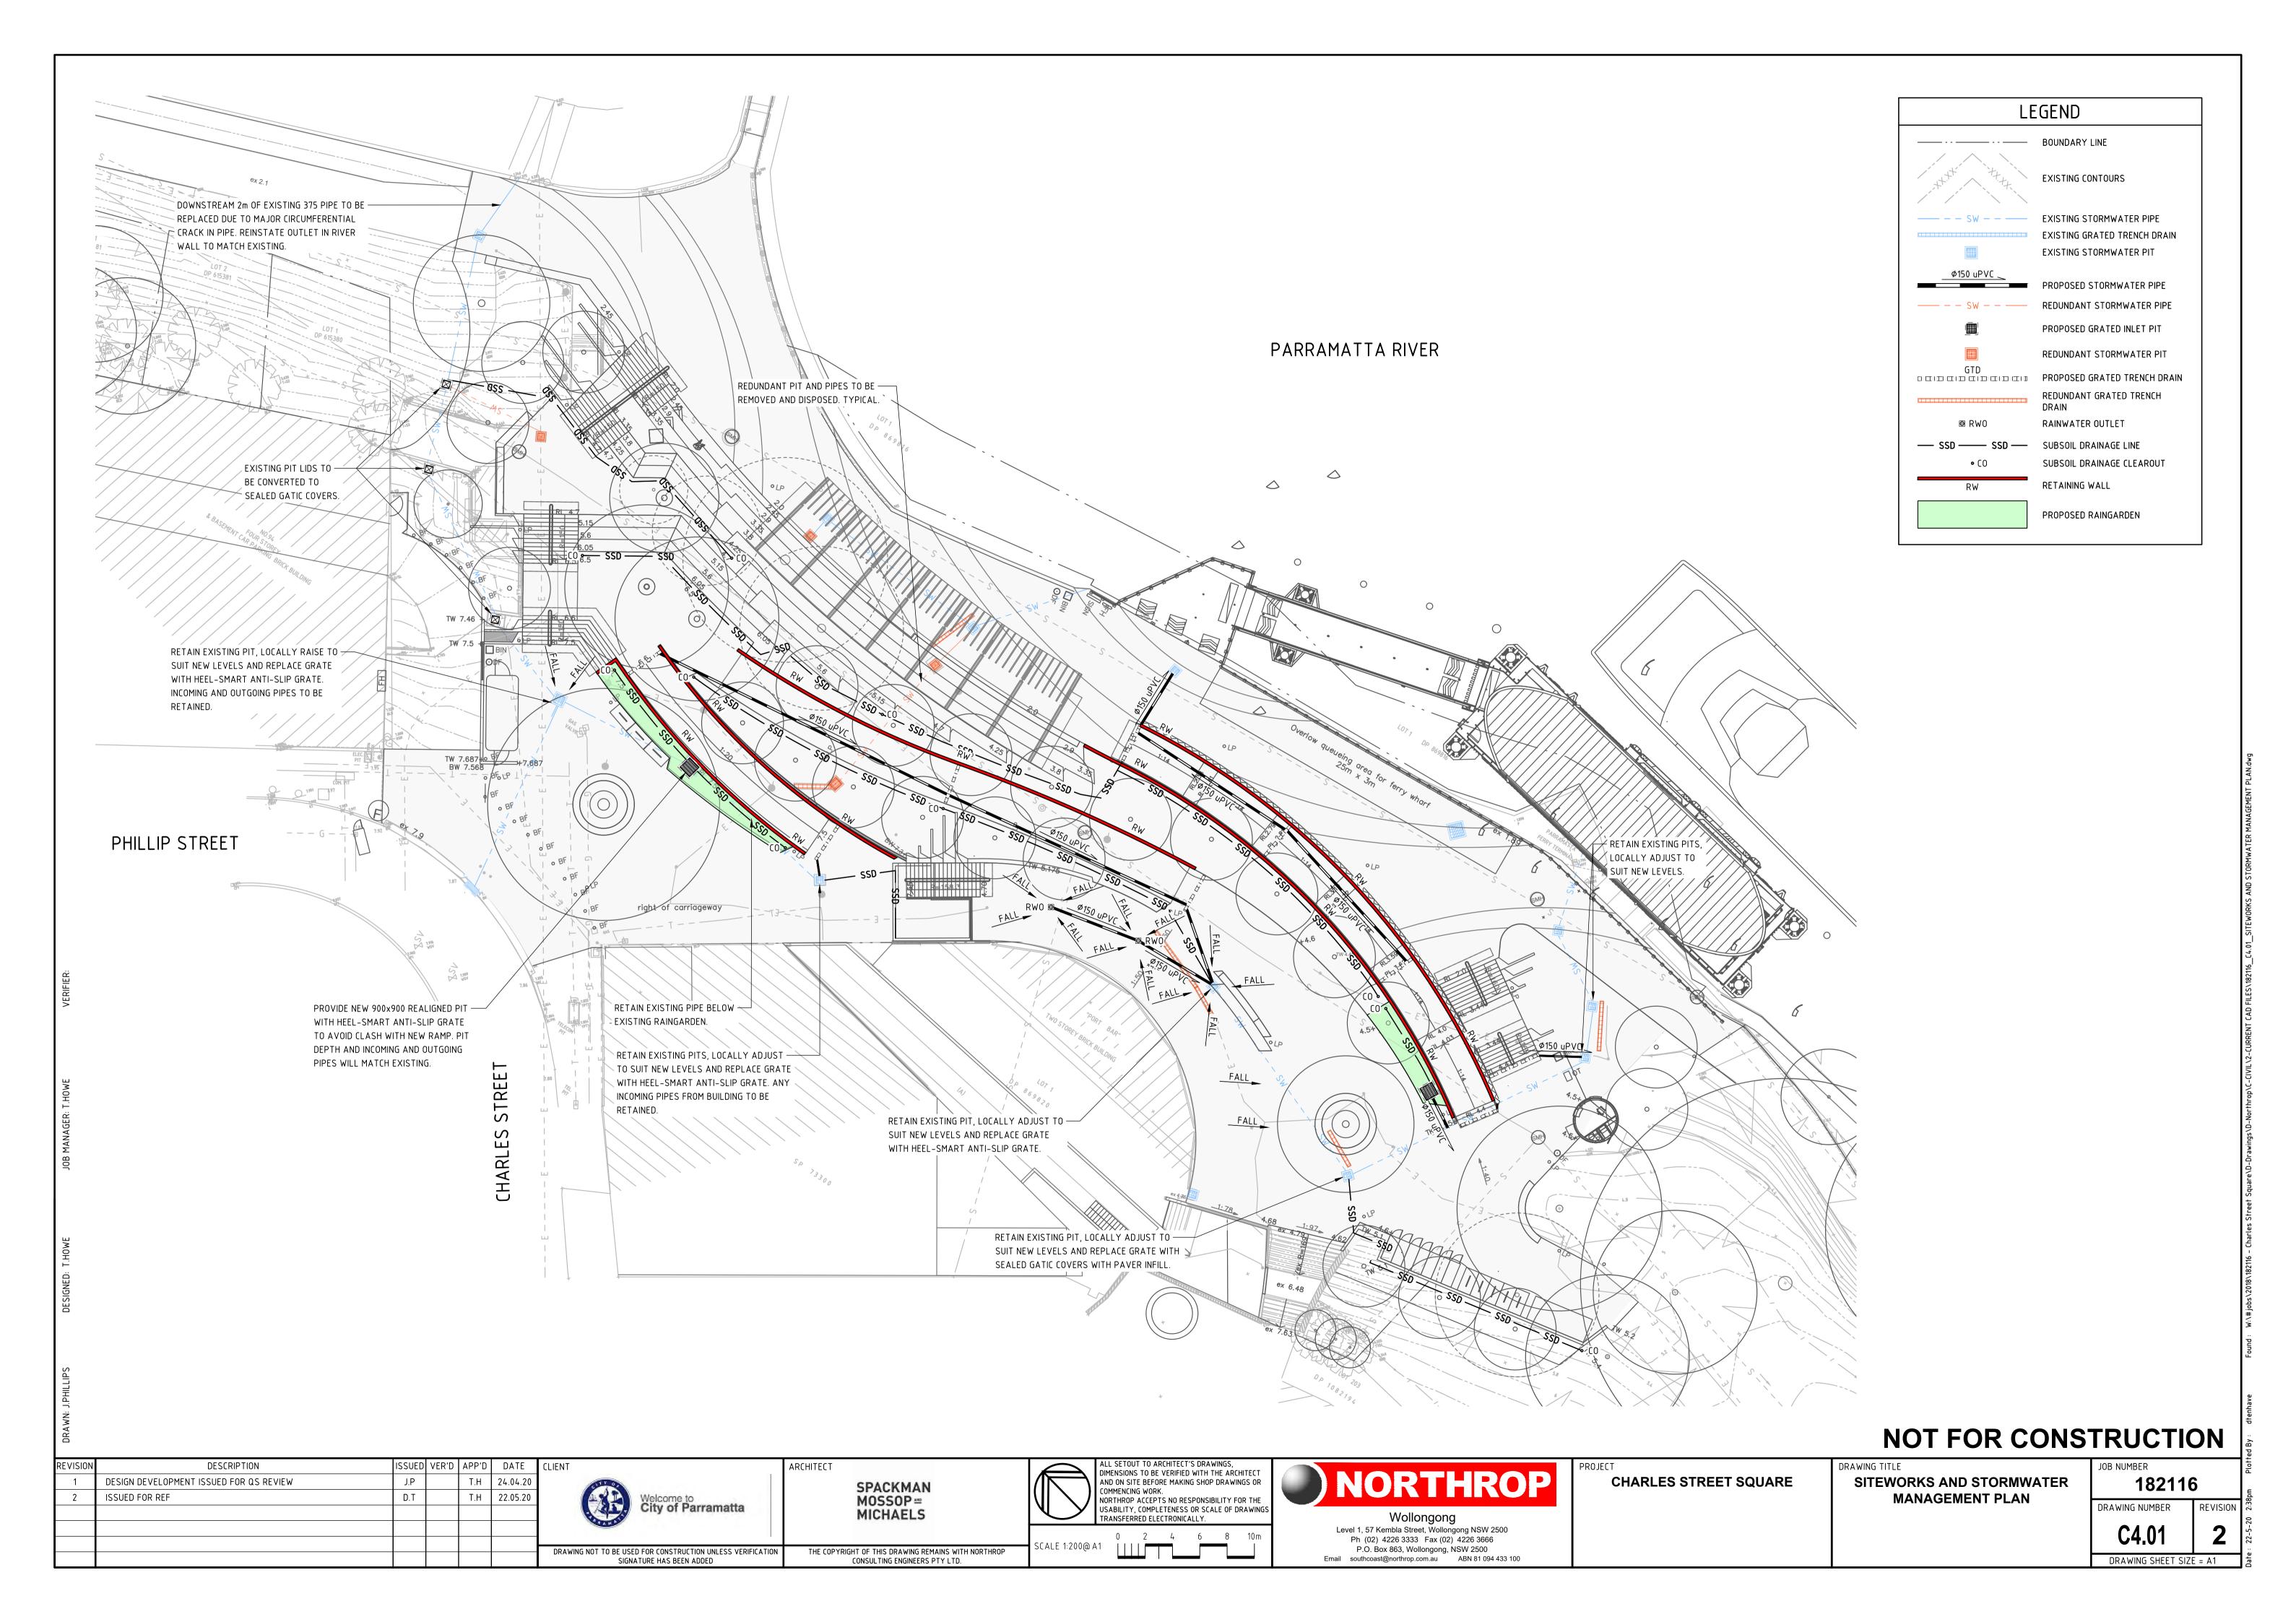

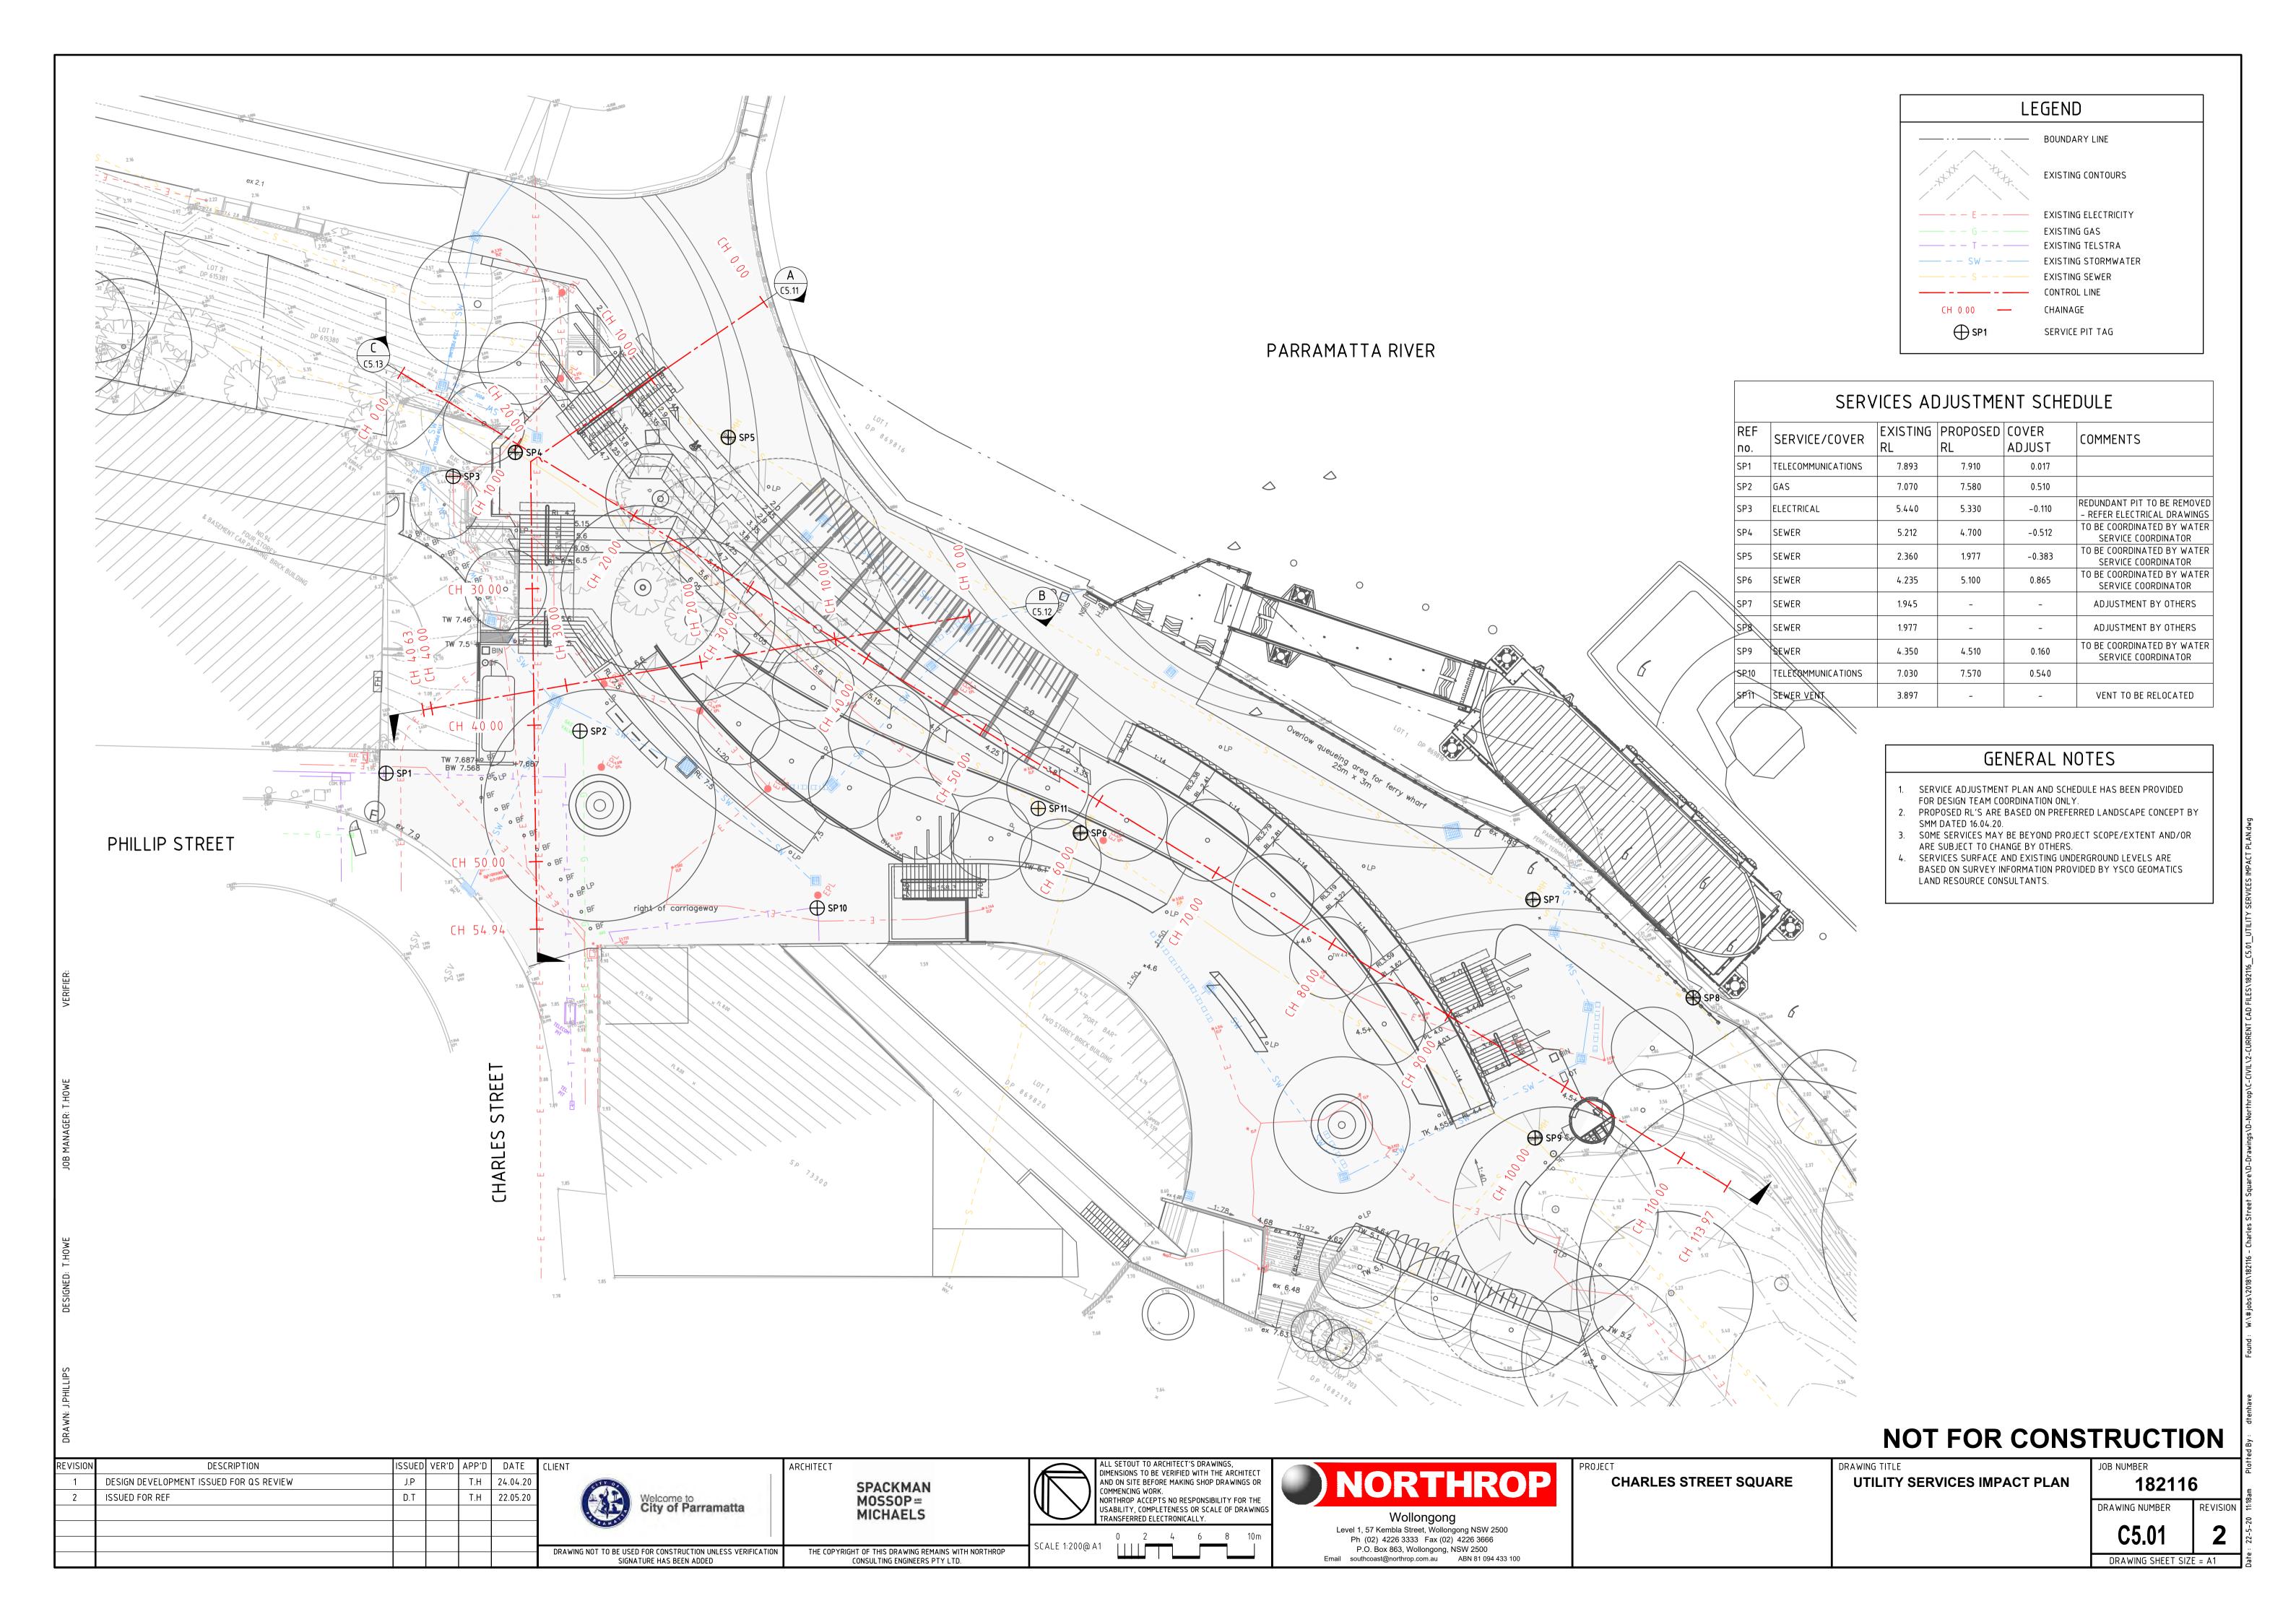

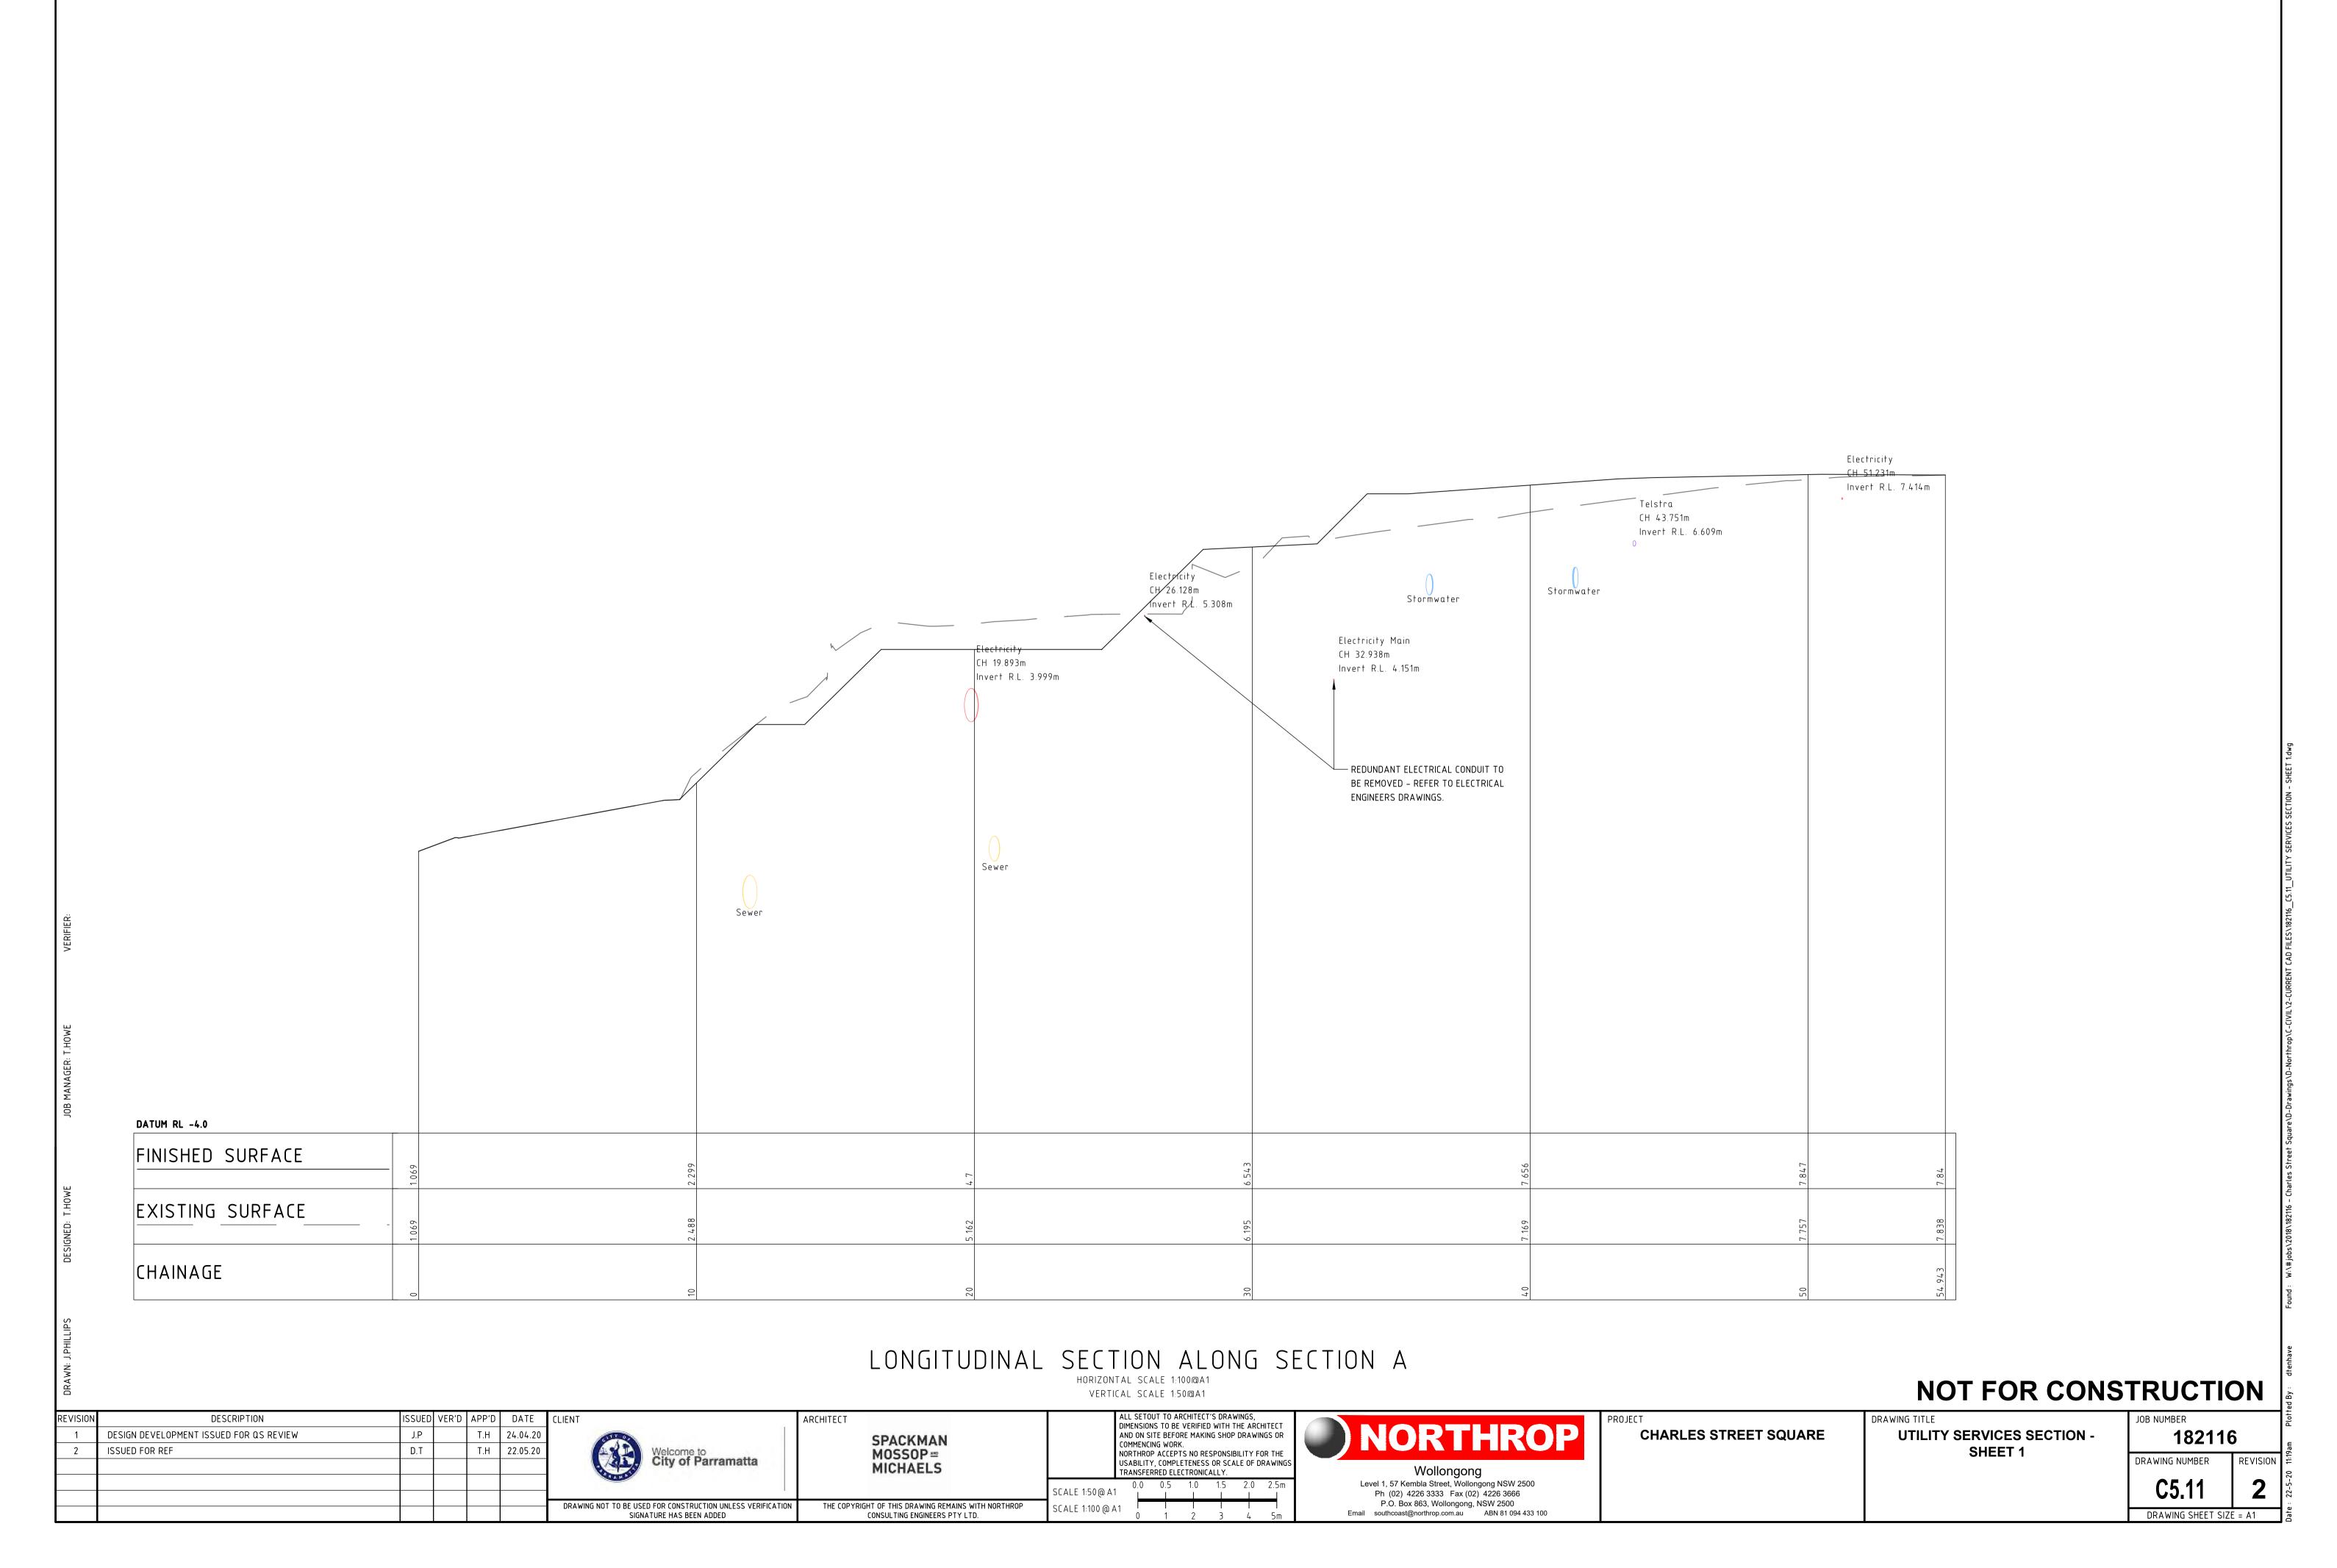

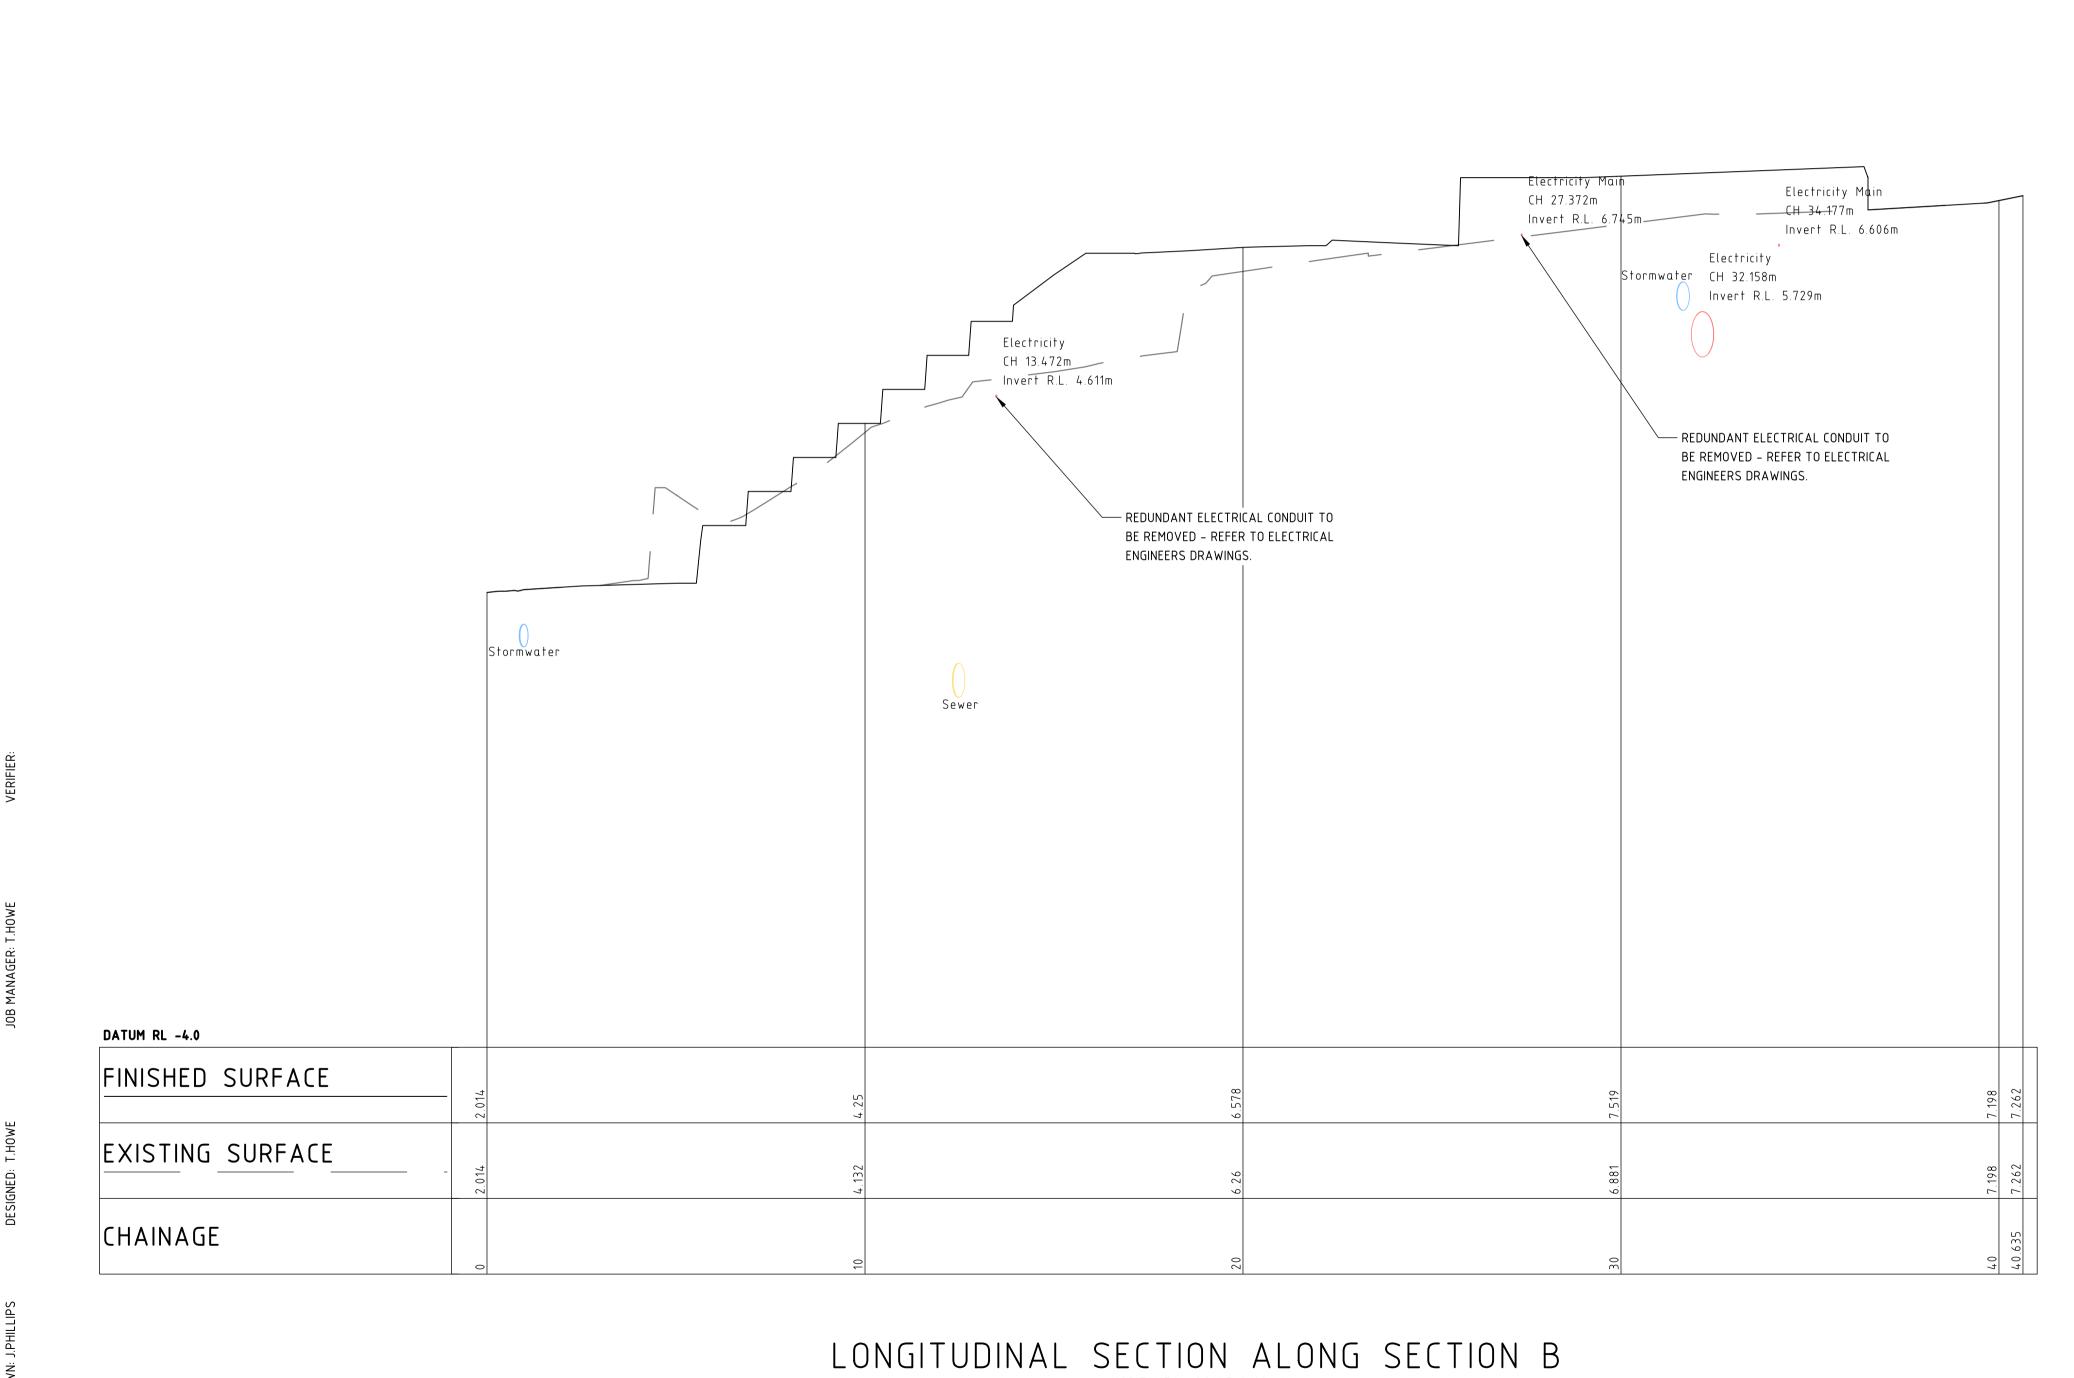

HORIZONTAL SCALE 1:100@A1 VERTICAL SCALE 1:50@A1

NOT FOR CONSTRUCTION

DESCRIPTION DESIGN DEVELOPMENT ISSUED FOR QS REVIEW T.H 24.04.20 ISSUED FOR REF T.H 22.05.20 Welcome to City of Parramatta

DRAWING NOT TO BE USED FOR CONSTRUCTION UNLESS VERIFICATION SIGNATURE HAS BEEN ADDED

SPACKMAN MOSSOP == MICHAELS THE COPYRIGHT OF THIS DRAWING REMAINS WITH NORTHROP CONSULTING ENGINEERS PTY LTD.

ALL SETOUT TO ARCHITECT'S DRAWINGS,
DIMENSIONS TO BE VERIFIED WITH THE ARCHITECT
AND ON SITE BEFORE MAKING SHOP DRAWINGS OR COMMENCING WORK. NORTHROP ACCEPTS NO RESPONSIBILITY FOR THE USABILITY, COMPLETENESS OR SCALE OF DRAWINGS TRANSFERRED ELECTRONICALLY. SCALE 1:100 @ A1



P.O. Box 863, Wollongong, NSW 2500
Email southcoast@northrop.com.au ABN 81 094 433 100

CHARLES STREET SQUARE


UTILITY SERVICES SECTION -SHEET 2

JOB NUMBER			
182116			
DRAWING NUMBER	RE		
C5.12			

DRAWING SHEET SIZE = A1

LONGITUDINAL SECTION ALONG SECTION C

VERTICAL SCALE 1:50@A1

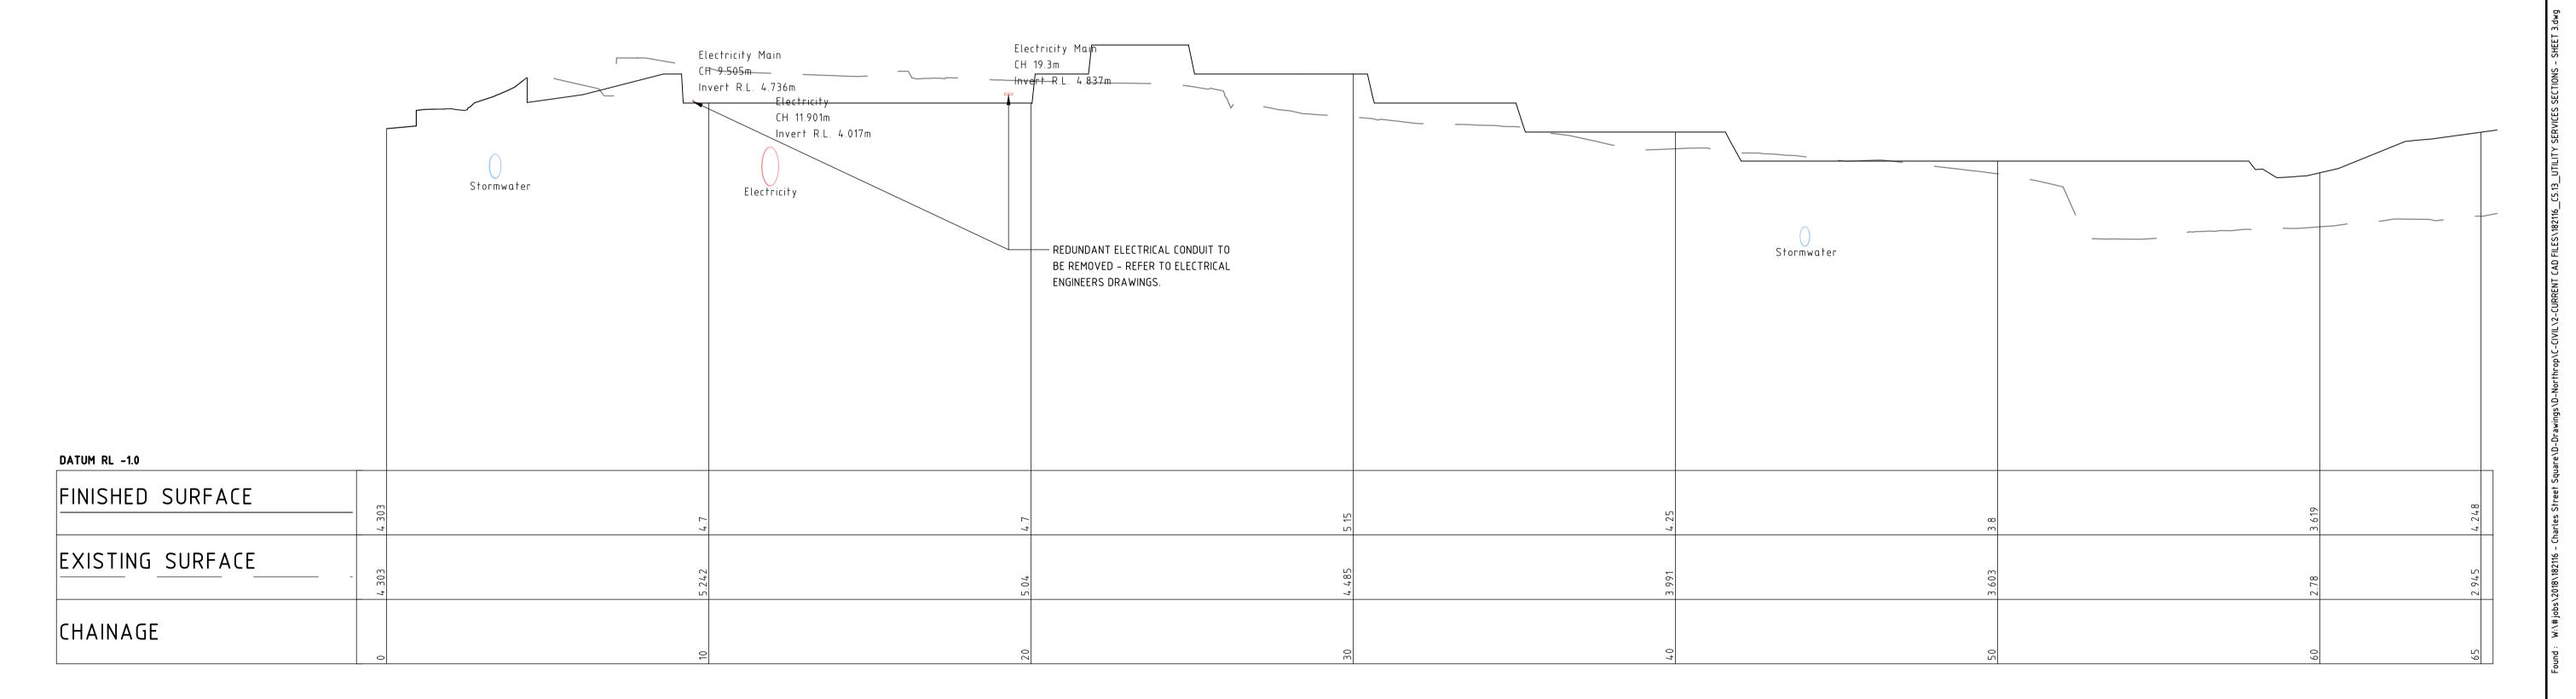

LONGITUDINAL SECTION ALONG SECTION C HORIZONTAL SCALE 1:100@A1

VERTICAL SCALE 1:50@A1

NOT FOR CONSTRUCTION

REVISION	DESCRIPTION	ISSUED \	VER'D APP'D DATE	CLIENT	ARCHITECT	ALL SETOUT TO ARCHITECT'S DRAWINGS, DIMENSIONS TO BE VERIFIED WITH THE ARCHITECT		PROJECT	DRAWING TITLE	JOB NUMBER	
1	DESIGN DEVELOPMENT ISSUED FOR QS REVIEW	J.P	T.H 24.04.20	OTT 03	SPACKMAN	AND ON SITE BEFORE MAKING SHOP DRAWINGS OR	NORTHROP	CHARLES STREET SQUARE	UTILITY SERVICES SECTION -	182116	6
2	ISSUED FOR REF	D.T	T.H 22.05.20	Welcome to	MOSSOP ==	COMMENCING WORK. NORTHROP ACCEPTS NO RESPONSIBILITY FOR THE	THO IT I III TO		SHEET 3		T DEVUSION
				City of Parramatta	MICHAELS	USABILITY, COMPLETENESS OR SCALE OF DRAWINGS TRANSFERRED ELECTRONICALLY.	Wollongong			DRAWING NUMBER	REVISION
						SCALE 1:50 @ A1	Level 1, 57 Kembla Street, Wollongong NSW 2500			C5 13	1 2
				DRAWING NOT TO BE USED FOR CONSTRUCTION UNLESS VERIFICATION	THE COPYRIGHT OF THIS DRAWING REMAINS WITH NORTHROP		Ph (02) 4226 3333 Fax (02) 4226 3666 P.O. Box 863, Wollongong, NSW 2500			65.15	_
				SIGNATURE HAS BEEN ADDED	CONSULTING ENGINEERS PTY LTD.	SCALE 1:100 @ A1	Email southcoast@northrop.com.au ABN 81 094 433 100			DRAWING SHEET SIZE	∠E = A1