


PARRAMATTA CIVIC LINK - PHILLIP STREET WORKS

100% DETAILED DESIGN
CITY OF PARRAMATTA

DRAWING SCHEDULE

DRAWING NUMBER	DESCRIPTION
GENERAL	
CL3-AAP-DD-PS-DRG-CI-0001	COVER SHEET AND DRAWING LIST
CL3-AAP-DD-PS-DRG-CI-0021	GENERAL NOTES
CL3-AAP-DD-PS-DRG-CI-0061	GENERAL ARRANGEMENT PLAN
CL3-AAP-DD-PS-DRG-CI-0081	DEMOLITION PLAN
EARTHWORKS	
CL3-AAP-DD-PS-DRG-CI-0101	EARTHWORKS PLAN
CL3-AAP-DD-PS-DRG-CI-0121	EARTHWORKS SITE SECTIONS
CL3-AAP-DD-PS-DRG-CI-0171	EROSION AND SEDIMENT CONTROL PLAN
CL3-AAP-DD-PS-DRG-CI-0191	EROSION AND SEDIMENT CONTROL DETAILS
ROADWORKS AND DRAINAGE	
CL3-AAP-DD-PS-DRG-CI-0201	CIVIL WORKS PLAN
CL3-AAP-DD-PS-DRG-CI-0221	ROAD CONTROL SETOUT PLAN
CL3-AAP-DD-PS-DRG-CI-0241	TYPICAL ROAD SECTIONS
CL3-AAP-DD-PS-DRG-CI-0251	ROAD LONGITUDINAL SECTIONS
CL3-AAP-DD-PS-DRG-CI-0281	ROAD CROSS SECTIONS
CL3-AAP-DD-PS-DRG-CI-0311	KERB RETURNS SHEET 1
CL3-AAP-DD-PS-DRG-CI-0312	KERB RETURNS SHEET 2
CL3-AAP-DD-PS-DRG-CI-0341	PAVEMENT PLAN
CL3-AAP-DD-PS-DRG-CI-0351	SIGNAGE AND LINE MARKING PLAN
CL3-AAP-DD-PS-DRG-CI-0361	CIVIL WORKS DETAILS SHEET 1
CL3-AAP-DD-PS-DRG-CI-0362	CIVIL WORKS DETAILS SHEET 2
CL3-AAP-DD-PS-DRG-CI-0401	STORMWATER PLAN
CL3-AAP-DD-PS-DRG-CI-0421	CATCHMENT PLAN
CL3-AAP-DD-PS-DRG-CI-0441	STORMWATER LONGITUDINAL SECTIONS
CL3-AAP-DD-PS-DRG-CI-0471	PIT SCHEDULE
CL3-AAP-DD-PS-DRG-CI-0481	STORMWATER DETAILS SHEET 1
CL3-AAP-DD-PS-DRG-CI-0482	STORMWATER DETAILS SHEET 2
CL3-AAP-DD-PS-DRG-CI-0483	STORMWATER DETAILS SHEET 3

SERVICES	
CL3-AAP-DD-PS-DRG-CI-0501	COMBINED UTILITIES PLAN
CL3-AAP-DD-PS-DRG-CI-0511	UTILITIES REGISTER PLAN
CL3-AAP-DD-PS-DRG-CI-0521	UTILITIES REGISTER
CL3-AAP-DD-PS-DRG-CI-0701	LIGHTING PLAN
CL3-AAP-DD-PS-DRG-CI-0711	LIGHTING DETAILS SHEET 1
CL3-AAP-DD-PS-DRG-CI-0712	LIGHTING DETAILS SHEET 2
CL3-AAP-DD-PS-DRG-CI-0713	LIGHTING DETAILS SHEET 3
CL3-AAP-DD-PS-DRG-CI-0714	LIGHTING DETAILS SHEET 4
CL3-AAP-DD-PS-DRG-CI-0715	LIGHTING DETAILS SHEET 5
CL3-AAP-DD-PS-DRG-CI-0721	LIGHTING SCHEDULE
CL3-AAP-DD-PS-DRG-CI-0731	ISOLUX PLAN

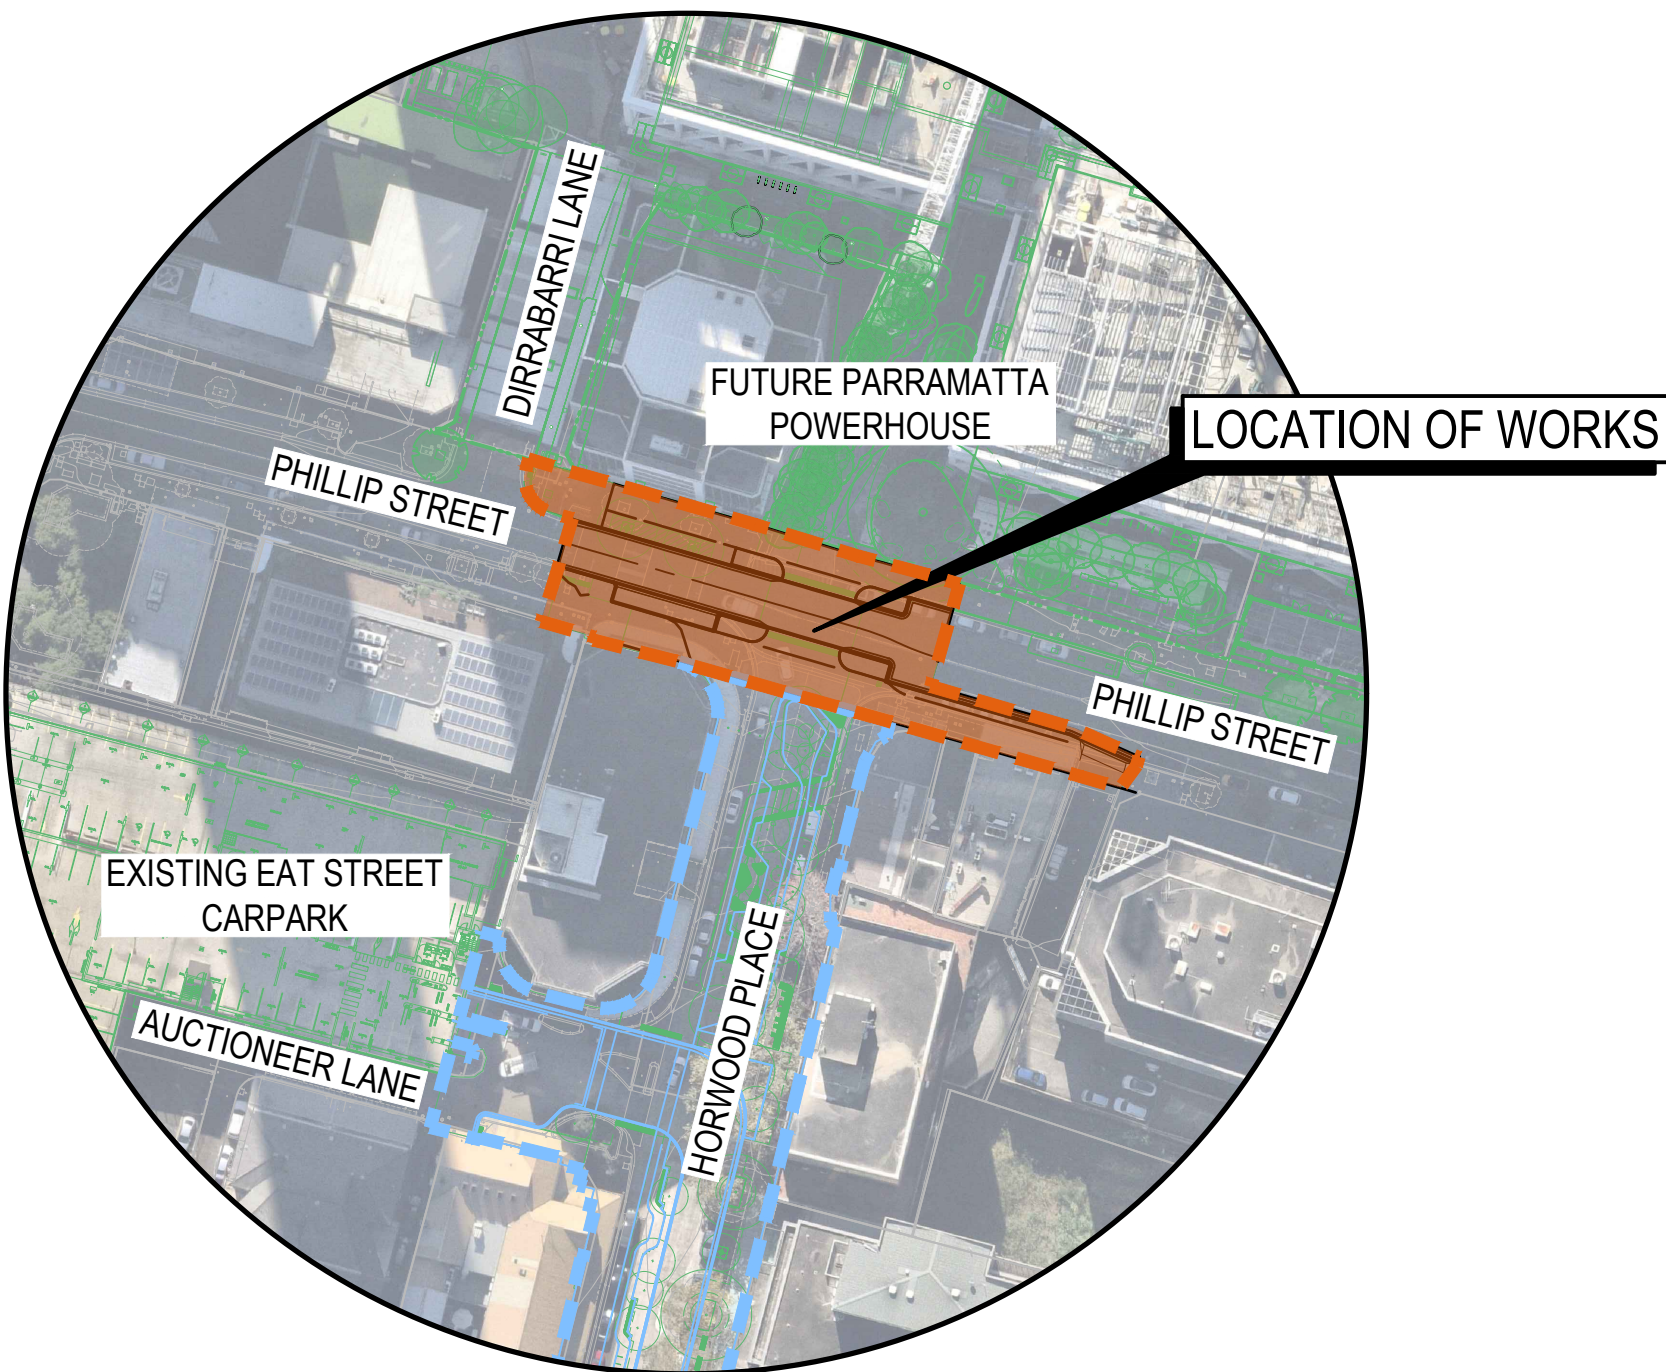

03	ISSUED FOR INFORMATION - 100% DETAILED DESIGN	RS	SG	GD	03.10.2025
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01	ISSUED FOR INFORMATION - 80% DETAILED DESIGN	RS	CR	MK	18.07.2025
Issue	Description	DR	CH	VE	Date

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Scales

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100m

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Surveyor

surveyplus

DURKIN

Architect

OCULUS

Client

CITY OF PARRAMATTA

Status			
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Original Issue Signatures			
Drawn	R. SANTOS	Original Size	A1
Designed	L. CORSCADDEN	Height Datum	AHD
Project Manager	S. GEERDINK	Grid	MGA/20-56
Verified	G. DUNSTAN		

Project

PARRAMATTA CIVIC LINK
PHILLIP STREET WORKS

COVER SHEET
AND DRAWING LIST

ARCADIS

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Project Number

30286862

Issue

03

Drawing No.

CL3-AAP-DD-PS-DRG-CI-0001

Date Plotted: 3 Oct 2025 - 06:00pm File Name: C:\Users\santosa4171\DC\ACCDocs\Arcadis ACC AU\AAU-30286862-Parramatta Civic Link Block 3\Project Files\110_WIP\110_Civil\STG_Phillip Street\DRG\CL3-AAP-DD-PS-DRG-CI-0001-CoverSheetAndDrawingList.dwg

1. THESE DRAWINGS SHALL BE READ IN CONJUNCTION WITH RELEVANT AUSTRALIAN STANDARDS, OTHER CONSULTANTS DRAWINGS AND SPECIFICATIONS AND WITH SUCH OTHER WRITTEN INSTRUCTIONS AS MAY BE ISSUED, DRAWINGS SUCH AS:
 - ASP3 A536471 ARP1918 Retic
 - OCULUS LANDSCAPE DRAWINGS
 - ASSOCIATED HORWOOD PLACE PACKAGES/DRAWINGS
2. ANY DISCREPANCIES OR OMISSIONS SHALL BE REFERRED TO THE SUPERINTENDENT FOR A DECISION BEFORE PROCEEDING WITH THE WORK.
3. ALL WORKMANSHIP AND MATERIALS SHALL COMPLY WITH THE BUILDING CODE OF AUSTRALIA AS AMENDED AND THE APPROPRIATE AND CURRENT AUSTRALIAN STANDARDS.
4. ALL DIMENSIONS ARE IN METRES UNLESS NOTED OTHERWISE.
5. DIMENSIONS SHALL NOT BE OBTAINED BY SCALING THE DRAWINGS.
6. ALL DIMENSIONS SHOWN ON THE DRAWINGS SHALL BE VERIFIED ON SITE BY THE BUILDER PRIOR TO CONSTRUCTION OR FABRICATION.
7. ALL WORKS TO BE CARRIED OUT IN ACCORDANCE WITH CODES OF PARAMATTATA CIVIL ENGINEERING DESIGN FOR DEVELOPMENT GUIDELINES, ENGINEERING CONSTRUCTION CODE AND STANDARD DRAWINGS. WHERE DISCREPANCIES OCCUR THE MORE STRINGENT SPECIFICATION WILL TAKE PRECEDENCE.
8. THE CONTRACTOR SHALL LOCATE AND LEVEL ALL EXISTING SERVICES PRIOR TO COMMENCING CONSTRUCTION AND SHALL MAKE ALL NECESSARY ARRANGEMENTS WITH THE RELEVANT AUTHORITY TO RELOCATE OR ADJUST AS REQUIRED. ALL COSTS TO BE BORNE BY THE APPLICANT. ADDITIONALLY WHERE DIRECTED BY AUTHORITY, CCTY SHOULD BE COMPLETED TO ASSESS CURRENT CONDITION OF ASSETS AND ALLOW AUTHORITY AN OPPORTUNITY TO INCLUDE REPLACEMENT AS A PART OF SCOPE.
9. THE CONTRACTOR SHALL NOT ENTER UPON OR DO ANY WORK WITHIN ADJACENT LAND WITHOUT PRIOR WRITTEN PERMISSION OF THE LAND OWNER.
10. THE CONTRACTOR SHALL OBTAIN A MINIMUM 48 HOURS NOTICE TO THE PRINCIPAL FOR ALL INSPECTIONS.
11. ALL CIVIL ENGINEERING DEVELOPMENT WORKS TO BE CONSTRUCTED IN ACCORDANCE WITH THE COUNCIL APPROVED WORKS CERTIFICATE CIVIL ENGINEERING DESIGN DRAWINGS. THE CIVIL ENGINEERING DESIGN DRAWINGS TAKE PRECEDENCE OVER ANY CIVIL DESIGN MODELS THAT MAY BE SUPPLIED TO THE CONTRACTOR DURING THE CONSTRUCTION PHASES.

2. ORIGIN OF LEVELS:- REFER SURVEY NOTES.
3. CONTRACTOR MUST VERIFY ALL DIMENSIONS AND EXISTING LEVELS ON SITE PRIOR TO COMMENCEMENT OF WORK. ANY DISCREPANCIES TO BE REPORTED TO THE SUPERINTENDENT.
4. MAKE SMOOTH CONNECTION WITH EXISTING WORKS.
5. ALL TRENCH BACKFILL MATERIAL SHALL BE COMPACTED TO THE SAME DENSITY AS THE ADJACENT MATERIAL.
5. ALL SERVICE TRENCHES UNDER VEHICULAR PAVEMENTS SHALL BE BACKFILLED IN ACCORDANCE WITH CITY OF PARAMMATA ENGINEERING DESIGN FOR DEVELOPMENT GUIDELINES AND HS3 BEDDING OR RELEVANT AUTHORITY STANDARD.
6. ALL BASE COURSE MATERIAL SHALL BE COMPACTED TO MINIMUM 98% MODIFIED DENSITY IN ACCORDANCE WITH AS 1289 5.2.1.
7. ALL SUB-BASE COURSE MATERIAL SHALL BE COMPACTED TO MINIMUM 100% SUBGRADE DENSITY IN ACCORDANCE WITH CITY OF PARAMMATA COUNCIL CONSTRUCTION OF SUBDIVISIONAL ROADS AND DRAINAGE WORKS SPECIFICATION AND AS 1289 5.2.1. BEFORE PLACING FILL, PROOF ROLL EXPOSED SUBGRADE WITH AN 12 TONNE (MN) DEADWEIGHT SMOOTH DRUM NON-VIBRATORY ROLLER TO DETECT THEN REMOVE SOFT SPOTS (AREAS WITH MORE THAN 2mm MOVEMENT UNDER ROLLER). SOFT SPOTS ARE TO BE REPLACED WITH SUITABLE SELECT FILL FOR A DEPTH OF AT LEAST 0.5m or AS ADVISED BY THE GEOTECHNICAL ENGINEER.
8. SELECT MATERIAL FOR BACKFILLING SHALL BE GRANULAR MATERIAL WHICH IS NATURALLY OCCURRING, HAVING A PARTICLE SIZE DISTRIBUTION DETERMINED IN ACCORDANCE WITH AS 1289 3.6.1. SELECT MATERIAL CAN BE CRUSHED ROCK, NATURAL SOIL, GRAVEL AND SAND, OR OTHER APPROVED GRANULAR MATERIAL CONSISTING OF CLEAN, SOUND, DURABLE FRAGMENTS, FREE FROM ORGANIC MATTER FROM AN APPROVED SOURCE. GRADING LIMITS FOR SELECT FILL SHALL BE IN ACCORDANCE WITH AS 3725 AND CITY OF PARAMMATA COUNCIL ENGINEERING DESIGN FOR DEVELOPMENT GUIDELINES.
9. ALL FREQUENCY OF COMPACTION TESTING SHALL BE IN ACCORDANCE WITH CITY OF PARAMMATA COUNCIL ENGINEERING OR RELEVANT AUSTRALIAN STANDARD.
10. FILL MATERIAL SHALL BE SPREAD IN LAYERS MAXIMUM 300mm THICK AND COMPACTED TO SPECIFICATION.
11. WHERE NOTED ON THE DRAWINGS THAT WORKS ARE TO BE CARRIED BY OTHERS, (e.g. ADJUSTMENT OF SERVICES), THE CONTRACTOR SHALL BE RESPONSIBLE FOR THE CO-ORDINATION OF THESE WORKS.

1. ALL CONCRETE TO HAVE A MINIMUM COMPRESSIVE STRENGTH OF 32MPa U.N.O IN REINFORCED CONCRETE NOTES.
2. ALL KERBS, GUTTERS, DISH DRAINS AND CROSSINGS TO BE CONSTRUCTED ON MIN. 175mm DGB20 COMPACTED TO MINIMUM 98% MODIFIED DRY DENSITY (AS 1289 5.2.1).
3. EXPANSION JOINTS (E.J) TO BE FORMED FROM 12mm COMPRESSIBLE JOINT FILLER BOARD FOR THE FULL DEPTH OF THE SECTION AND CUT TO PROFILE. EXPANSION JOINTS TO BE LOCATED AT DRAINAGE PITS, ON TANGENT POINTS OF CURVES AND ELSEWHERE AT MAX 6m CENTRES EXCEPT FOR INTEGRAL KERBS WHERE THE EXPANSION JOINTS ARE TO MATCH THE JOINT LOCATIONS IN THE SLABS.
4. THE WEAKENED PLANE JOINTS TO BE 3mm TO 5mm WIDE AND LOCATED AT 900mm CENTRES EXCEPT FOR INTEGRAL KERBS WHERE THE WEAKENED PLANE JOINTS ARE TO MATCH THE JOINT LOCATIONS IN THE SLABS.
5. LIGHT BROOM FINISH TO ALL FOOTPATHS, PRAM RAMPS AND DRIVEWAYS.
6. IN THE REPLACEMENT OF KERB AND GUTTER -
EXISTING ROAD PAVEMENT IS TO BE SAWCUT 900mm U.N.O FROM THE LIP OF GUTTER. UPON COMPLETION OF THE NEW KERB AND GUTTER NEW BASECOURSE AND SURFACE TO BE LAID 900mm WIDE U.N.O.
7. EXISTING KERB AND GUTTER IS TO BE COMPLETELY REMOVED WHERE NEW KERB AND GUTTER IS SHOWN.


1. ALL SIGNAGE TO BE IN ACCORDANCE WITH THE CURRENT VERSION OF THE TNSW REGULATORY SIGNS MANUAL.
2. FOR LAMP COLUMNS REFER TO DRAWINGS CL3-AAP-DD-PS-DRG-CI-0701 FOR THE PLAN AND CL3-AAP-DD-PS-DRG-CI-0711 TO 0721 FOR THE DETAILS.

1. DETAILED GROUND SURVEY WITHIN THE SITE AND BOUNDARIES WERE SUPPLIED BY SURVEYPLUS.
2. DETAILED UTILITIES AND STORMWATER SURVEY WITHIN THE SITE AND BOUNDARIES WERE SUPPLIED BY DURKIN.
3. THE INFORMATION IS SHOWN TO PROVIDE A BASIS FOR DESIGN. ARCADIS DOES NOT GUARANTEE THE ACCURACY OR COMPLETENESS OF THE SURVEY BASE OR ITS SUITABILITY AS A BASIS FOR CONSTRUCTION DRAWINGS.
4. SHOULD DISCREPANCIES BE ENCOUNTERED DURING CONSTRUCTION BETWEEN THE SURVEY DATA AND ACTUAL FIELD DATA, CONTACT ARCADIS.


1. A TRAFFIC CONTROL PLAN IF REQUIRED IS TO BE PREPARED AND LODGED WITH COUNCIL BY THE CONTRACTOR PRIOR TO COMMENCEMENT OF CONSTRUCTION.

1. ALL PEDESTRIAN PAVEMENTS ARE TO BE JOINED IN ACCORDANCE WITH CITY OF PARRAMATTA COUNCIL STANDARD DRAWING DS40.
2. WHERE POSSIBLE, JOINTS SHOULD BE LOCATED TO MATCH KERBING AND/OR ADJACENT PAVEMENT JOINTS.
3. PEDESTRIAN PAVEMENT JOINT LOCATIONS TO BE CONFIRMED BY PAVEMENT DESIGN FOLLOWING IN-SITU MATERIAL TESTING AND CITY OF PARRAMATTA COUNCIL ENGINEERING DESIGN CODE.
4. REFER TO LANDSCAPE ARCHITECTS PLANS FOR ALL OTHER PEDESTRIAN PAVEMENT JOINT SPECIFICATIONS.

1. PAVEMENT IS TO BE INSTALLED IN ACCORDANCE WITH CITY OF PARRAMATTA COUNCIL DCP GUIDELINES DRAWING DS40.
2. SUBSOIL DRAINAGE TO BE PROVIDED IN ACCORDANCE WITH CITY OF PARRAMATTA COUNCIL DCP GUIDELINES DRAWING DS33.

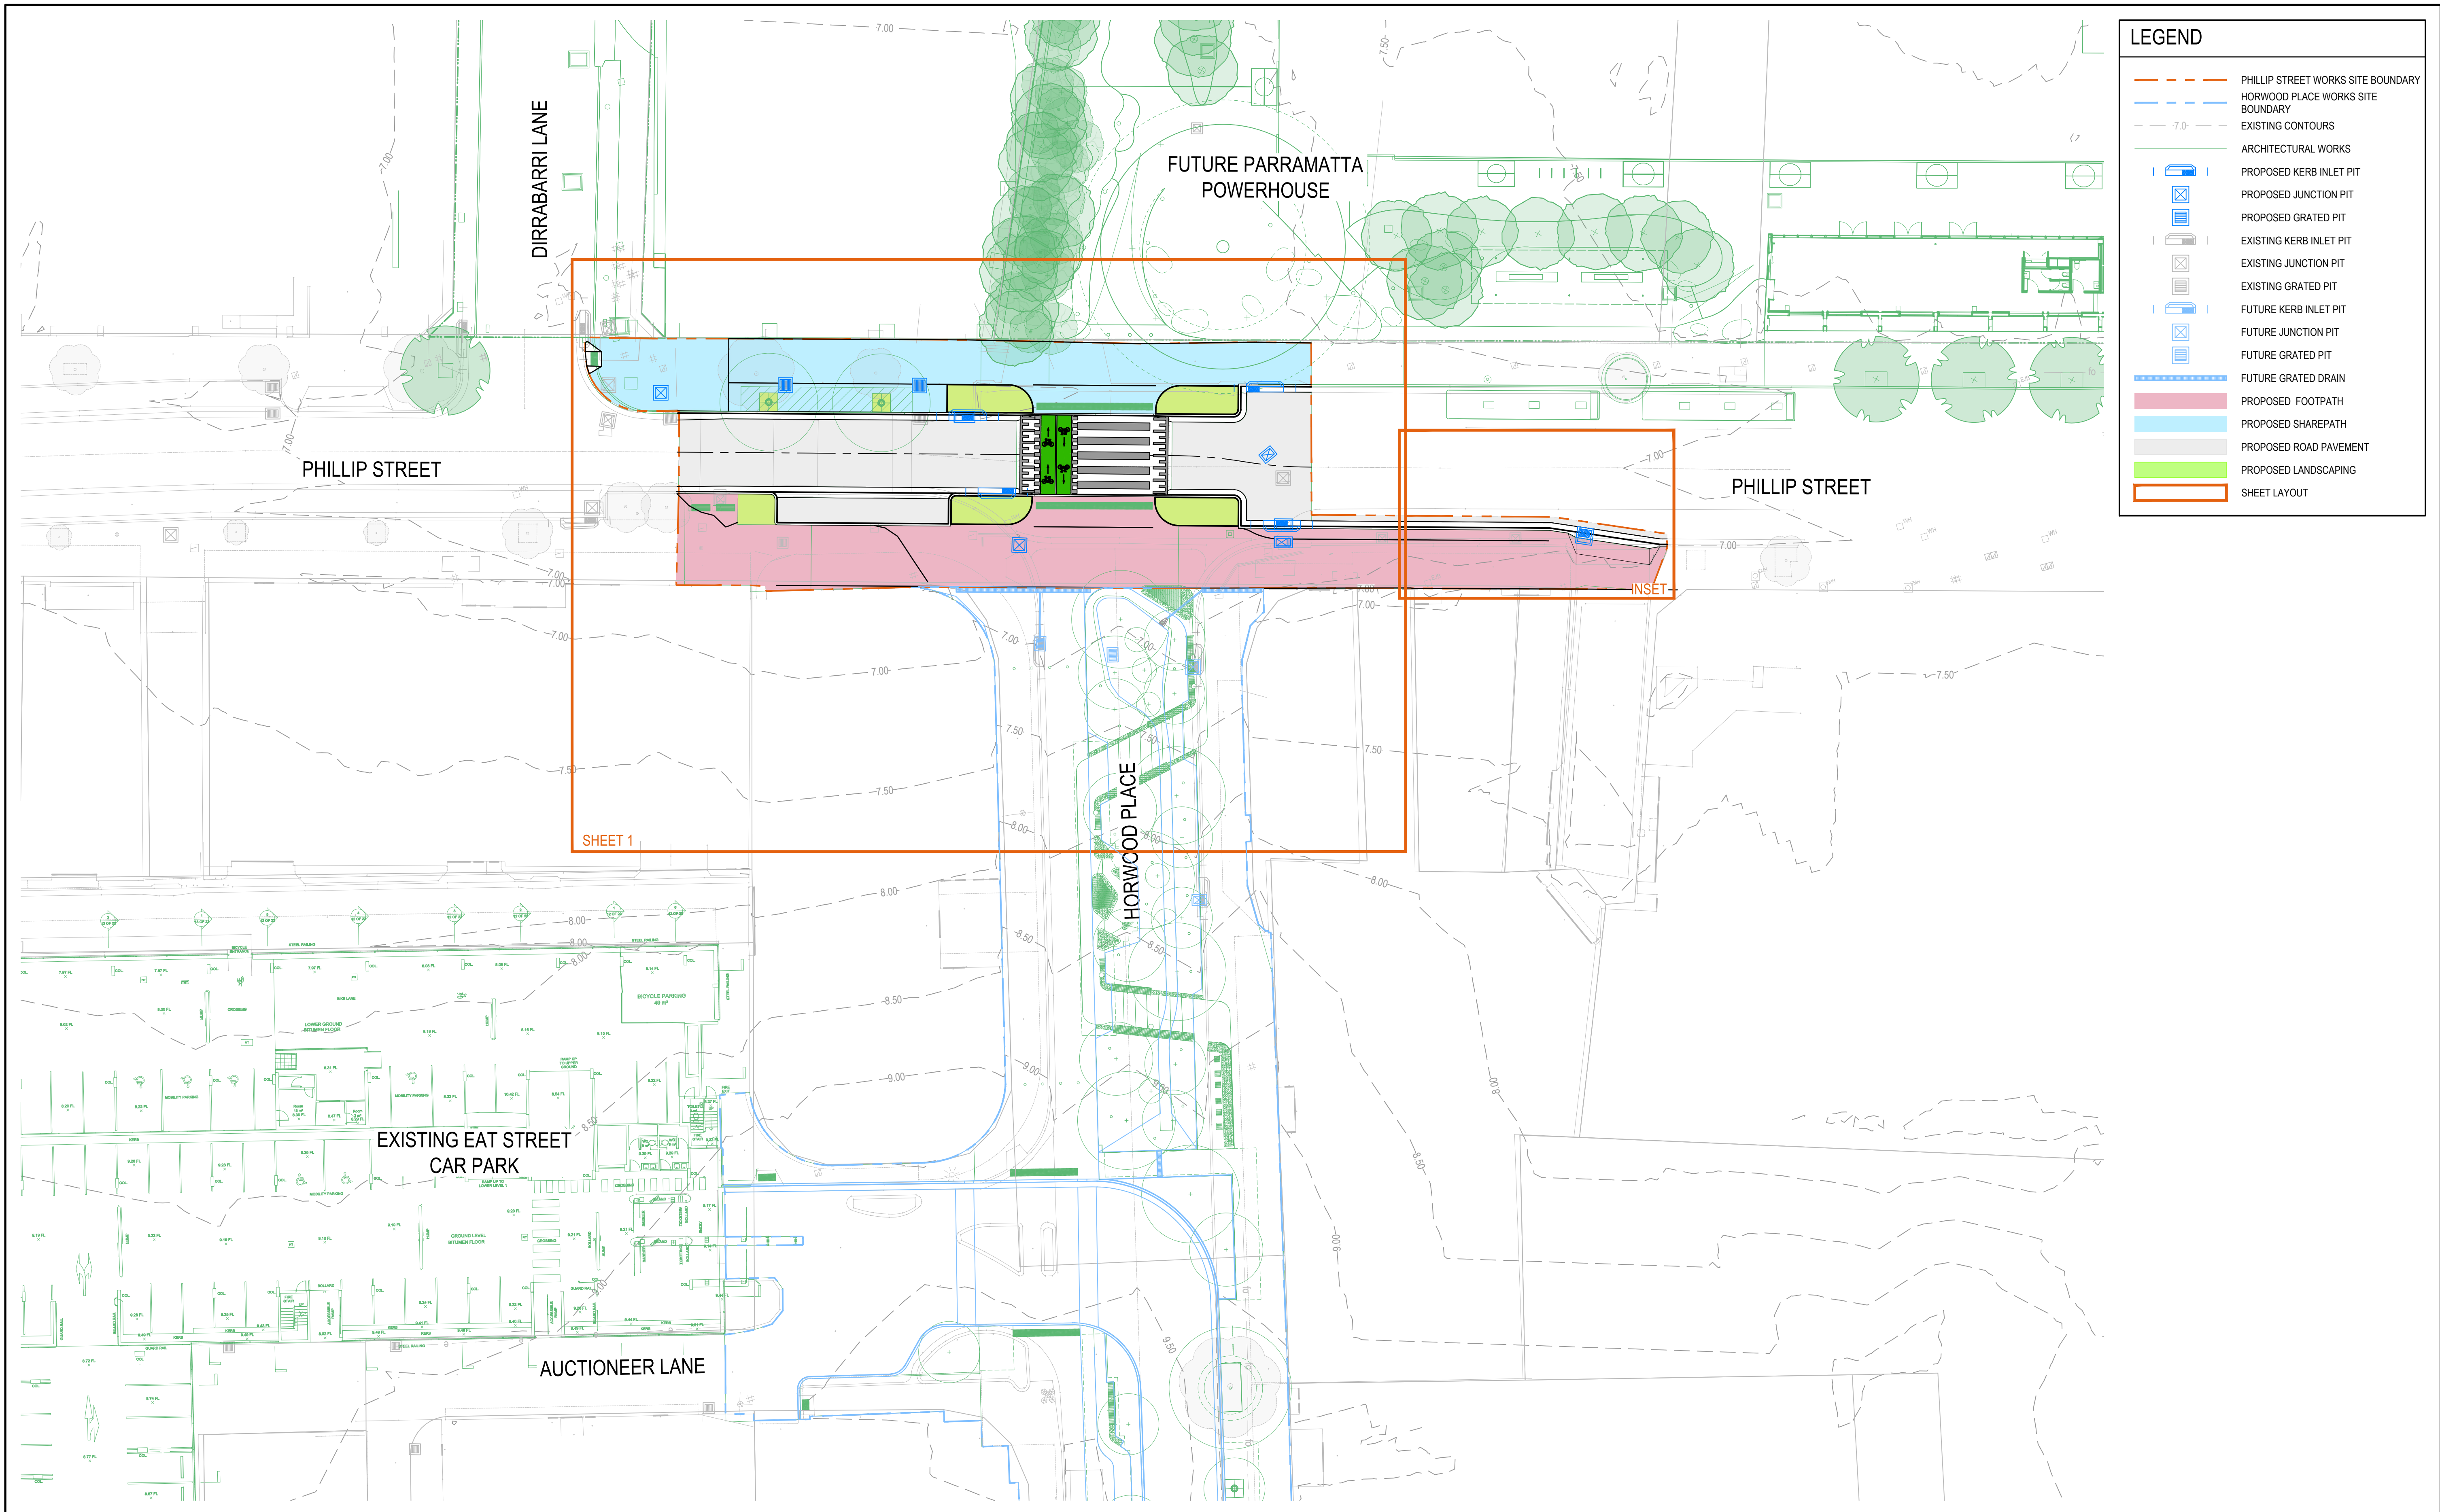

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Surveyor

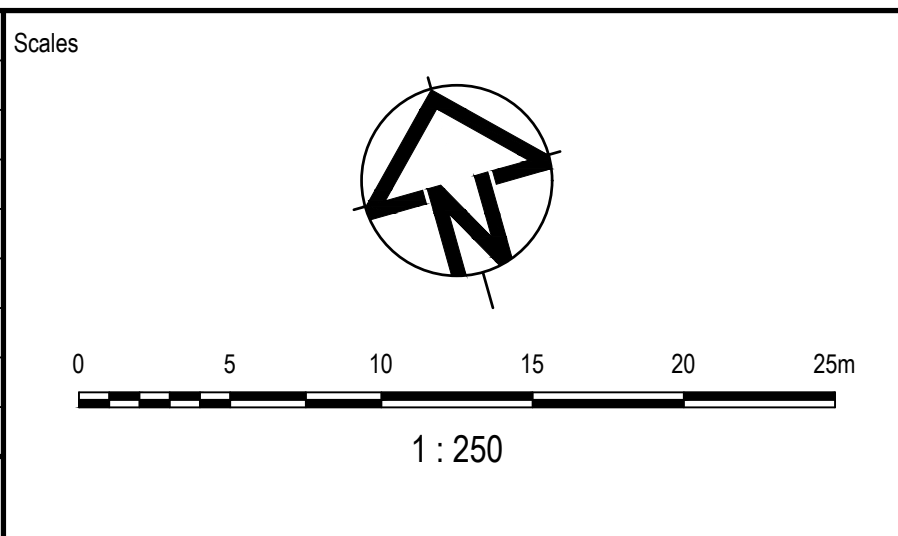Architect

Client


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Drawn	R. SANTOS	Original Size	A1
Designed	L. CORSCADEN	Height Datum	AHD
Project Manager	S. GEERDINK	Grid	MGA/20-56
Verified	G. DUNSTAN		


Project	PARRAMATTA CIVIC LINK PHILLIP STREET WORKS
Title	GENERAL ARRANGEMENT PLAN

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Project Number	30286862
Issue	03

CL3-AAP-DD-PS-DRG-CI-0061



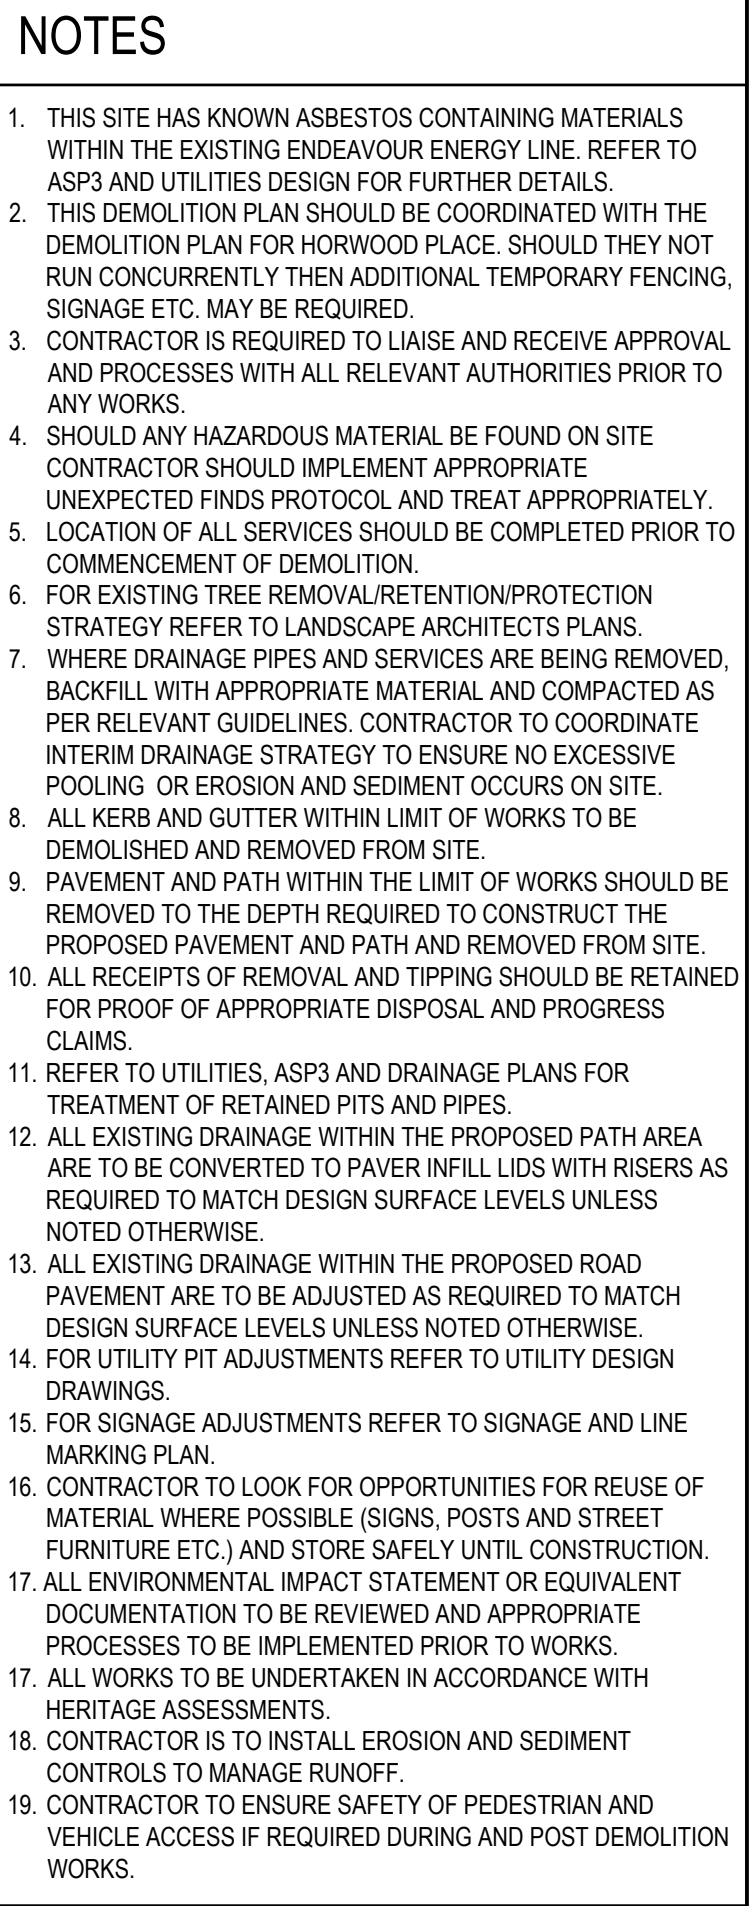

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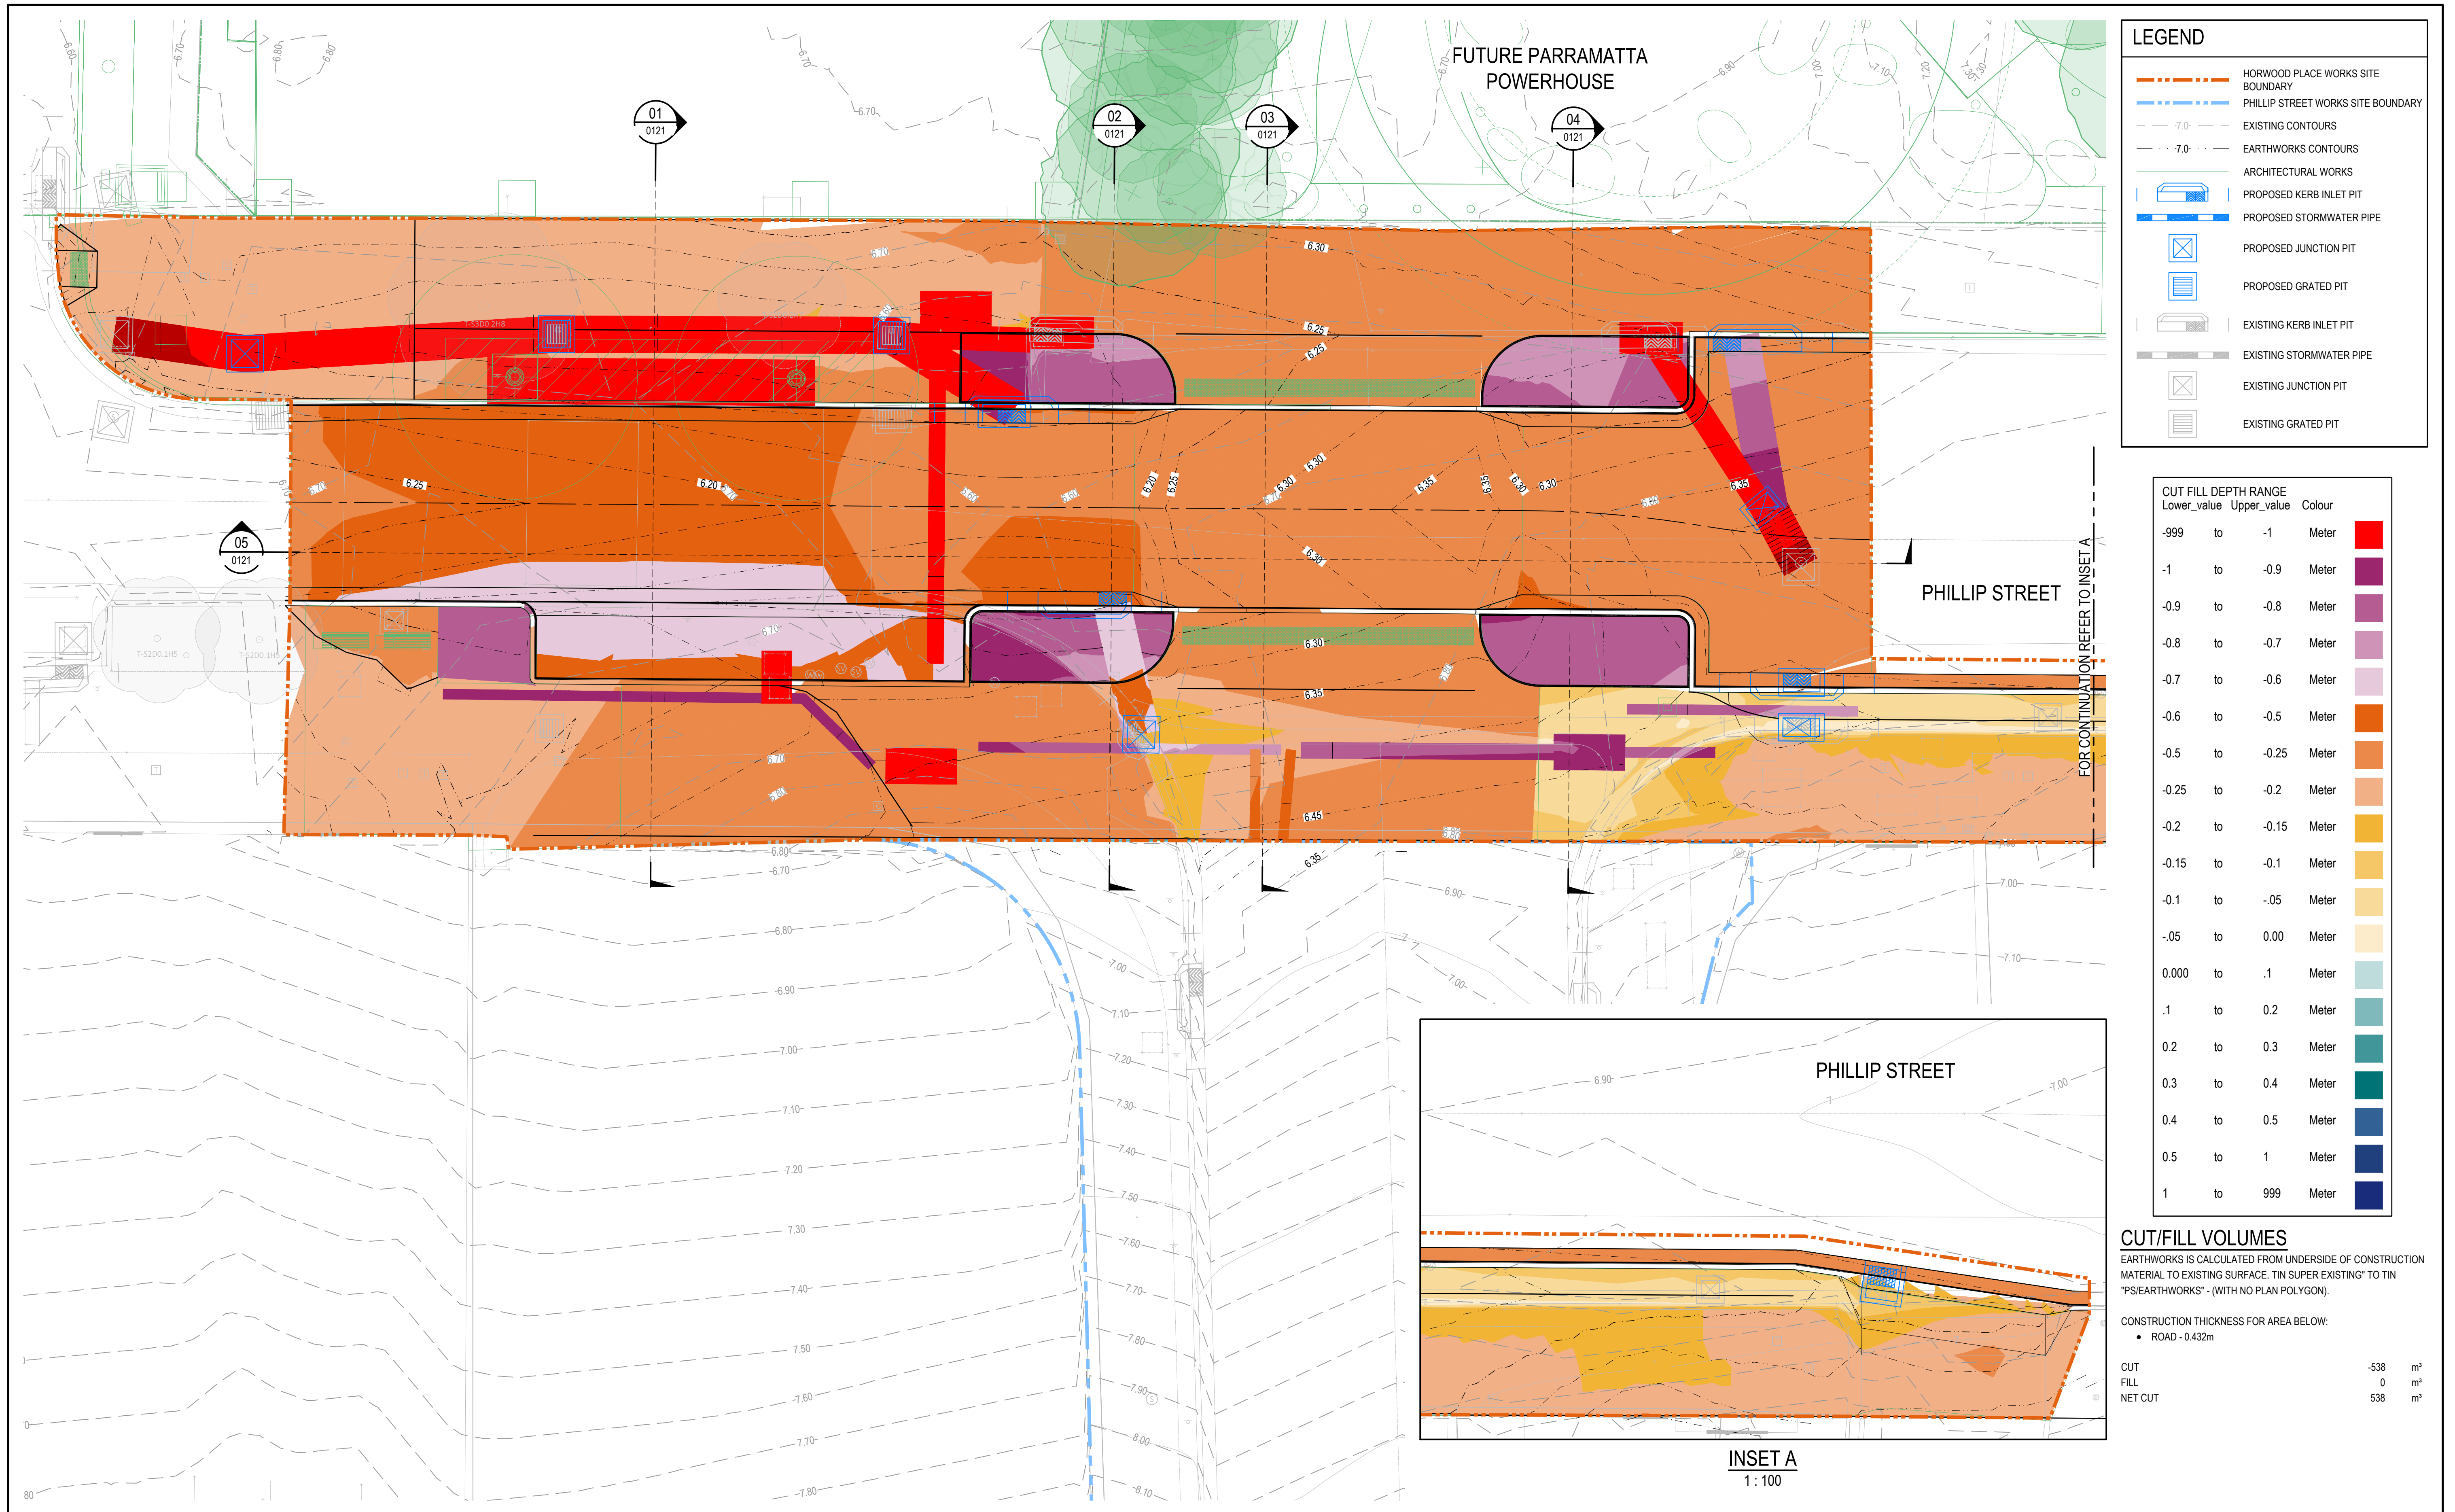
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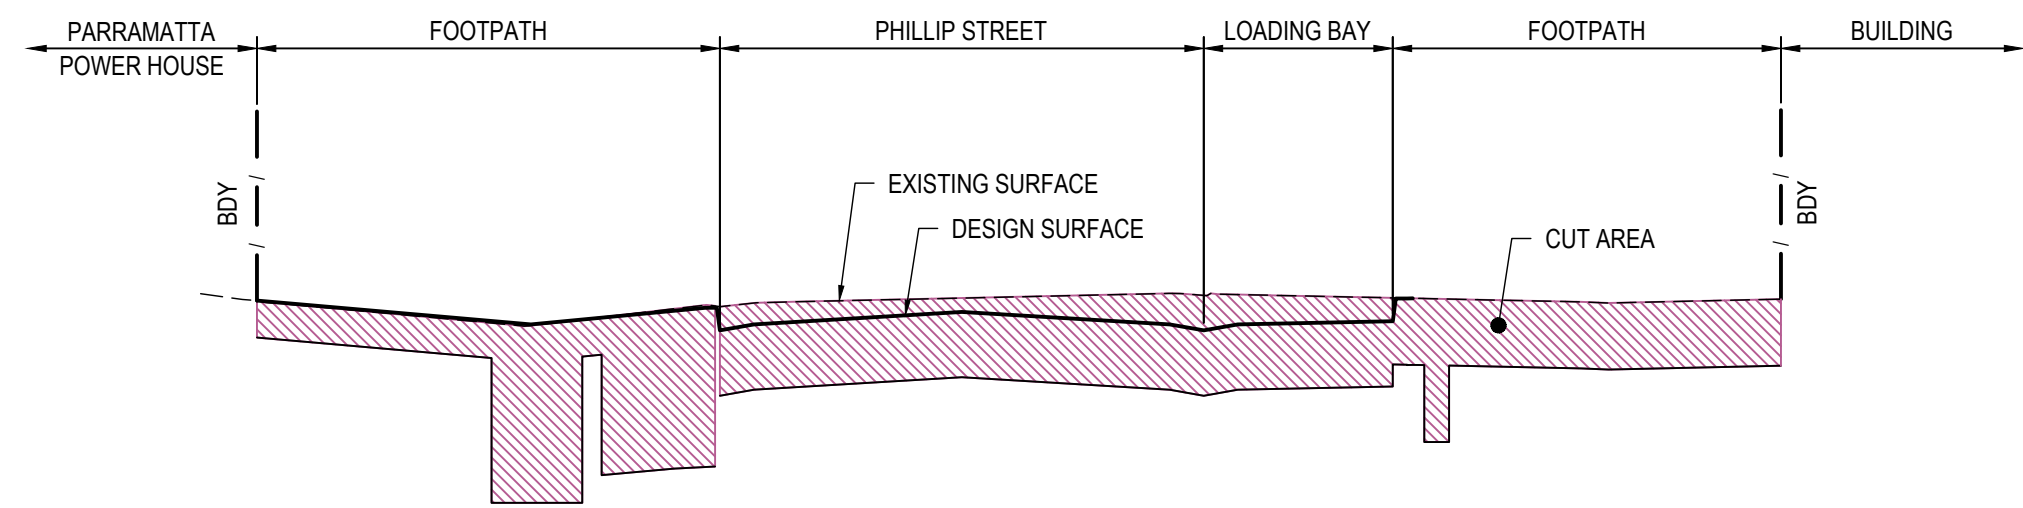
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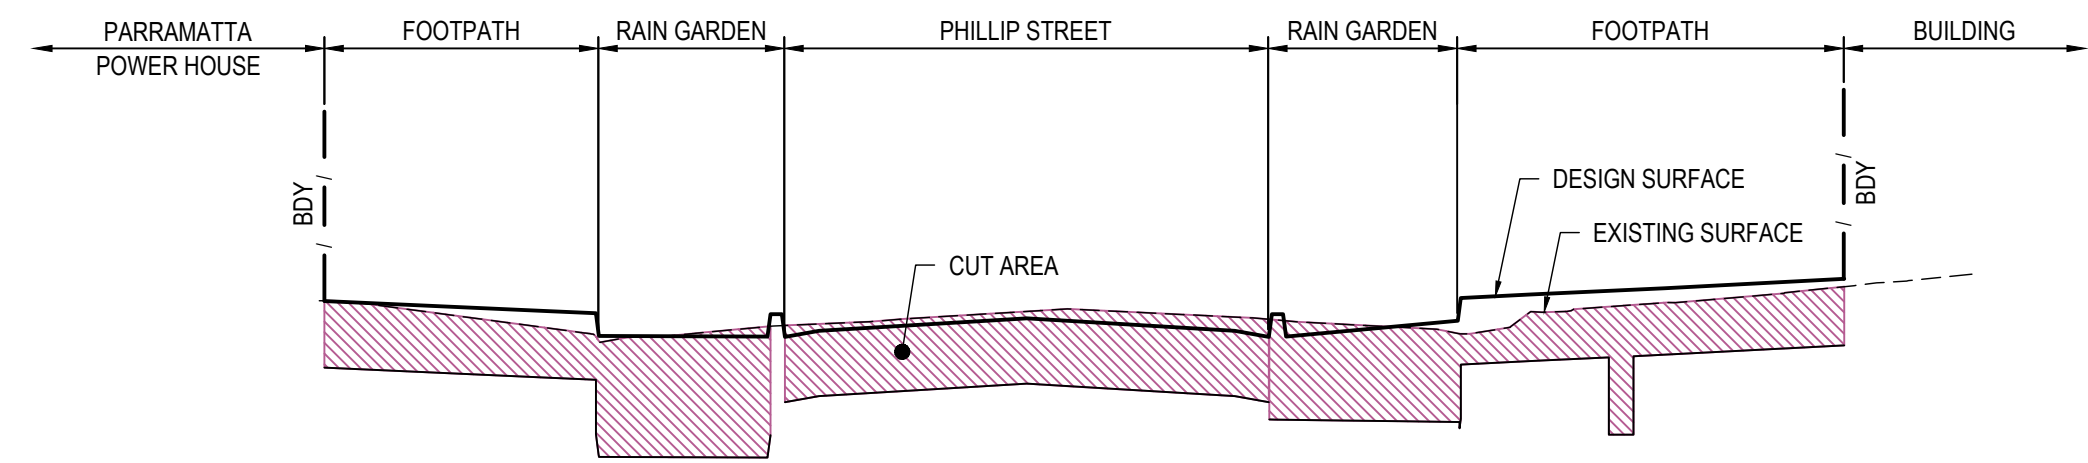
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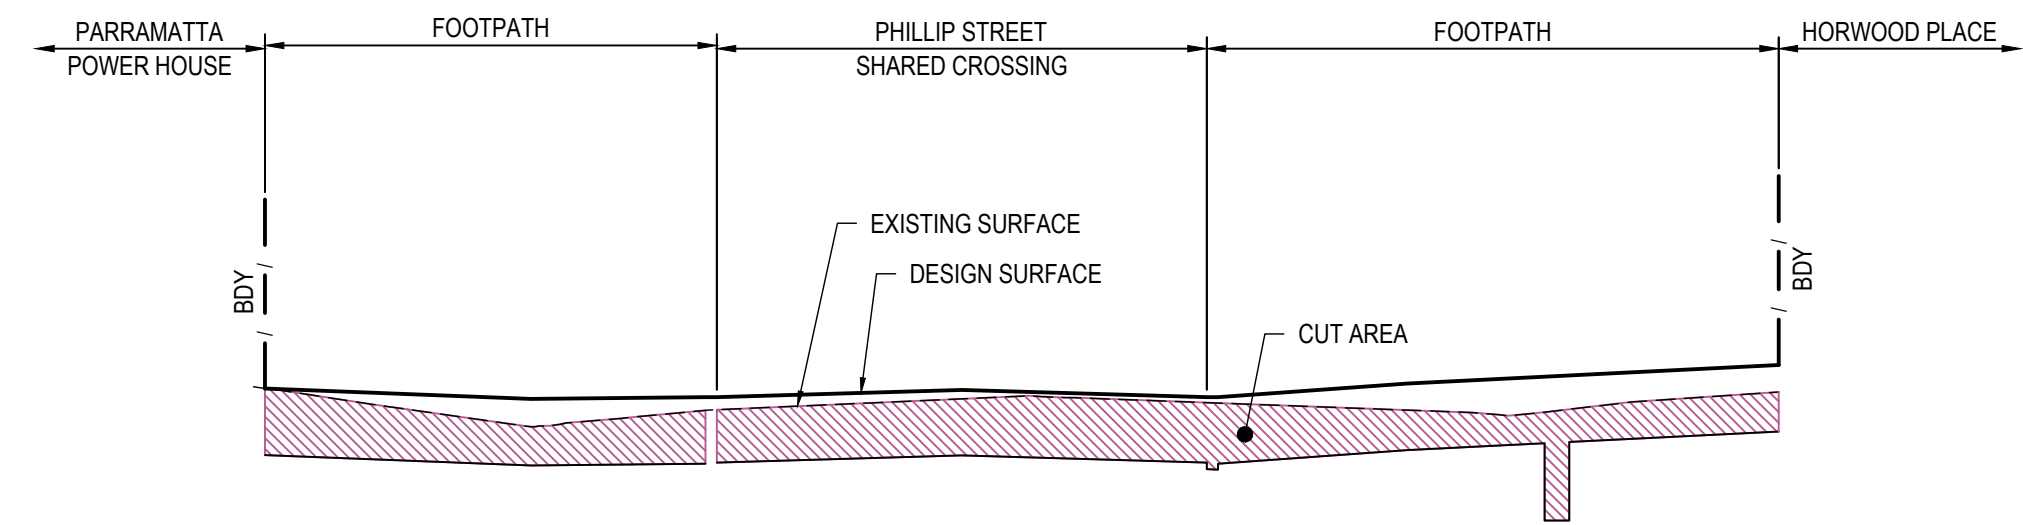
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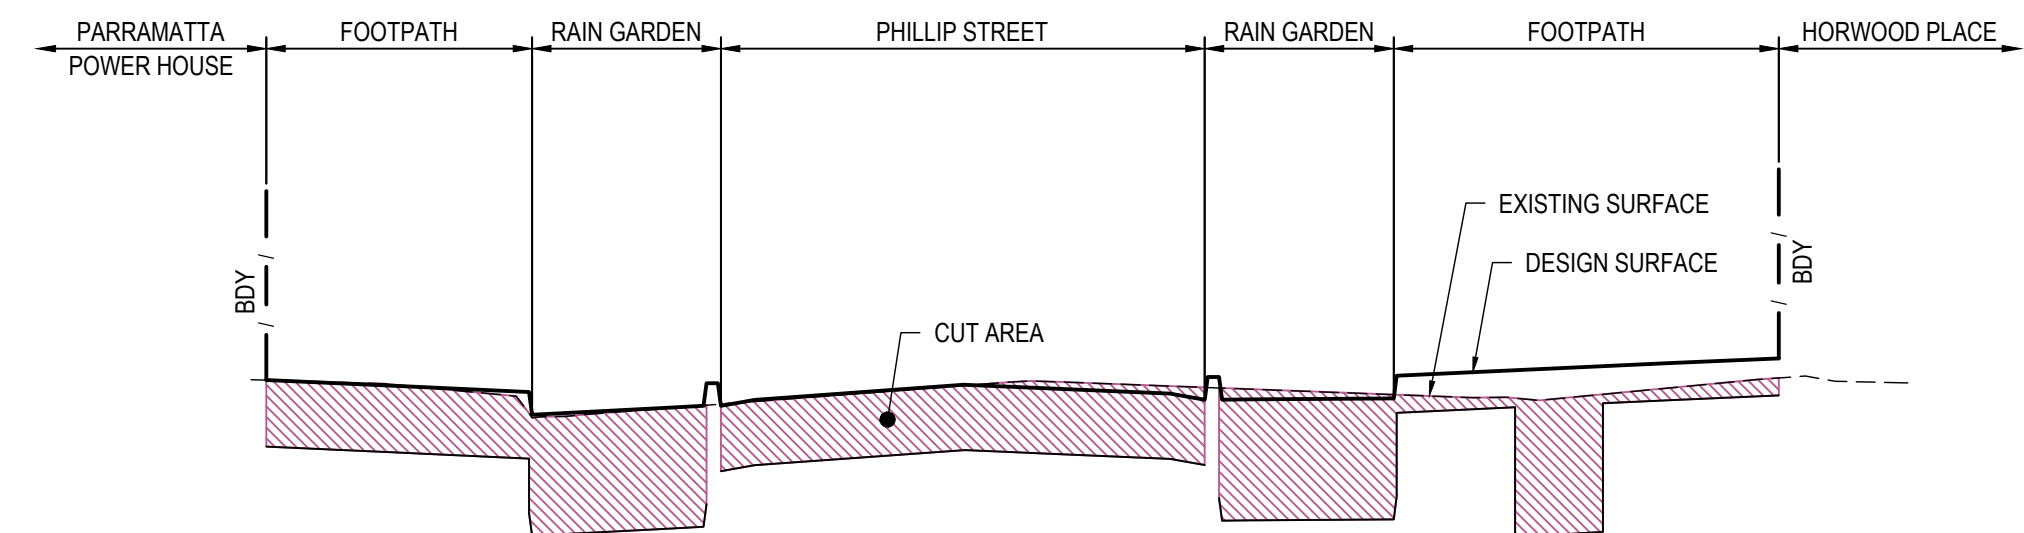
SECTION 1
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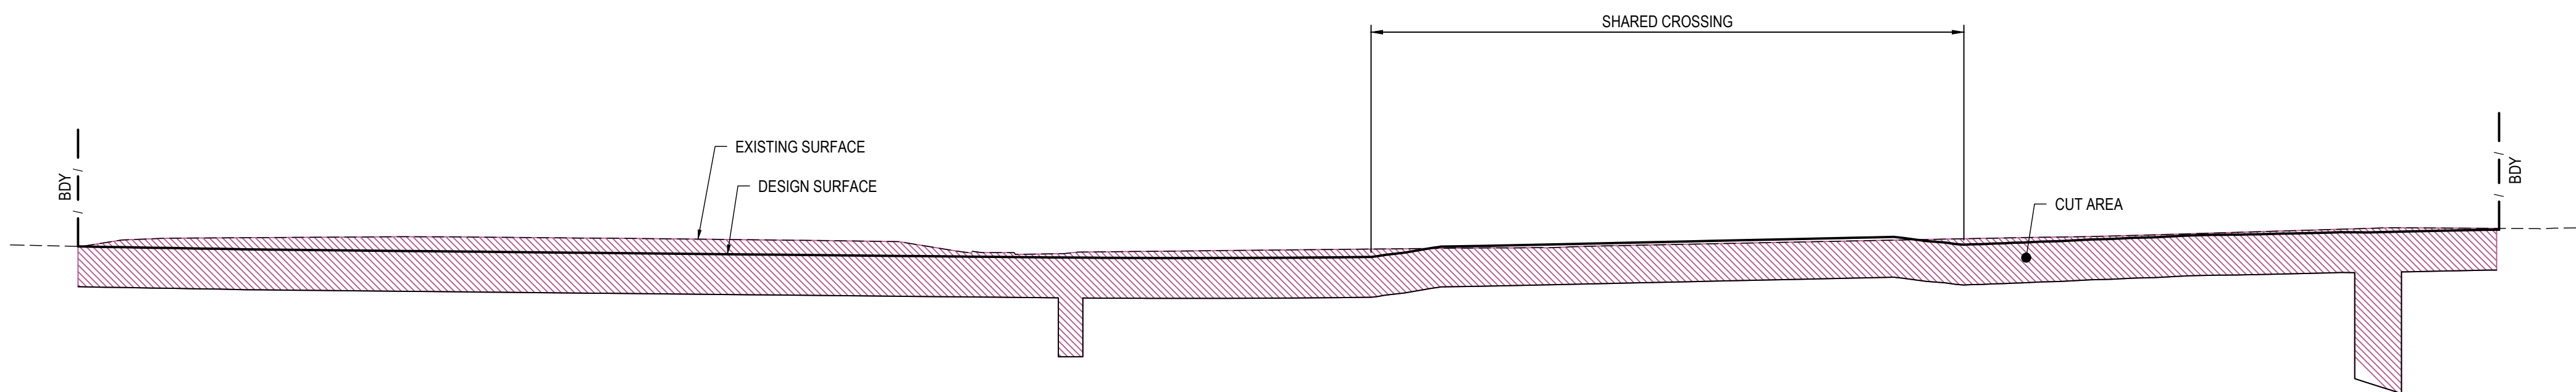
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SECTION 3
1 : 100h 1 : 50v




SECTION 4
1 : 100h 1 : 50v



SECTION 5
1 : 100h 1 : 50v

02	ISSUED FOR INFORMATION - 100% DETAILED DESIGN	RS	SG	GD	03.10.2025
01	ISSUED FOR INFORMATION - 95% DETAILED DESIGN	RS	SG	MK	10.09.2025
Issue	Description	DR	CH	VE	Date

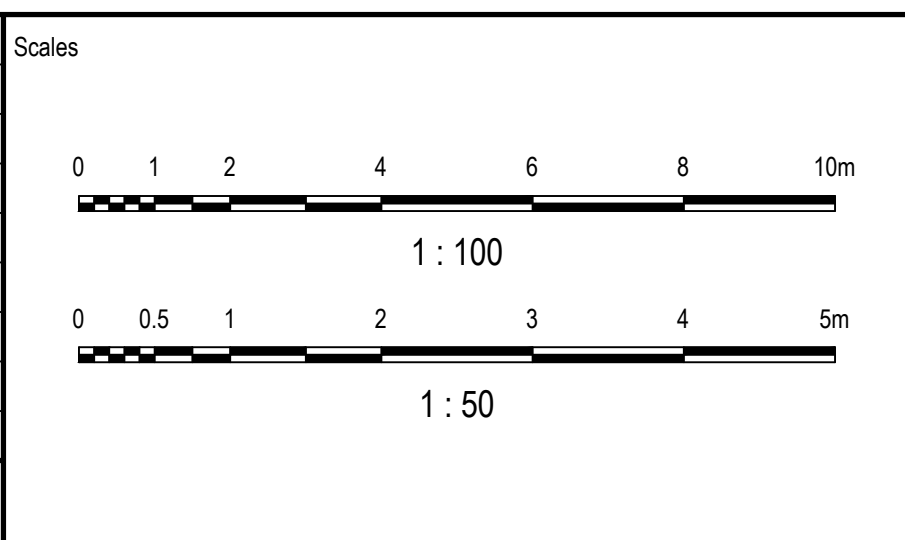

Surveyor

surveyplus **DURKIN**

Architect

OCULUS

Client

CITY OF PARRAMATTA

Status	PRELIMINARY NOT TO BE USED FOR CONSTRUCTION		
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Original Issue Signatures			
Drawn	R. SANTOS	Original Size	A1
Designed	L. CORSCADDEN	Height Datum	AHD
Project Manager	S. GEERDINK	Grid	MGA/20-56
Verified	G. DUNSTAN		

Project

**PARRAMATTA CIVIC LINK
PHILLIP STREET WORKS**

Title


**EARTHWORKS
SITE SECTIONS**

ARCADIS

Arcadis Australia Pacific Pty Limited
Level 16, 580 George Street
SYDNEY NSW 2000
ABN 76 104 485 289
Tel No: +61 2 8907 9000
www.arcadis.com/au

Project Number	30286862
Issue	02

Drawing No. **CL3-AAP-DD-PS-DRG-CI-0121**

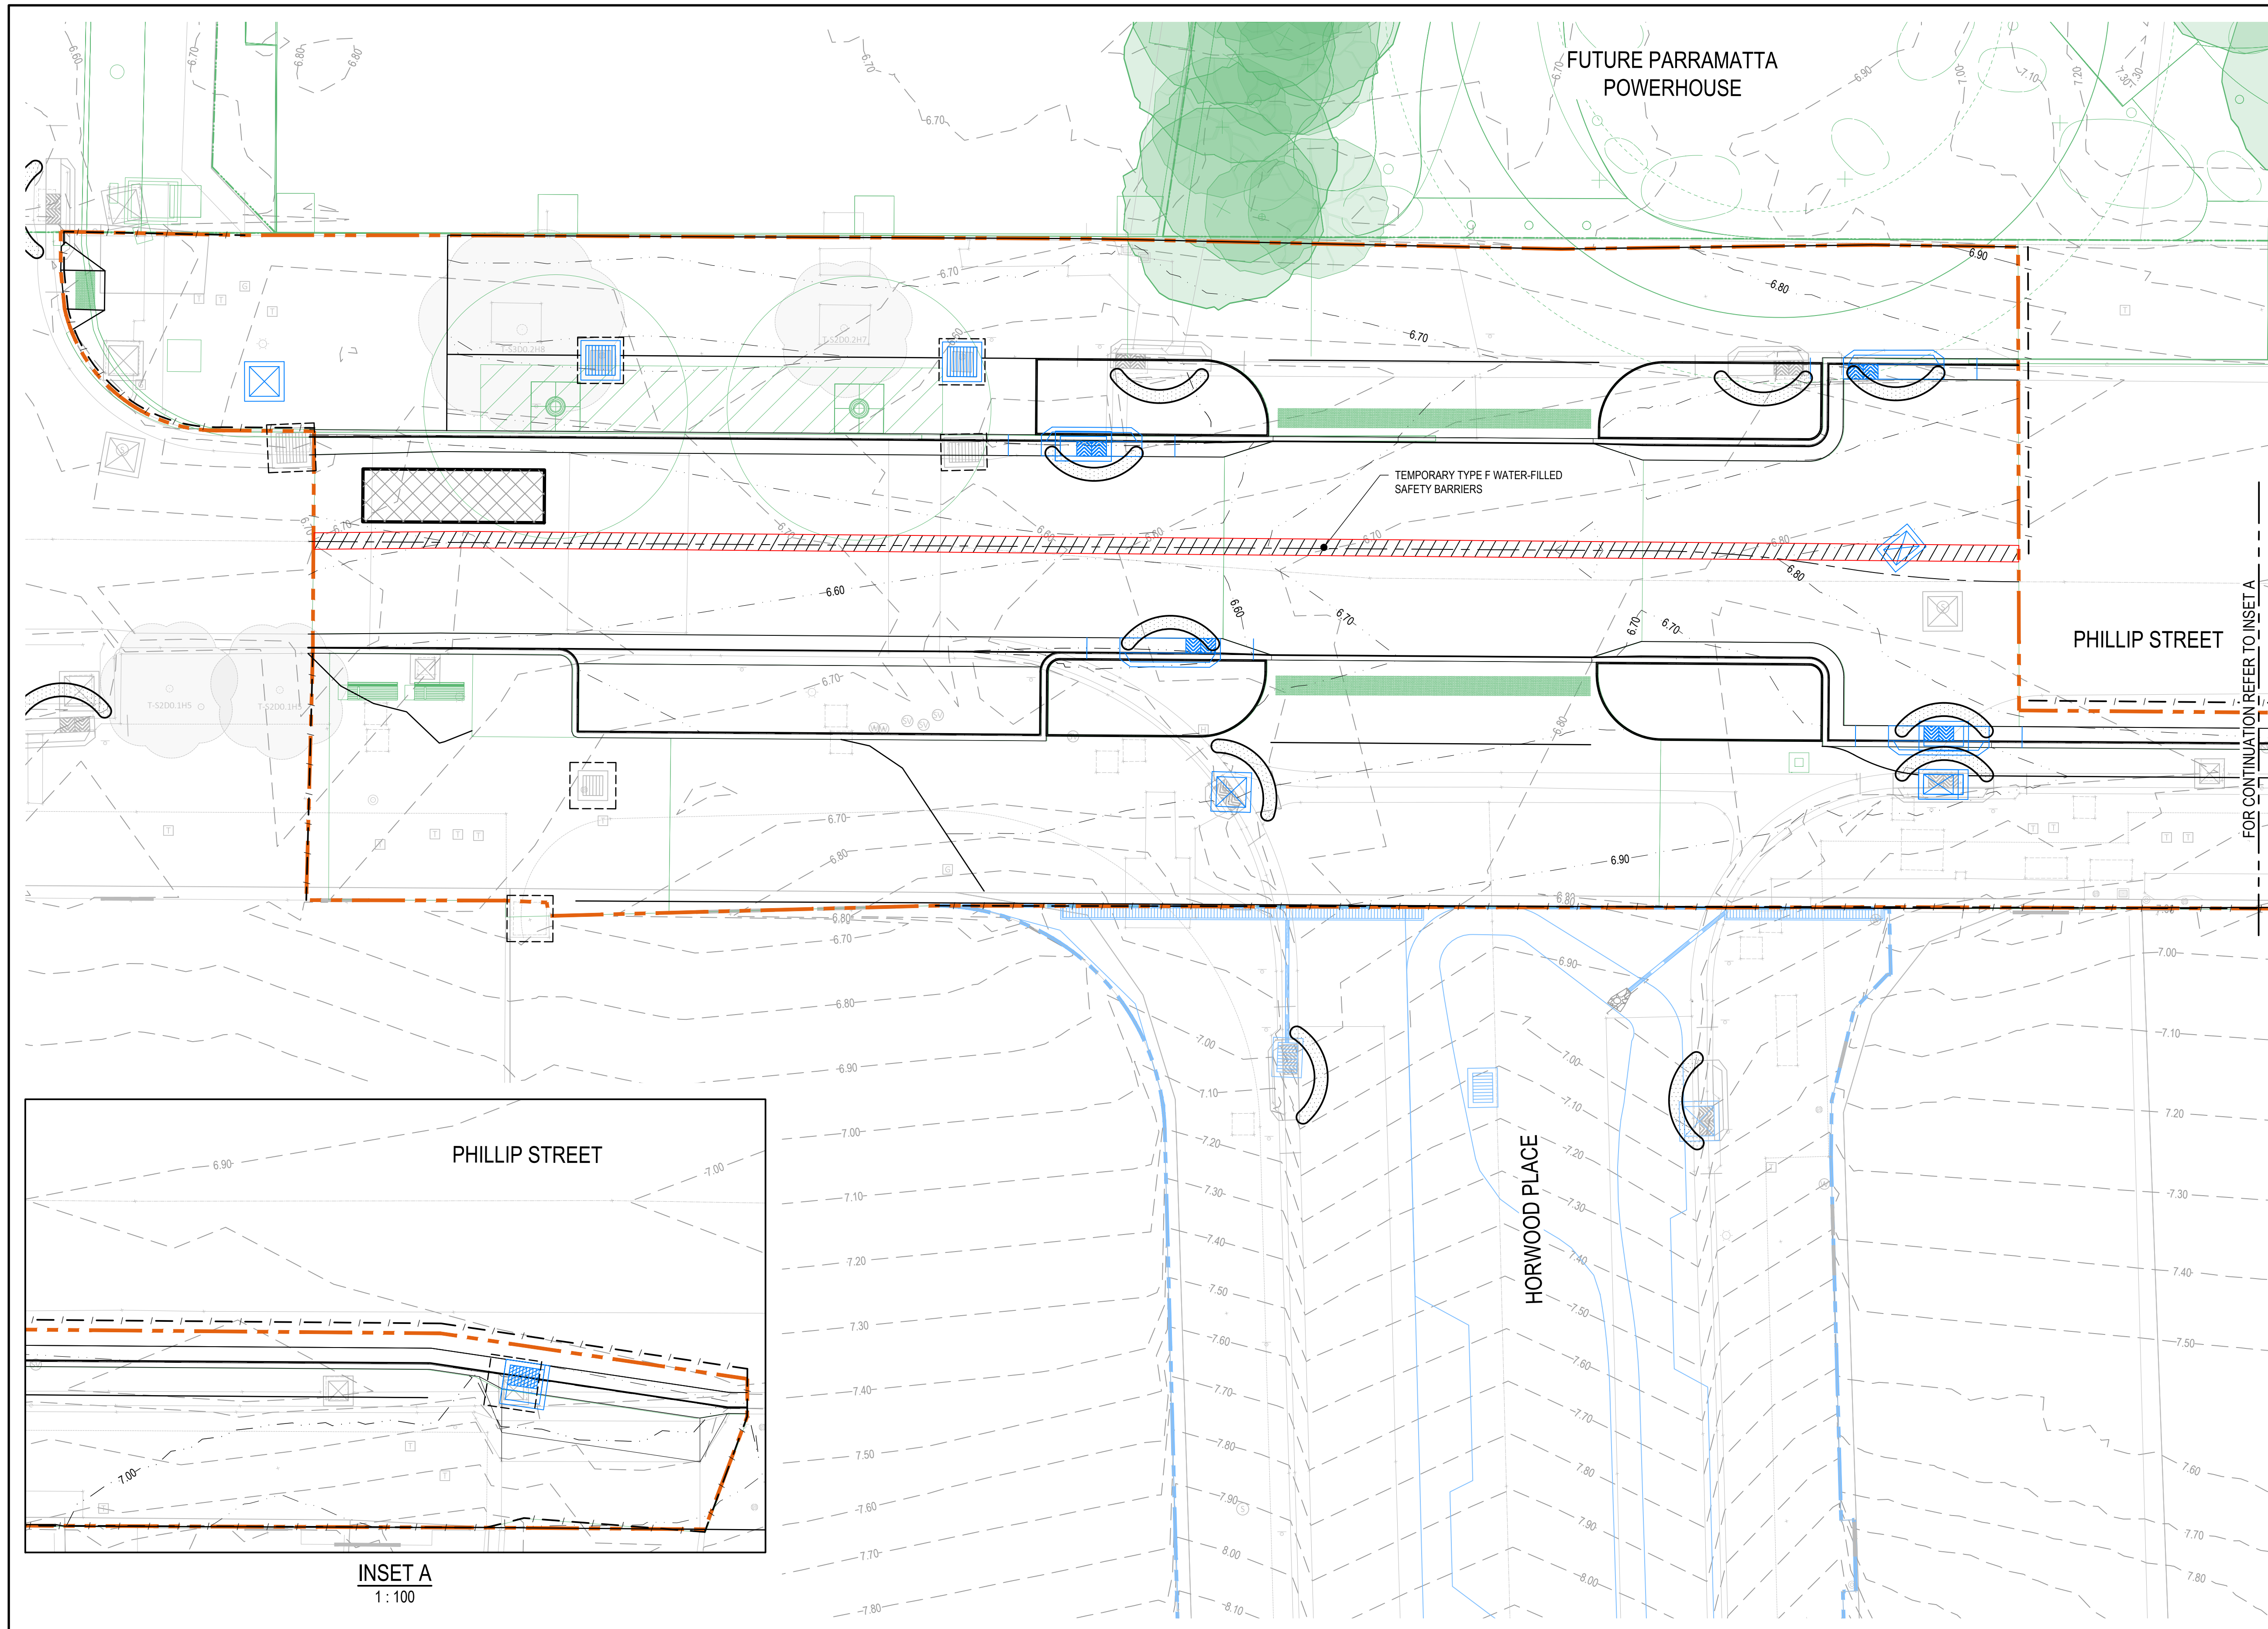

LEGEND

PHILLIP STREET WORKS SITE BOUNDARY

HORWOOD PLACE WORKS SITE BOUNDARY

EXISTING CONTOURS

DESIGN CONTOURS

ARCHITECTURAL WORKS

SITE FENCE

SEDIMENT TRAP FOR GRATED INLET PIT ON PAVEMENT

PROPOSED KERB INLET PIT

PROPOSED JUNCTION PIT

PROPOSED BUTTERFLY GRATED PIT

EXISTING KERB INLET PIT

EXISTING JUNCTION PIT

EXISTING GRATED PIT

FUTURE KERB INLET PIT

FUTURE JUNCTION PIT

FUTURE GRATED PIT

FUTURE GRATED DRAIN


MESH AND GRAVEL INLET FILTER (SD 6-11)

STABILISED SITE ACCESS (SD 6-14)

- NOTES**
1. REFER TO DRAWING CL3-AAP-DD-HP-DRG-CI-0191 FOR EROSION AND SEDIMENT CONTROL DETAILS.

2. CONTRACTOR IS TO ALLOW FOR HALF-ROAD CONSTRUCTION TO ALLOW A SINGLE LANE OF TRAFFIC TO PASS UNDER TRAFFIC MANAGEMENT.

3. SITE SECURITY TO BE COORDINATED WITH CONSTRUCTION WORKS.

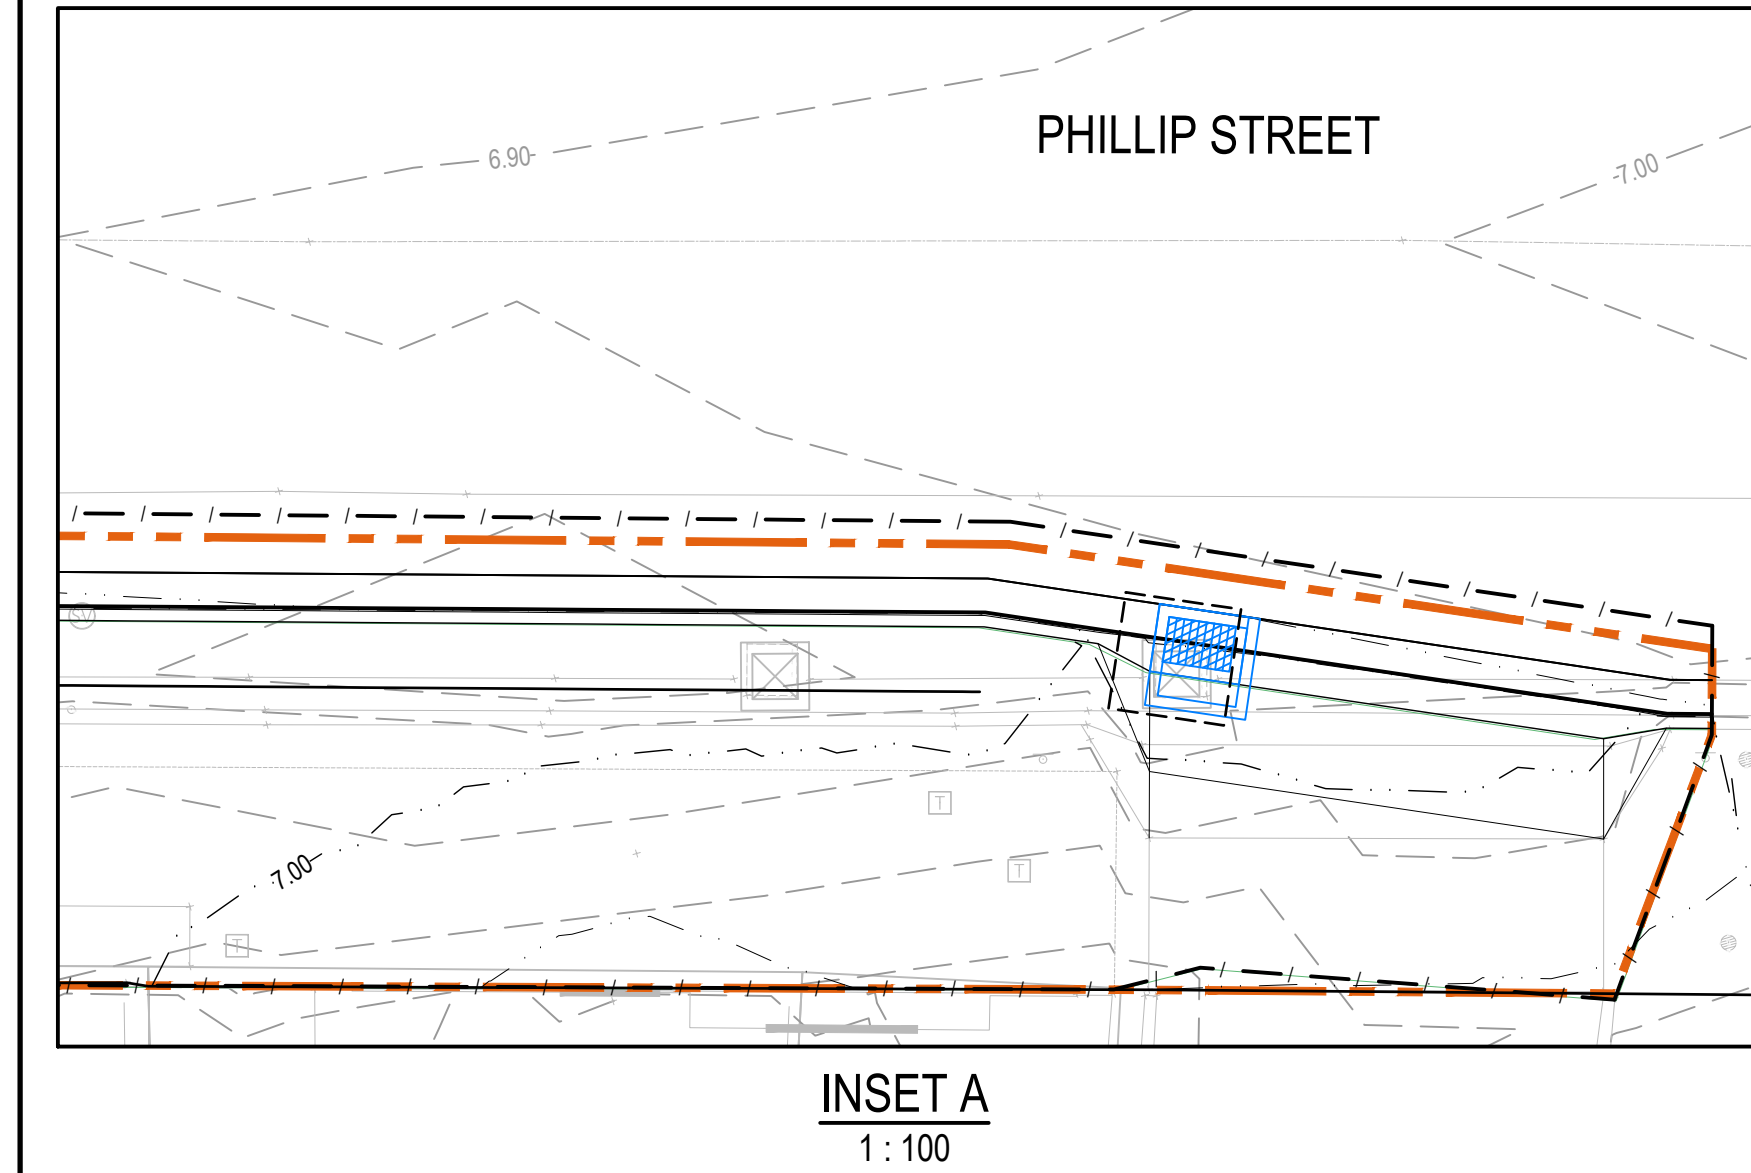

03	ISSUED FOR INFORMATION - 100% DETAILED DESIGN	RS	SG	GD	03.10.2025
02	ISSUED FOR INFORMATION - 95% DETAILED DESIGN	RS	SG	GD	10.09.2025
01	ISSUED FOR INFORMATION - 80% DETAILED DESIGN	RS	CR	MK	18.07.2025
Issue	Description	DR	CH	VE	Date

Scales

1 : 100

Surveyor

Architect

Client

Status

PRELIMINARY
NOT TO BE USED FOR CONSTRUCTION

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Original Issue Signatures

Drawn	R. SANTOS	Original Size	A1
Designed	L. CORSCADEN	Height Datum	AHD
Project Manager	S. GEERDINK	Grid	MGA/20-56
Verified	G. DUNSTAN		

Project

PARRAMATTA CIVIC LINK
PHILLIP STREET WORKS

Title

EROSION AND SEDIMENT CONTROL PLAN

Arcadis Australia Pacific Pty Limited
Level 16, 580 George Street
SYDNEY NSW 2000
ABN 76 104 485 289
Tel No: +61 2 8907 9000
www.arcadis.com/au

Project Number	30286862	Issue	03
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CL3-AAP-DD-PS-DRG-CI-0171

Date Plotted: 3 Oct 2025 - 06:00pm File Name: C:\Users\santos4174\Documents\Arcadis ACC AU\IAU-30286862-Parramatta Civic Link Block 3\Project Files\10_WIP\10_Civil\STG_Phillip Street\DRG\CL3-AAP-DD-PS-DRG-CI-0171-ErosionAndSedimentControlPlan.dwg

1. REFER TO DRAWING CL3-AAP-DD-HP-DRG-CI-0171 FOR THE EROSION AND SEDIMENT CONTROL PLAN.
2. EROSION AND SEDIMENT CONTROL DETAILS HAVE BEEN TAKEN DIRECTLY FROM NSW DEPARTMENT OF HOUSING MANUAL, 'MANAGING URBAN STORMWATER, SOILS AND CONSTRUCTION' 4TH EDITION, MARCH 2004



1. Place stockpiles more than 2 (preferably 5) metres from existing vegetation, concentrated water flow, roads and hazard areas.
2. Construct on the contour as low, flat, elongated mounds.
3. Where there is sufficient area, topsoil stockpiles shall be less than 2 metres in height.
4. Where they are to be in place for more than 10 days, stabilise following the approved ESCP or SWMP to reduce the C-factor to less than 0.10.
5. Construct earth banks (Standard Drawing 5-5) on the upslope side to divert water around stockpiles and sediment fences (Standard Drawing 6-8) 1 to 2 metres downslope.

Construction Notes

1. Build with gradients between 1 percent and 5 percent.
2. Avoid removing trees and shrubs if possible - work around them.
3. Ensure the structures are free of projections or other irregularities that could impede water flow.
4. Build the drains with circular, parabolic or trapezoidal cross sections, not V shaped.
5. Ensure the banks are properly compacted to prevent failure.
6. Complete permanent or temporary stabilisation within 10 days of construction.

Construction Notes

1. Construct sediment fences as close as possible to be parallel to the contours of the site, but with small returns as shown in the drawing to limit the catchment area of any one section. The catchment area should be small enough to limit water flow if concentrated at one point to 50 litres per second in the design storm event, usually the 10-year event.
2. Cut a 150-mm deep trench along the upslope line of the fence for the bottom of the fabric to be entrenched.
3. Drive 1.5 metre long star pickets into ground at 2.5 metre intervals (max) at the downslope edge of the trench. Ensure any star pickets are fitted with safety caps.
4. Fix self-supporting geotextile to the upslope side of the posts ensuring it goes to the base of the trench. The geotextile will be secured with wire ties as recommended by the manufacturer. Only use geotextile specifically produced for sediment fencing. The use of shade cloth for this purpose is not satisfactory.
5. Join sections of fabric at a support post with a 150-mm overlap.
6. Backfill the trench over the base of the fabric and cap it thoroughly over the geotextile.

NOTE: This practice only to be used where specified in an approved SWMP/ESCP.

Construction Notes

1. Install filters to kerb inlets only at sag points.
2. Fabricate a sleeve made from geotextile or wire mesh longer than the length of the inlet pit and fill it with 25 mm to 50 mm gravel.
3. Form an elliptical cross-section about 150 mm high x 400 mm wide.
4. Place the filter at the opening leaving at least a 100-mm space between it and the kerb inlet. Maintain the opening with spacer blocks.
5. Form a seal with the kerb to prevent sediment bypassing the filter.
6. Sandbags filled with gravel can substitute for the mesh or geotextile providing they are placed so that they firmly abut each other and sediment-laden waters cannot pass between.

The diagram illustrates a cross-section of a road construction site. At the top, a 'Construction site' label points to the area above the geotextile. A 'Min. width 3 metres' dimension is shown for the geotextile strip. A 'Min. length 15 metres' dimension is shown for the length of the strip. A '200 mm min.' dimension is shown for the thickness of the sub-base layer. A '300 mm min.' dimension is shown for the thickness of the road base layer. A 'Property boundary' line is indicated on the right. An arrow points to the 'tuff directed to sediment trap/fence' area. The 'OGB 20 roadbase or 30 mm aggregate' layer is shown below the geotextile. The 'Existing roadway' is shown at the bottom. The geotextile is labeled as 'Geotextile fabric designed to prevent intermixing of subgrade and base materials and to maintain good properties of the sub-base layers.' and 'Geotextile may be a woven or needle-punched product with a minimum CBR burst strength (AS3708-A-30) of 2500 N'.

Construction Notes

1. Strip the topsoil, level the site and compact the subgrade.
2. Cover the area with needle-punched geotextile.
3. Construct a 200-mm thick pad over the geotextile using road base or 30-mm aggregate.
4. Ensure the structure is at least 15 metres long or to building alignment and at least 3 metres wide.
5. Where a sediment fence joins onto the stabilised access, construct a hump in the stabilised access to divert water to the sediment fence

MATERIALS

FABRIC (LIGHT TRAFFIC AREAS):
HEAVY DUTY, NEED-PUNCHED, NON WOVEN FILTER CLOTH
('BIDIM' A34 OR EQUIVALENT).

FABRIC (HEAVY TRAFFIC AREAS):
POLY-PROPYLENE , POLYAMIDE, NYLON, POLYESTER, OR
POLYETHYLENE WOVEN OR NON-WOVEN REINFORCED FABRIC.
THE FABRIC WIDTH SHOULD BE AT LEAST 700mm WITH A
MINIMUM UNIT WEIGHT OF 140g/m². FABRICS SHOULD CONTAIN
ULTRAVIOLET INHIBITORS AND STABILISERS TO PROVIDE A
MINIMUM OF 6 MONTHS OF USEABLE CONSTRUCTION LIFE
(ULTRAVIOLET STABILITY EXCEEDING 70%)

INSTALLATION

1. REFER TO APPROVED PLANS FOR LOCATION AND DIMENSIONAL DETAILS. IF THERE ARE QUESTIONS OR PROBLEMS WITH THE LOCATION, DIMENSIONS OR METHOD OF INSTALLATION CONTACT THE ENGINEER OR RESPONSIBLE ON-SITE OFFICER FOR ASSISTANCE.
2. ENSURE THAT THE INSTALLATION OF THE SEDIMENT TRAP WILL NOT CAUSE UNDESIRABLE SAFETY OR FLOODING ISSUES
3. APPLY THE APPROPRIATE FABRIC FOR THE SITE CONDITIONS.
4. WRAP THE FABRIC AROUND OR OVER THE STORMWATER INLET GRATE IN SUCH A MANNER THAT PREVENTS ANY WATER ENTERING THE STORMWATER INLET WITHOUT PASSING THROUGH THE FABRIC.

5. ENSURE ALL OTHER FLOW ENTRY POINTS ARE COVERED WITH FABRIC SUCH THAT WATER CANNOT ENTER THE STORMWATER INLET WITHOUT PASSING THROUGH A SUITABLE FILTER.
6. TAKE ALL NECESSARY MEASURES TO MINIMISE SAFETY OR FLOODING RISK CAUSED BY OPERATION OF THE SEDIMENT TRAP.

MAINTENANCE

1. INSPECT THE BARRIER AFTER EACH RUNOFF-PRODUCING RAINFALL EVENT AND MAKE REPAIRS AS NEEDED TO THE SEDIMENT TRAP.
2. REMOVE COLLECTED SEDIMENT AND DISPOSE OF IN A SUITABLE MANNER THAT WILL NOT CAUSE AN EROSION OR POLLUTION HAZARD.
3. REPLACE THE FABRIC IF IT IS TORN OR DAMAGED.
4. SEDIMENT DEPOSITS SHOULD BE REMOVED IMMEDIATELY IF THEY REPRESENT A SAFETY RISK.

REMOVAL

WHEN THE UP-SLOPE DRAINAGE AREA HAS BEEN STABILISED, REMOVE ALL MATERIALS INCLUDED DEPOSITED SEDIMENT AND DISPOSE OF IN A SUITABLE MANNER THAT WILL NOT CAUSE AN EROSION OR POLLUTION HAZARD.



FOR GRATED INLET PIT ON PAVEMENT

Scales

NOT TO SCALE

NOT TO SCALE

Client



**CITY OF
PARRAMATTA**

Project	PARRAMATTA CIVIC LINK PHILLIP STREET WORKS
Title	EROSION AND SEDIMENT CONTROL DETAILS

PARRAMATTA
CIVIC LINK
PHILLIP STREET WORKS

EROSION AND SEDIMENT CONTROL DETAILS




Drawing No.


CL3-AAP-DD-PS-DRG-CI-0191

Project Number	30286862
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Issue
03

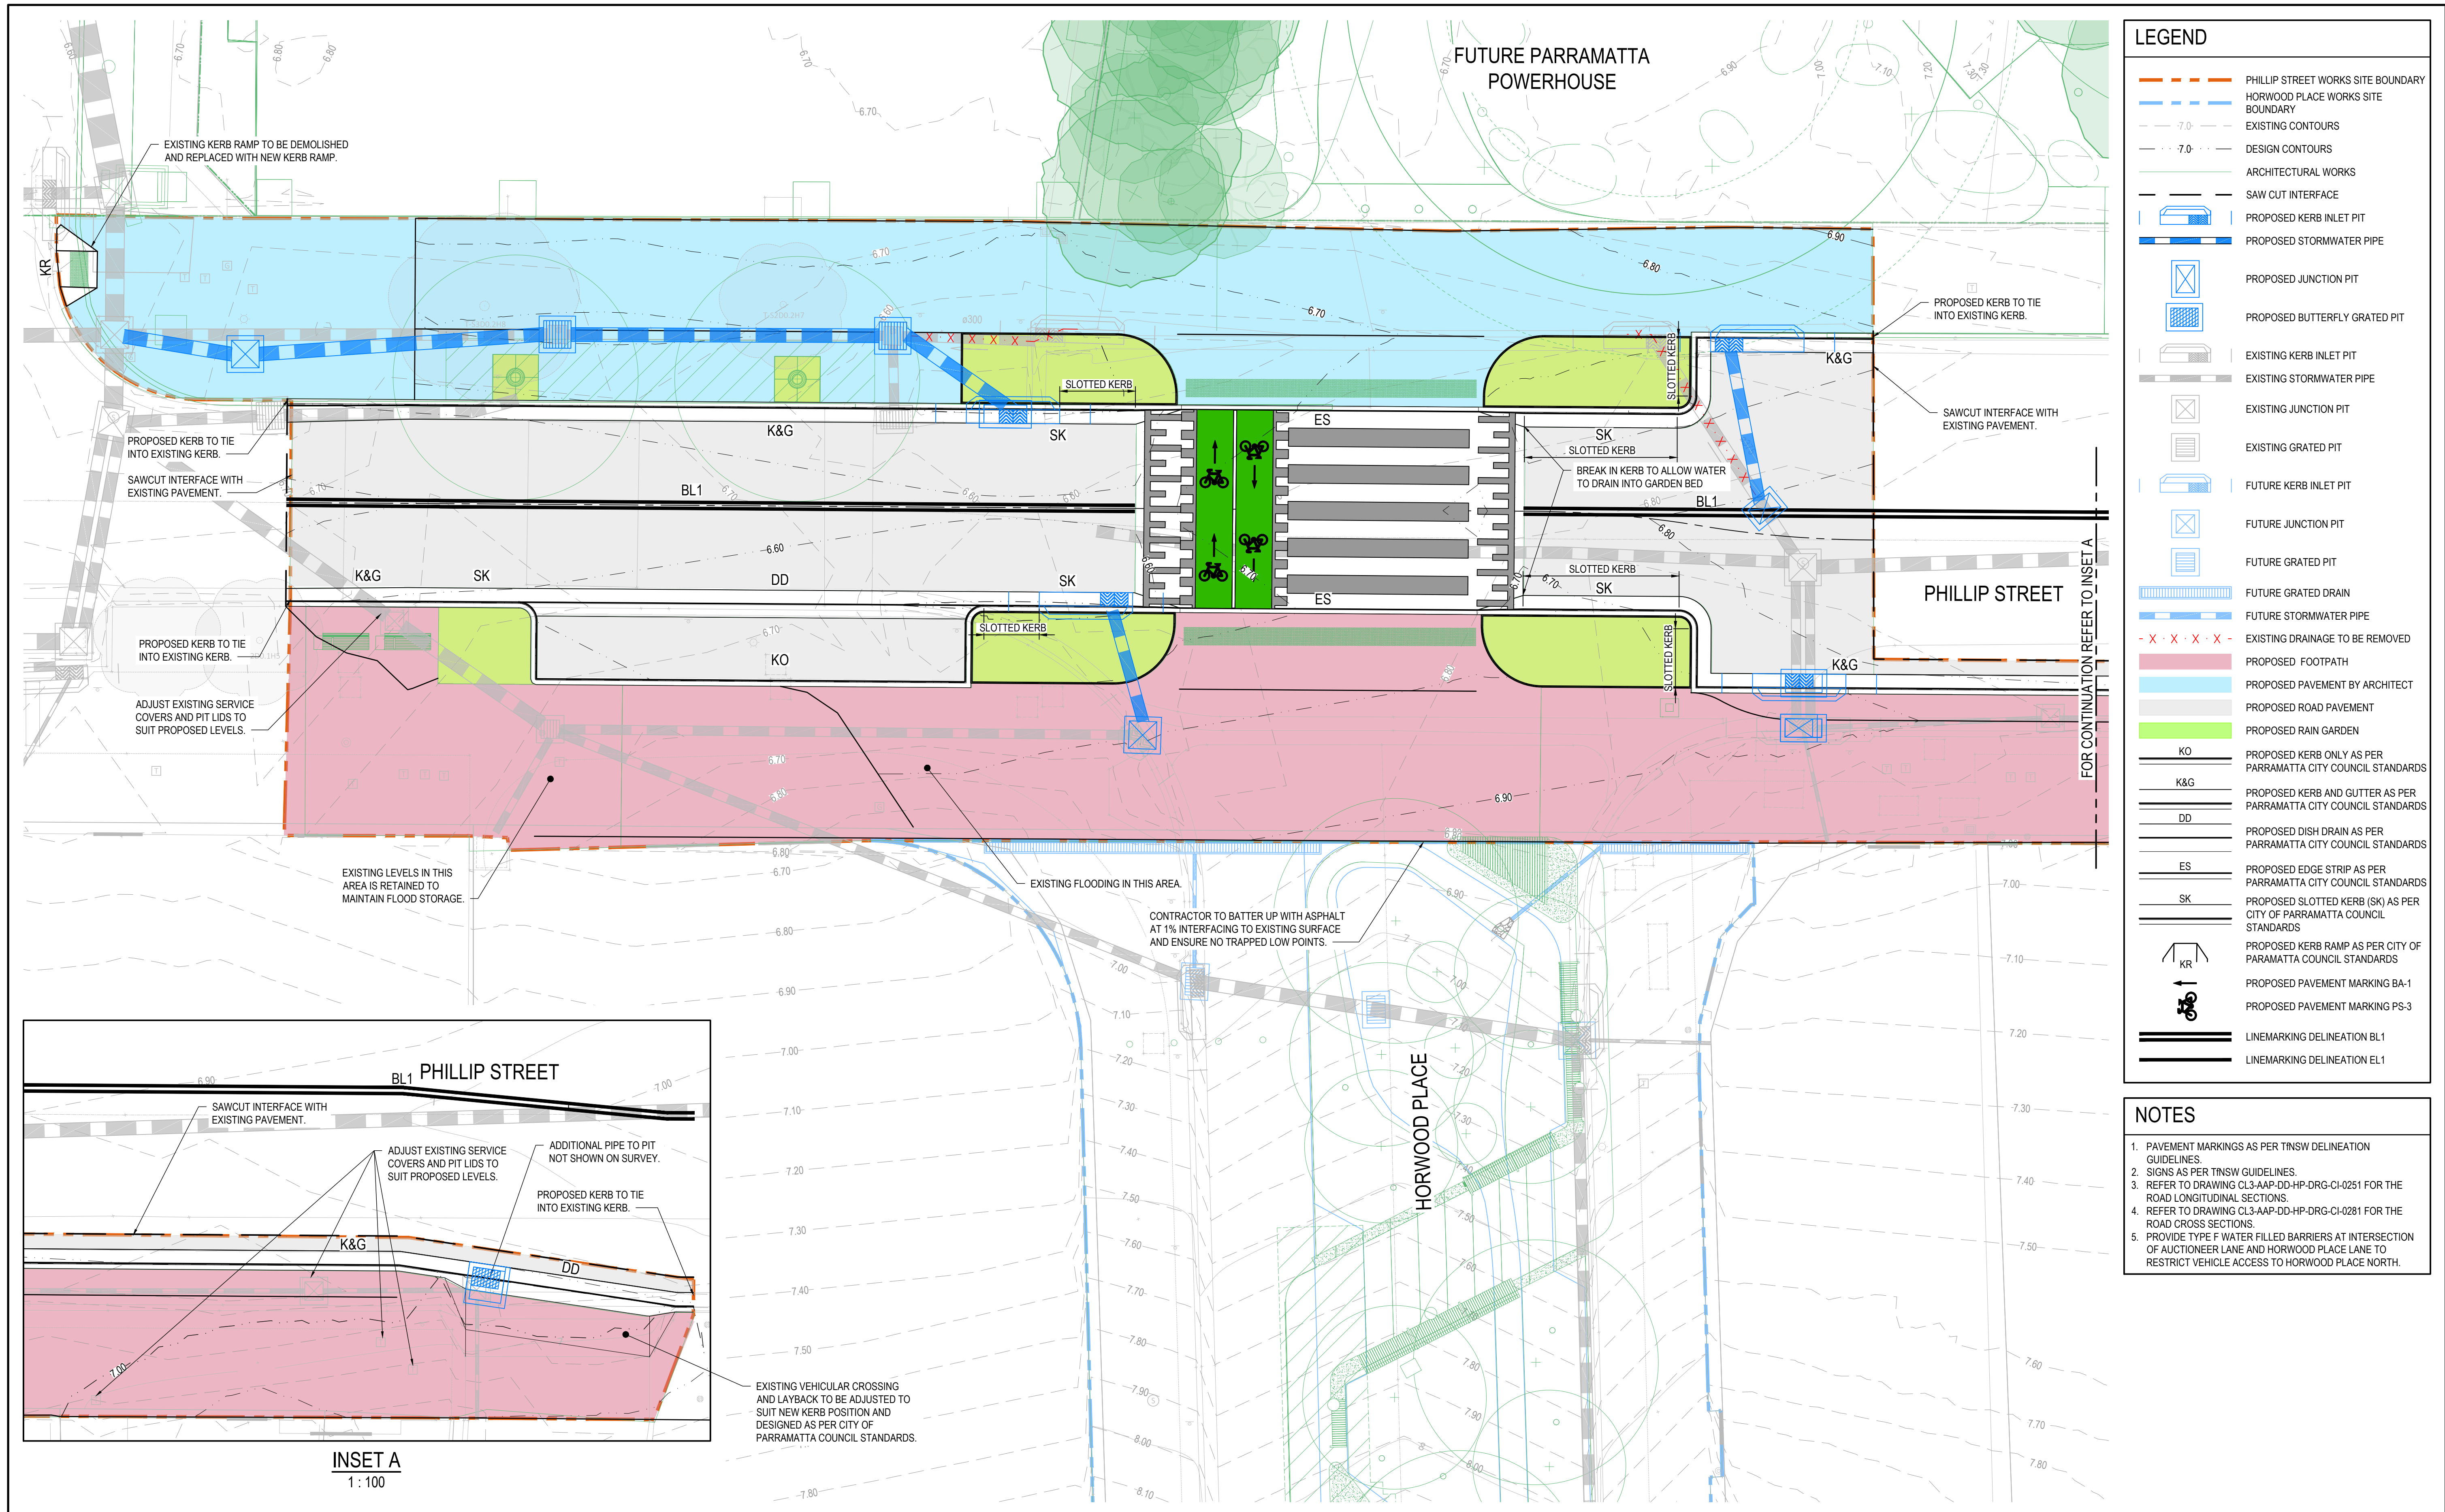

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LEGEND

PHILLIP STREET WORKS SITE BOUNDARY

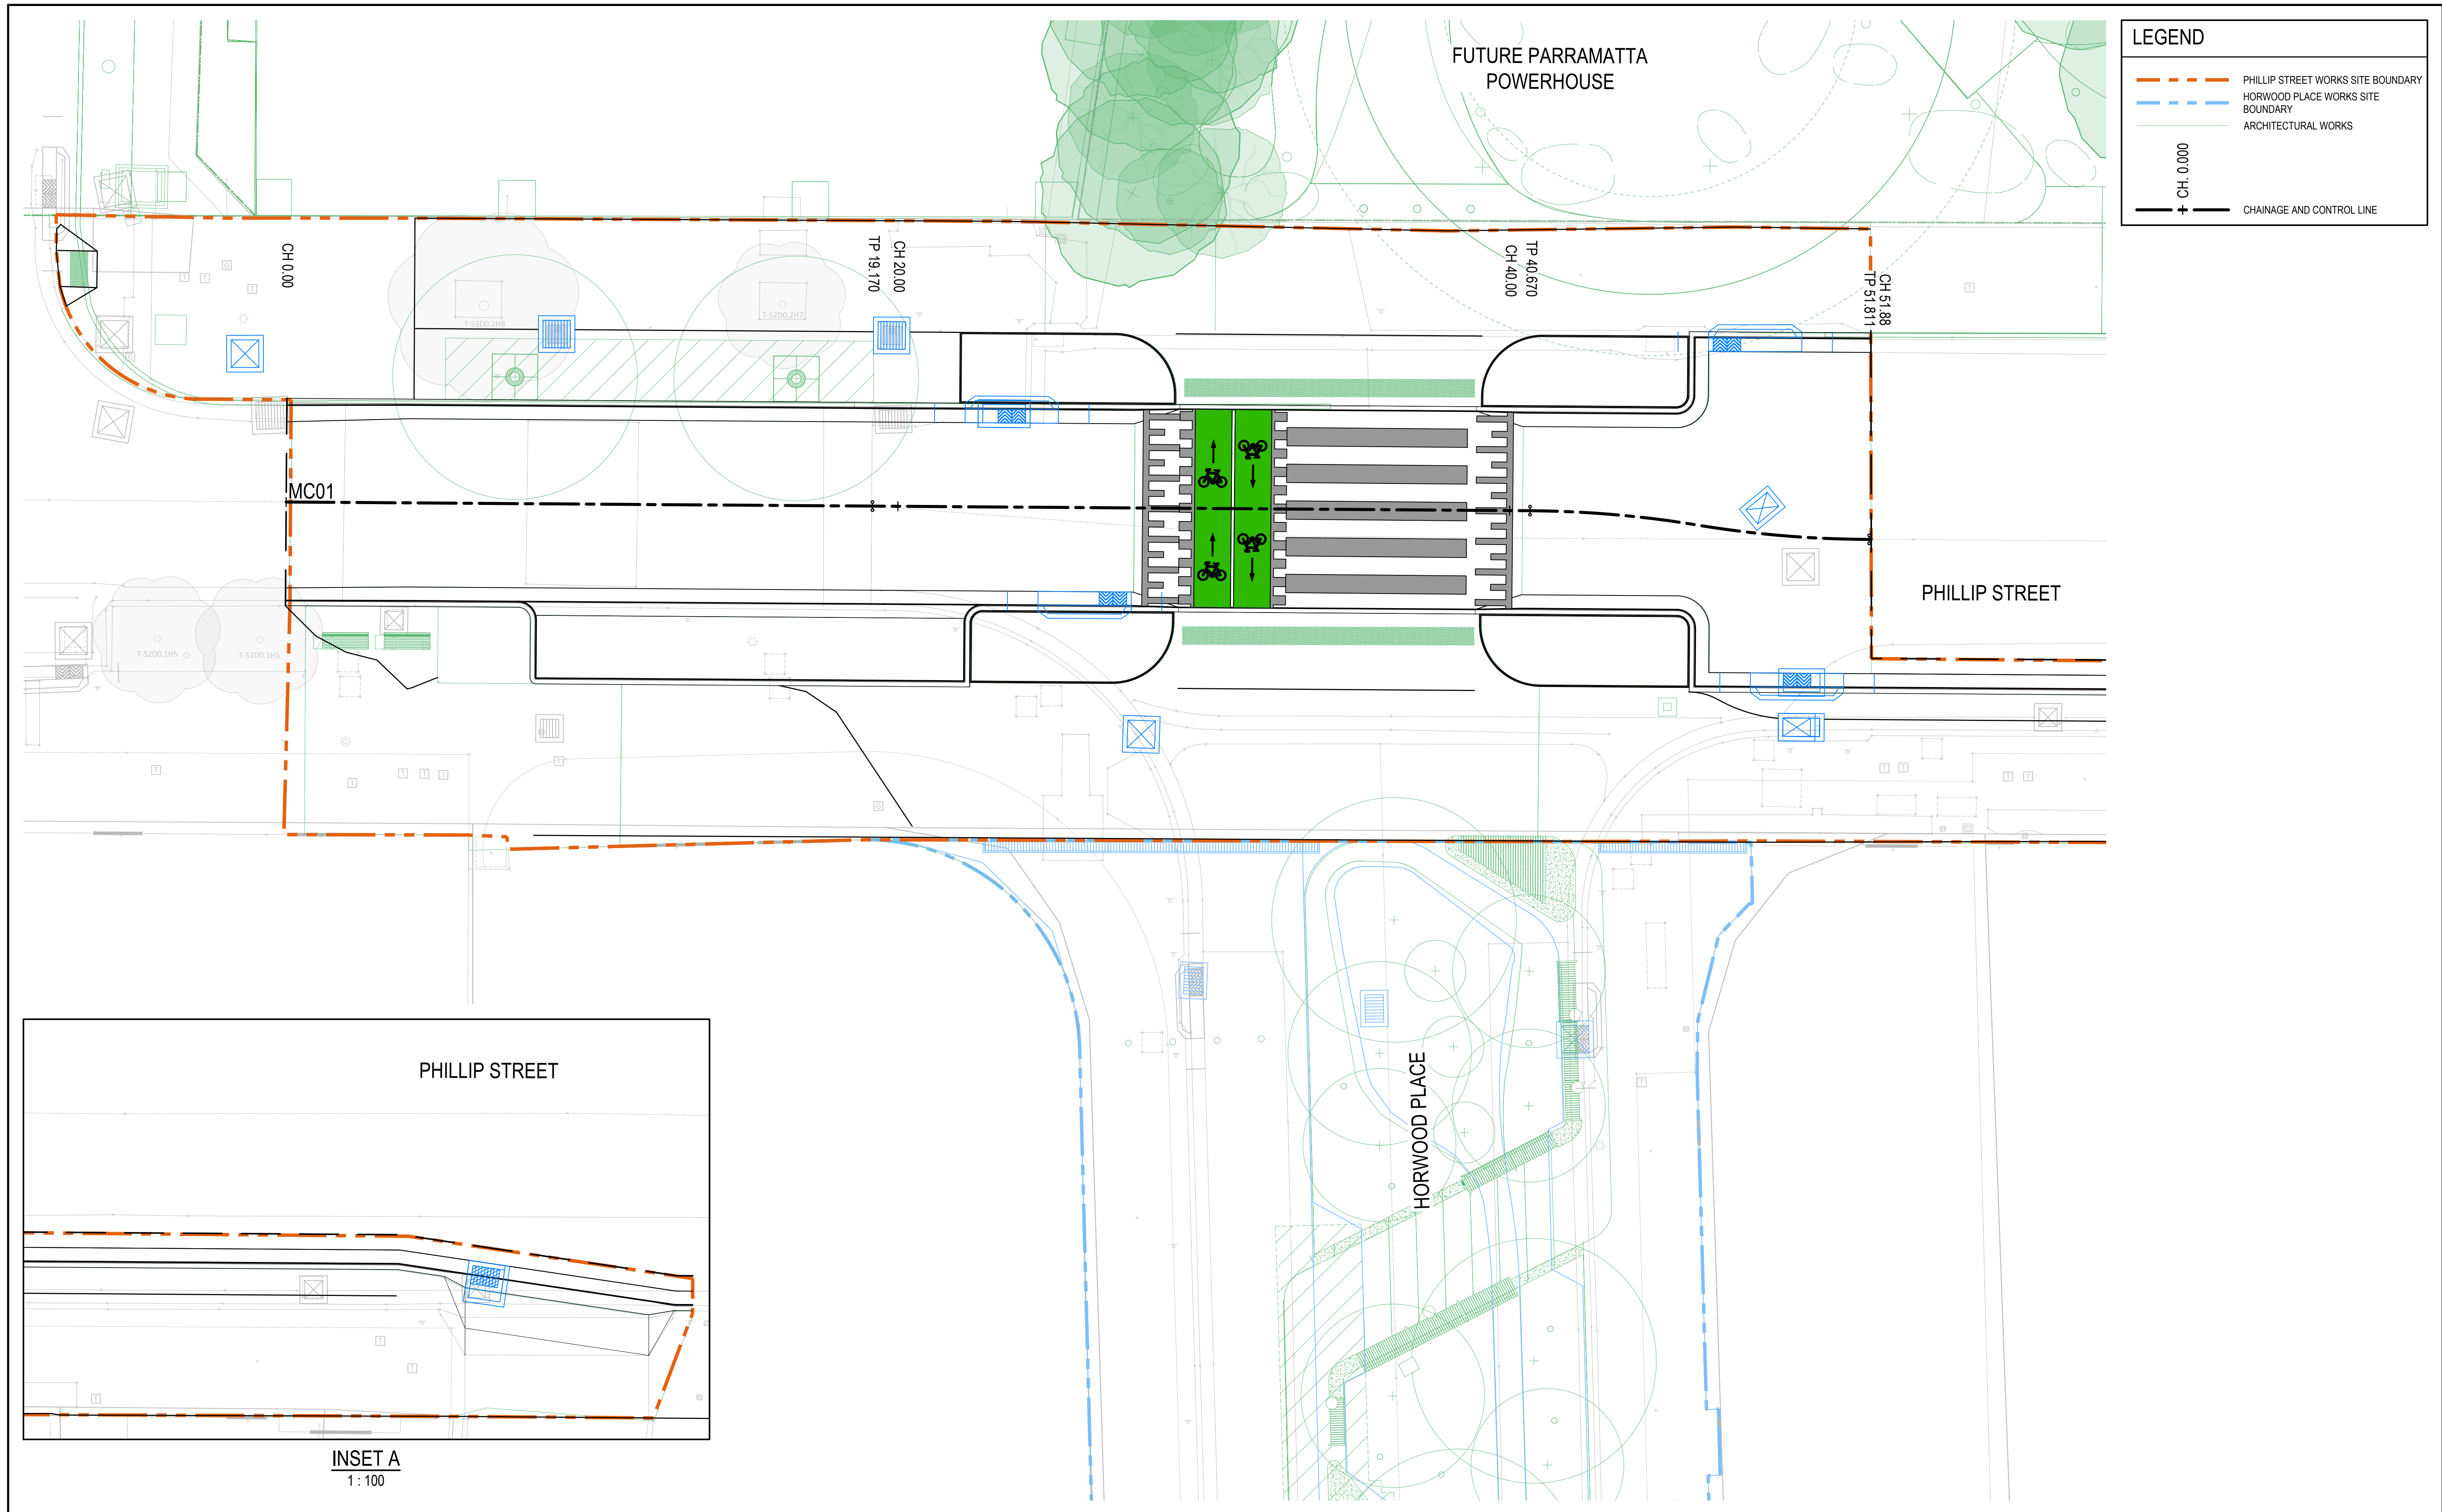HORWOOD PLACE WORKS SITE BOUNDARY

ARCHITECTURAL WORKS

CH 0.000

CHAINAGE AND CONTROL LINE



02	ISSUED FOR INFORMATION - 100% DETAILED DESIGN	RS	SG	GD	03.10.2025
01	ISSUED FOR INFORMATION - 95% DETAILED DESIGN	RS	SG	MK	10.09.2025
Issue	Description	DR	CH	VE	Date

Scales

N

01246810m

1 : 100

Surveyor

surveyplus

DURKIN

Architect

OCULUS

Client

CITY OF PARRAMATTA

Status

PRELIMINARY
NOT TO BE USED FOR CONSTRUCTION

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Original Issue Signatures

Drawn

R. SANTOS

Original Size

A1

Designed

L. CORSCADEN

Height Datum

AHD

Project Manager

S. GEERDINK

Grid

MGA/20-56

Verified

G. DUNSTAN

Project

PARRAMATTA
CIVIC LINK
PHILLIP STREET WORKS

Title

ROAD CONTROL
SETOUT PLAN

ARCADIS

Arcadis Australia Pacific Pty Limited
Level 16, 580 George Street
SYDNEY NSW 2000
ABN 76 104 485 289
Tel No: +61 2 8907 9000
www.arcadis.com/au

Project Number


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Issue


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Drawing No.


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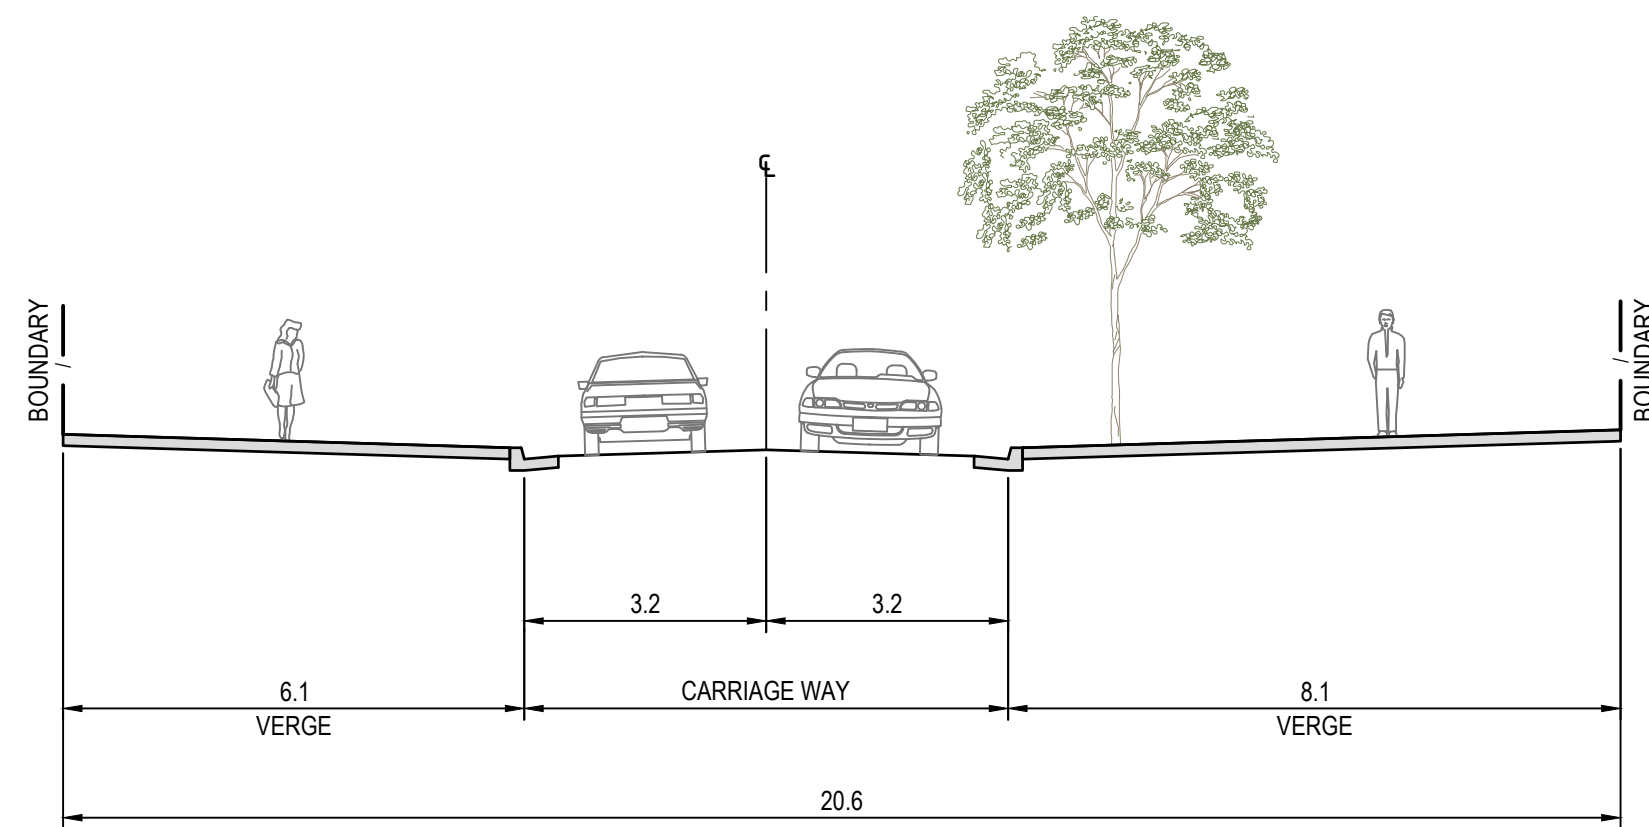
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PHILLIP STREET
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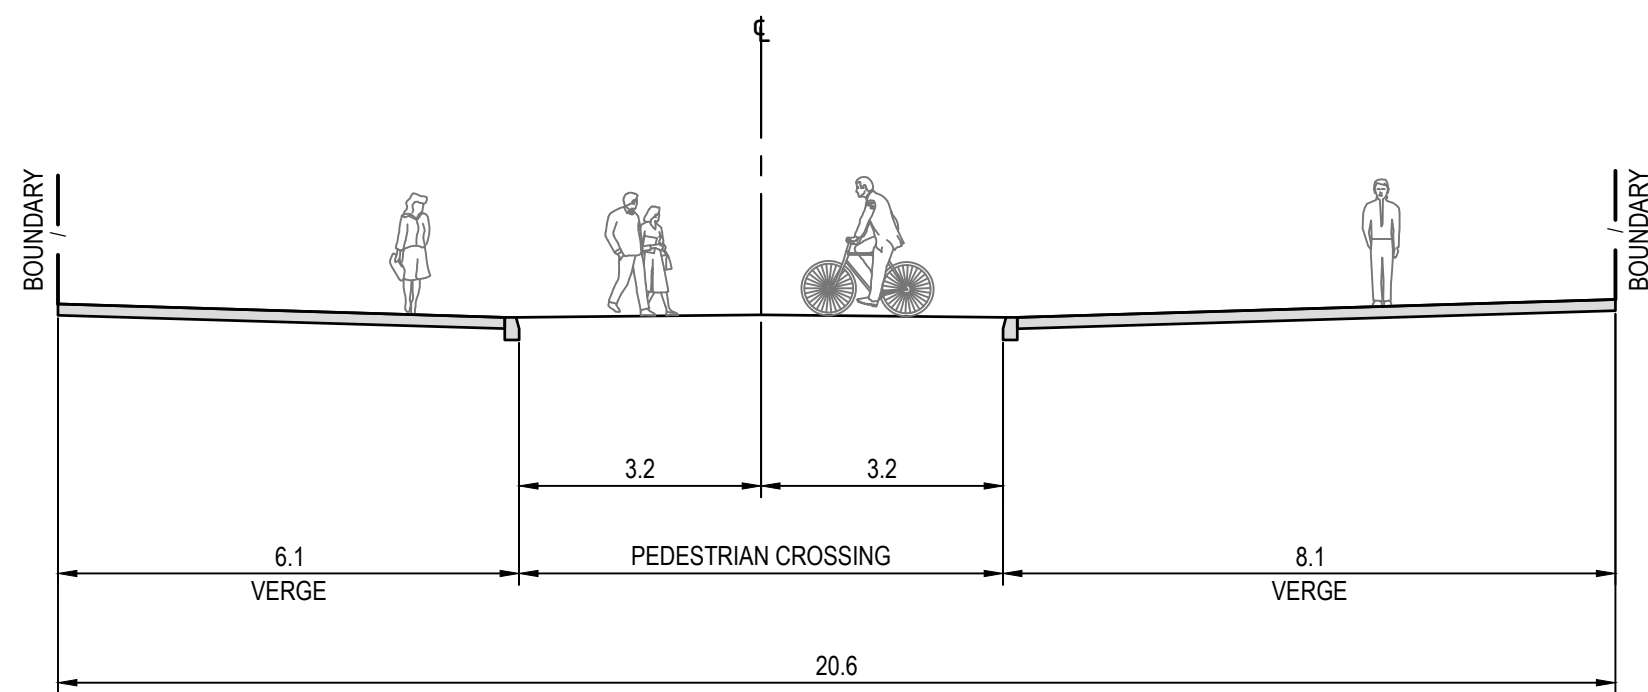
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PHILLIP STREET - RAINGARDEN
1 : 100




TYPICAL ROAD SECTION 7
PHILLIP STREET - BUS BAY AND PARKING BAY
1 : 100

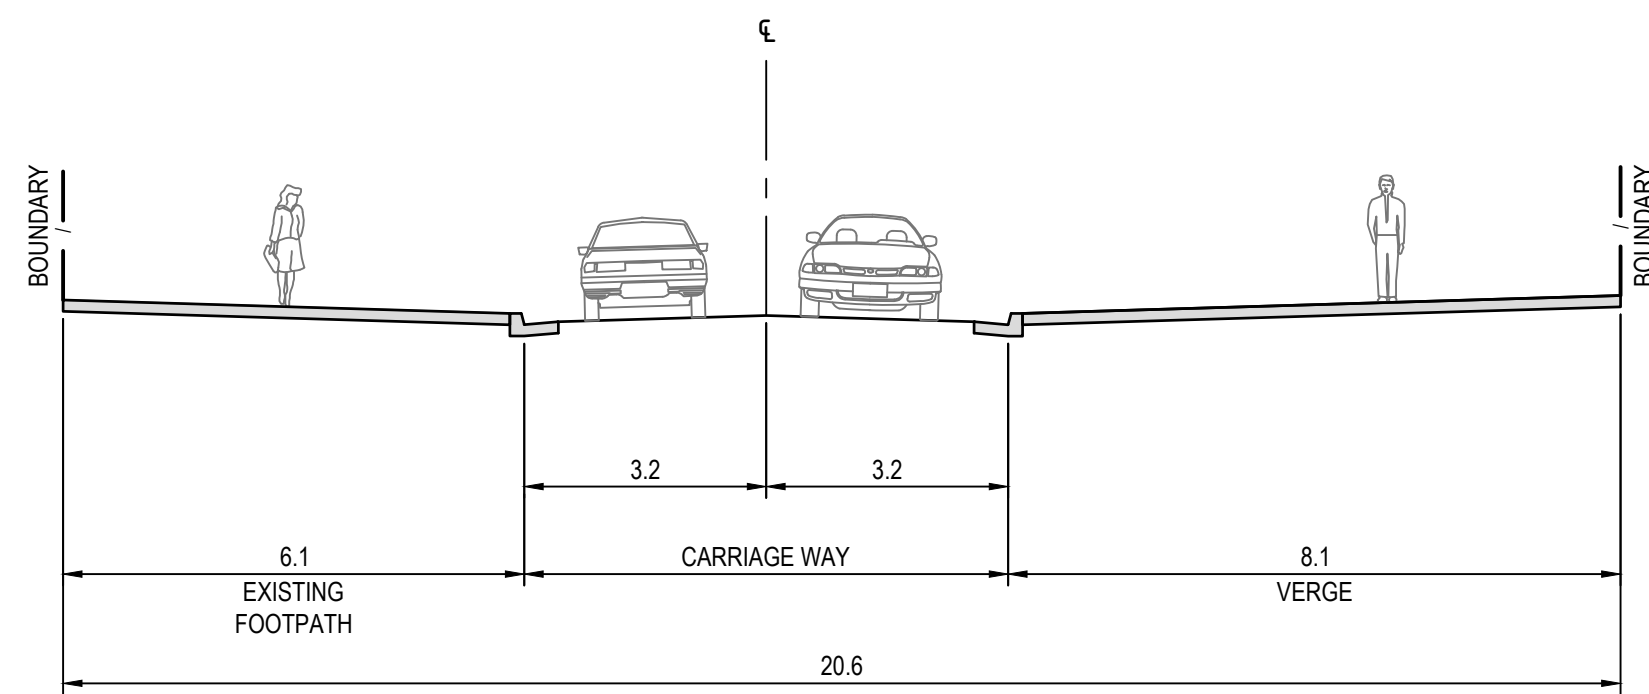

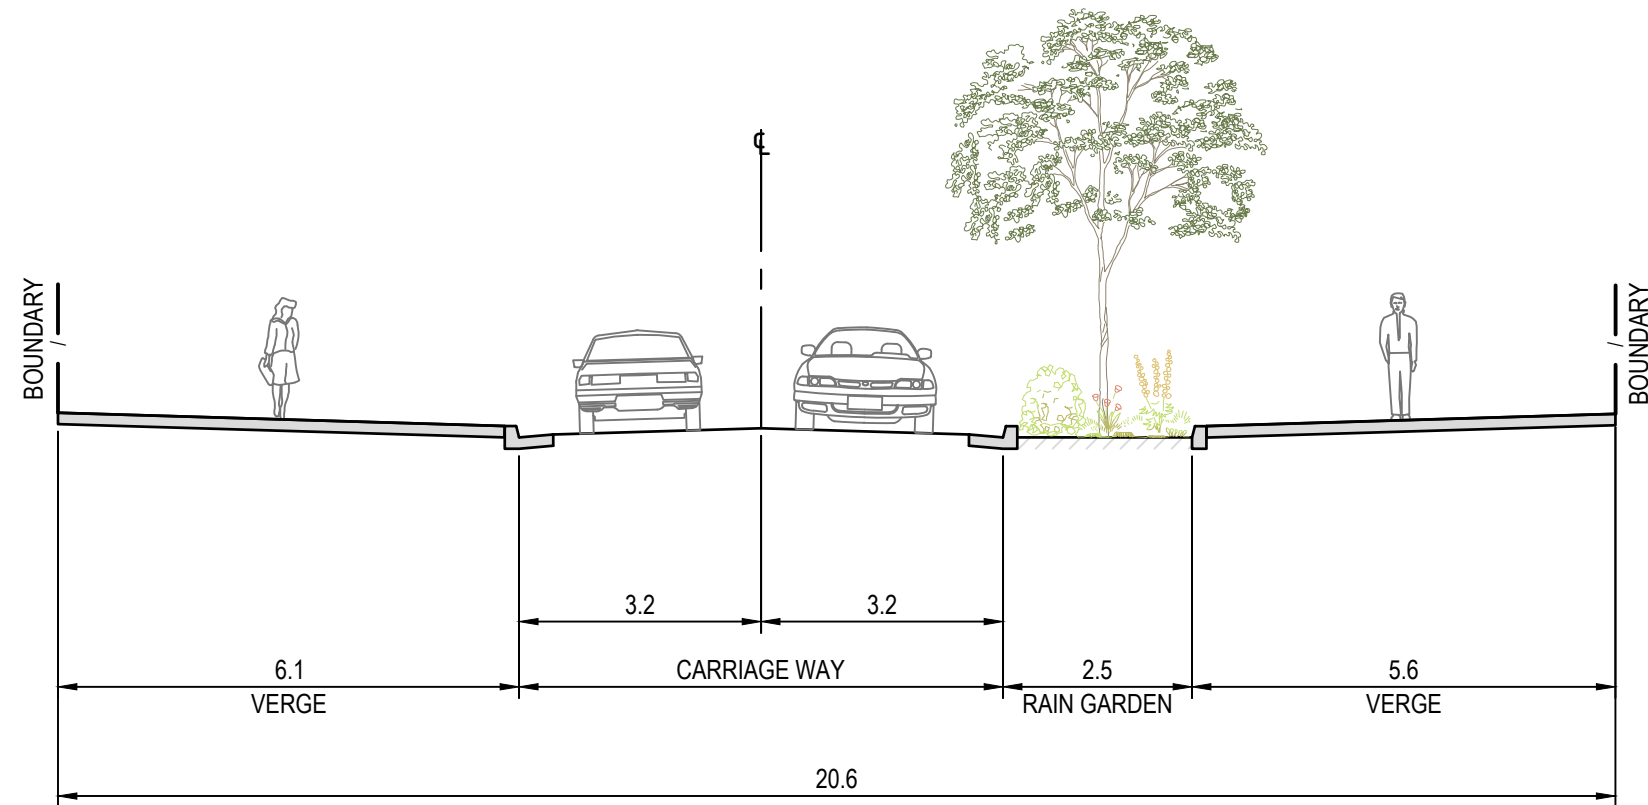
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1 : 100

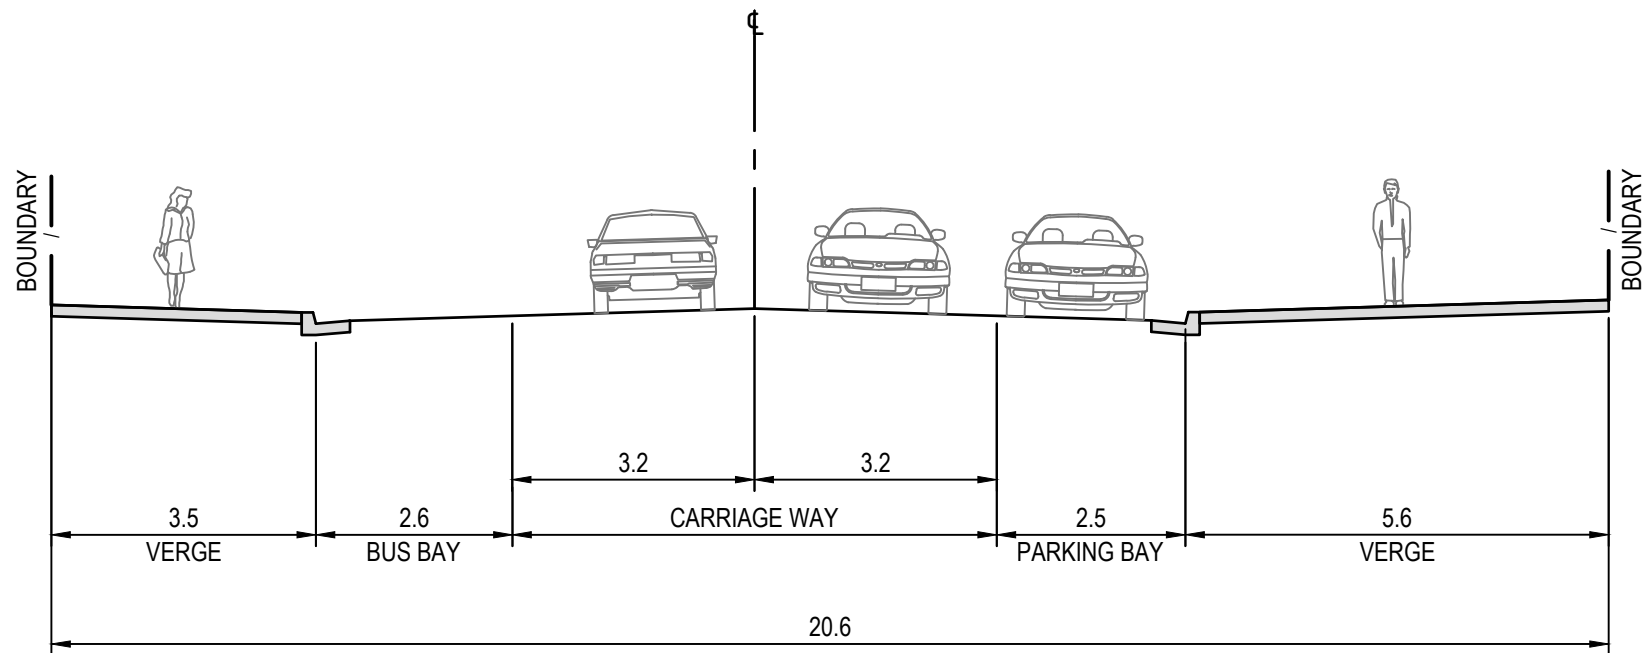


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PHILLIP STREET - RAISED PEDESTRIAN CROSSING
1 : 100

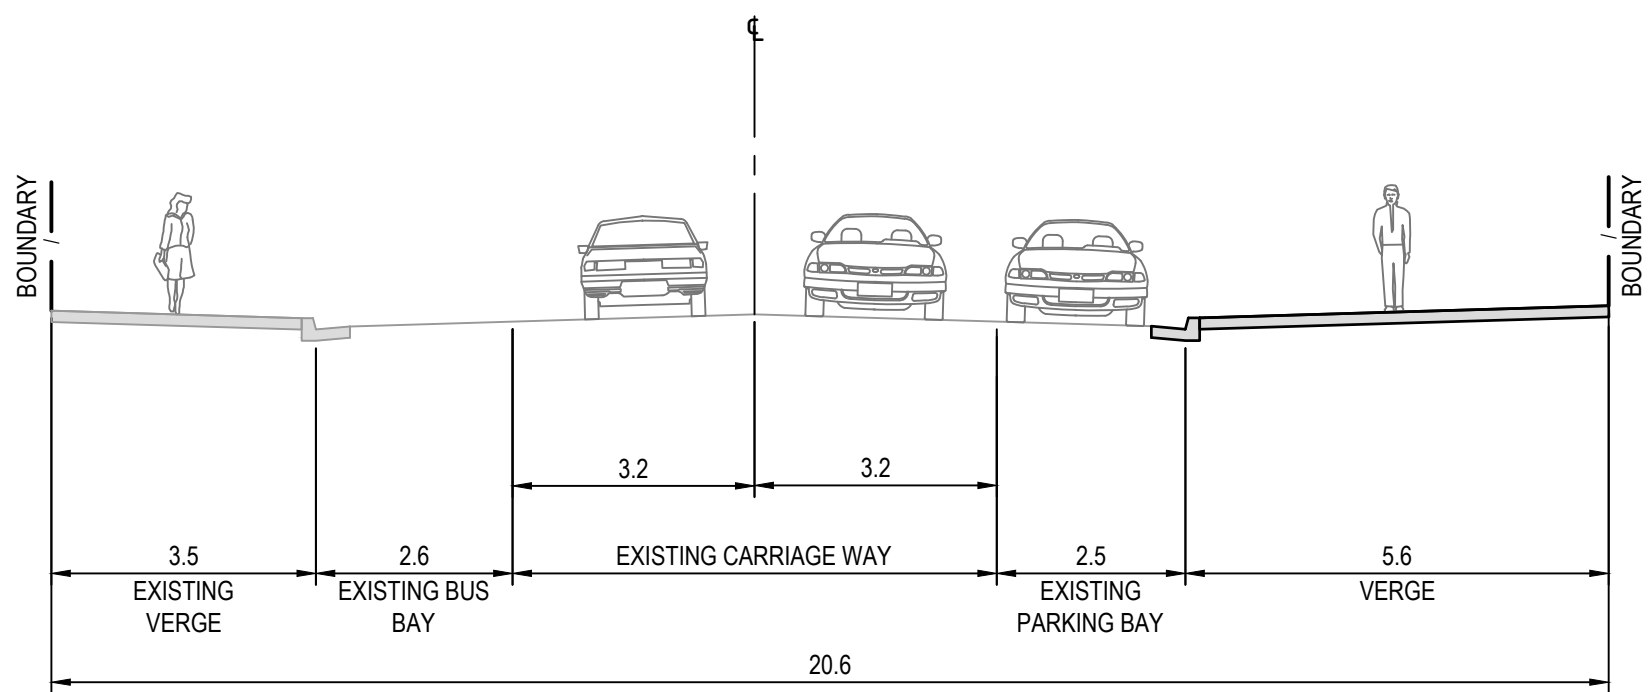


TYPICAL ROAD SECTION 8
PHILLIP STREET - PROPOSED FOOTPATH RIGHT-SIDE
1 : 100

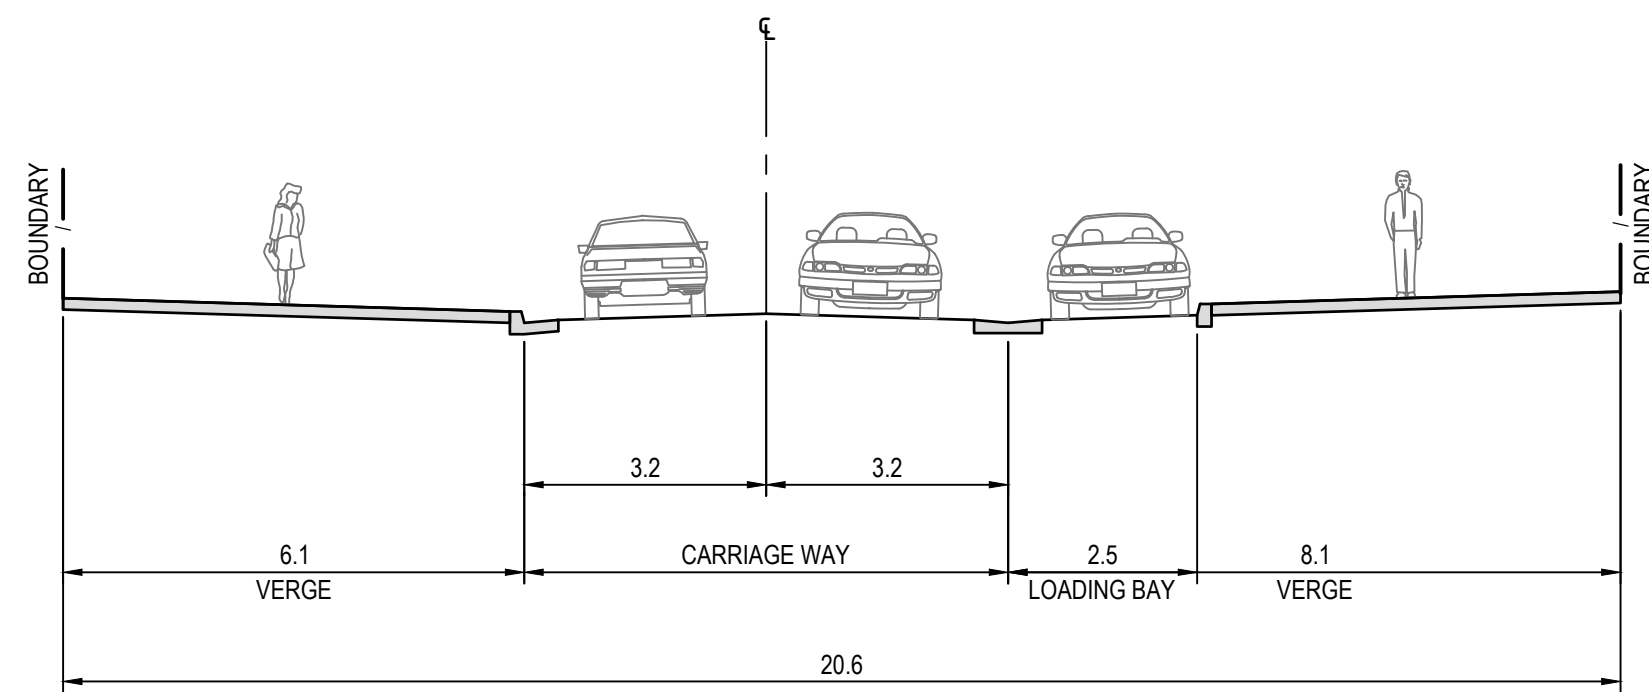

TYPICAL ROAD SECTION 3
PHILLIP STREET - LOADING BAY
1 : 100

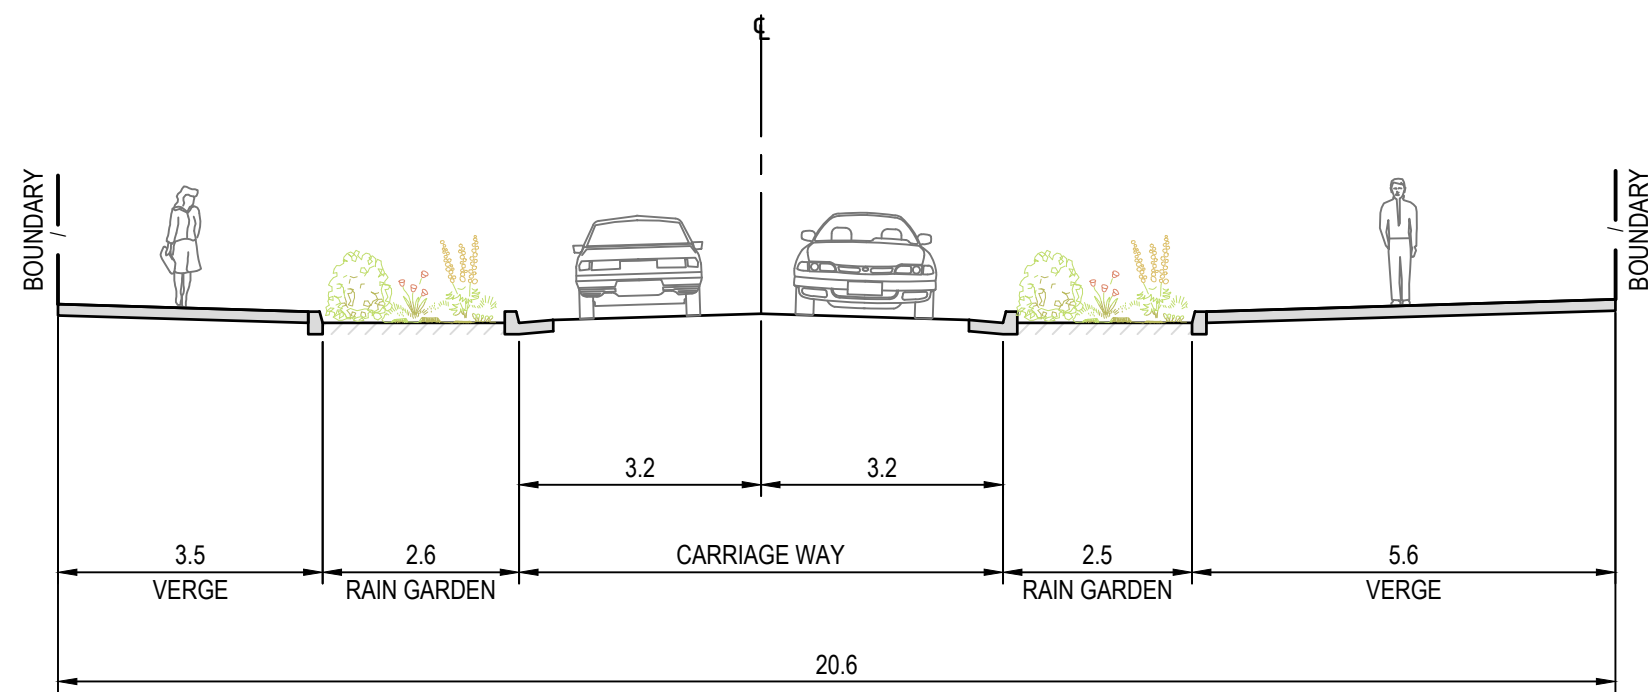


TYPICAL ROAD SECTION 6
PHILLIP STREET - RAINGARDENS
1 : 100

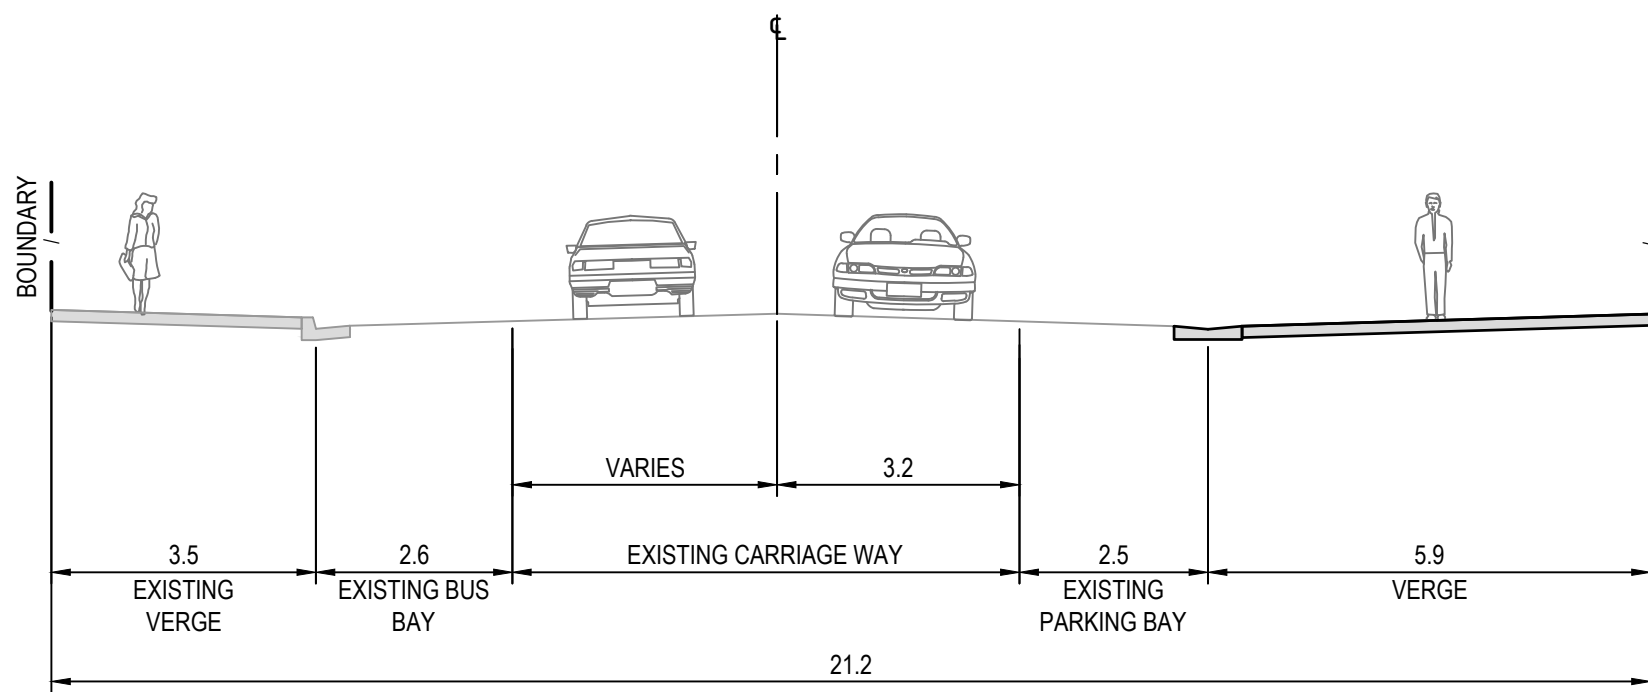

TYPICAL ROAD SECTION 9
PHILLIP STREET - EAST BOUND LANE VARIES
1 : 100

03	ISSUED FOR INFORMATION - 100% DETAILED DESIGN	RS	SG	GD	03.10.2025
02	ISSUED FOR INFORMATION - 95% DETAILED DESIGN	RS	SG	GD	10.09.2025
01	ISSUED FOR INFORMATION - 80% DETAILED DESIGN	RS	CR	MK	18.07.2025
Issue	Description	DR	CH	VE	Date

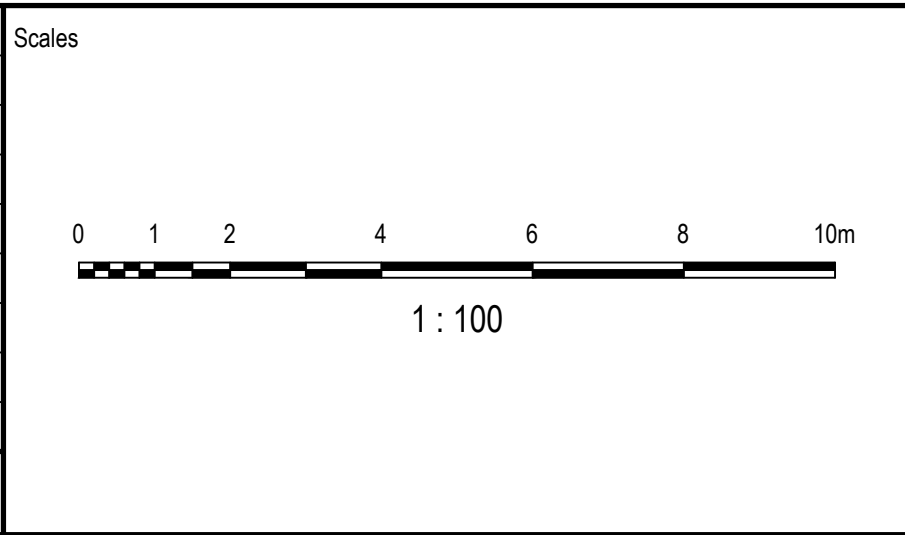

Surveyor

Architect

Client

Status

PRELIMINARY
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Original Issue Signatures

Drawn	R. SANTOS	Original Size	A1
Designed	L. CORSCADDEN	Height Datum	AHD
Project Manager	S. GEERDINK	Grid	MGA/20-56
Verified	G. DUNSTAN		

Project

PARRAMATTA
CIVIC LINK
PHILLIP STREET WORKS

Title

TYPICAL ROAD SECTIONS


Arcadis Australia Pacific Pty Limited
Level 16, 580 George Street
SYDNEY NSW 2000
ABN 76 104 485 289
Tel No: +61 2 8907 9000
www.arcadis.com/au

Project Number	30286862	Issue	03
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Drawing No.

CL3-AAP-DD-PS-DRG-CI-0241

REFER TO DRAWING CL3-AAP-DD-PS-DRG-CI-0221 FOR THE ROAD ALIGNMENT.

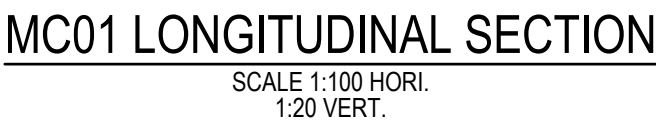

Scales

HORZ 1:100 10m


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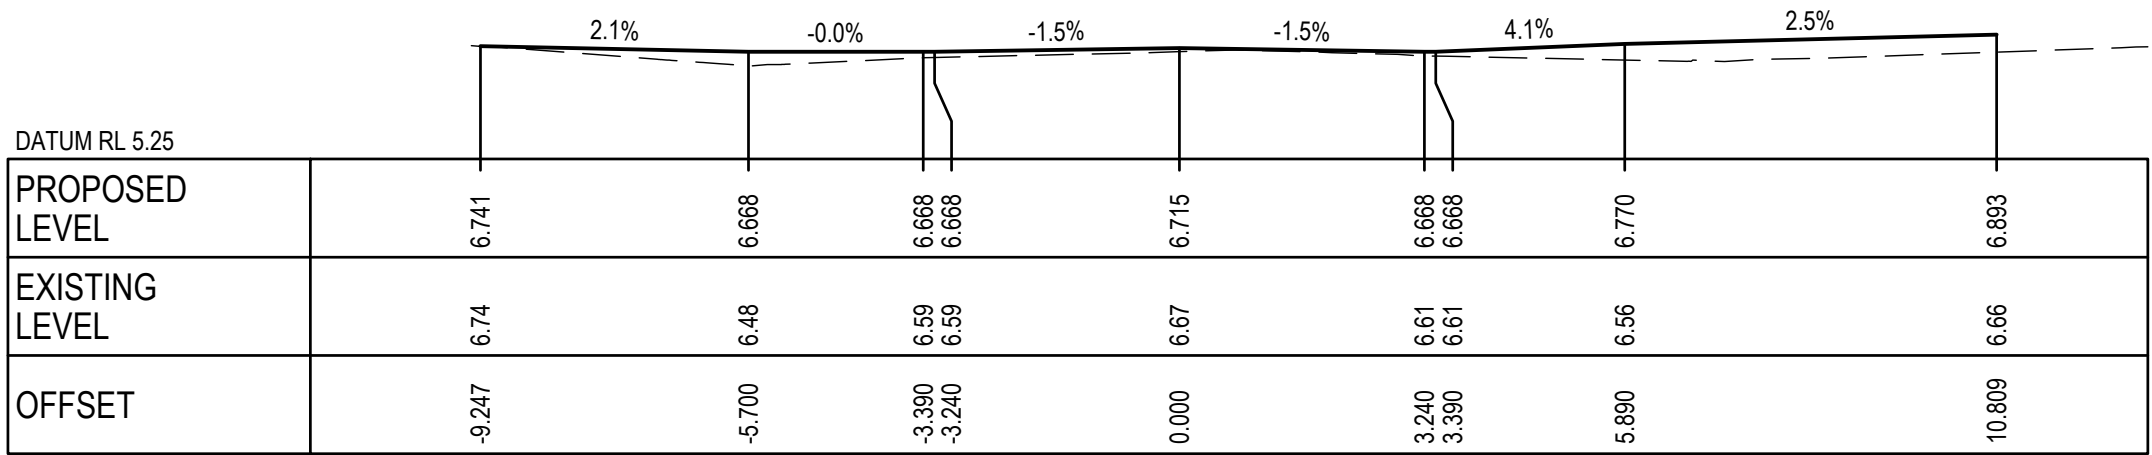
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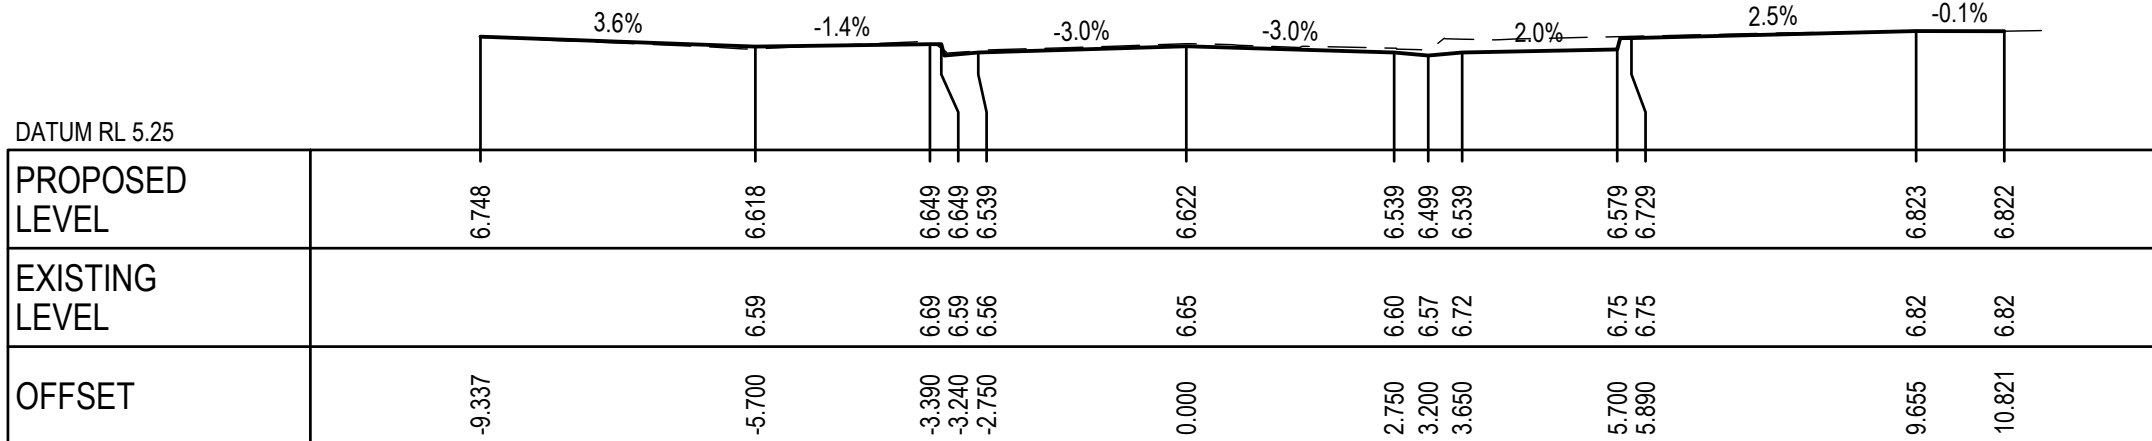
**CITY OF
PARRAMATTA**

Project	PARRAMATTA CIVIC LINK PHILLIP STREET WORKS
Title	ROAD LONGITUDINAL SECTIONS


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Drawing No. CL3-AAP-DD-PS-DRG-CI-0251			




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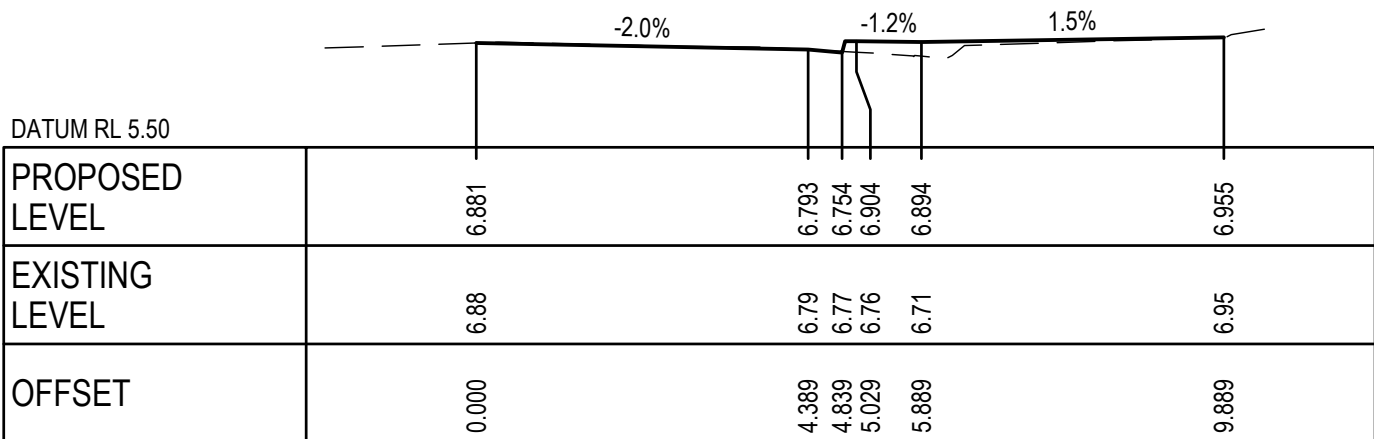
CH 20.000




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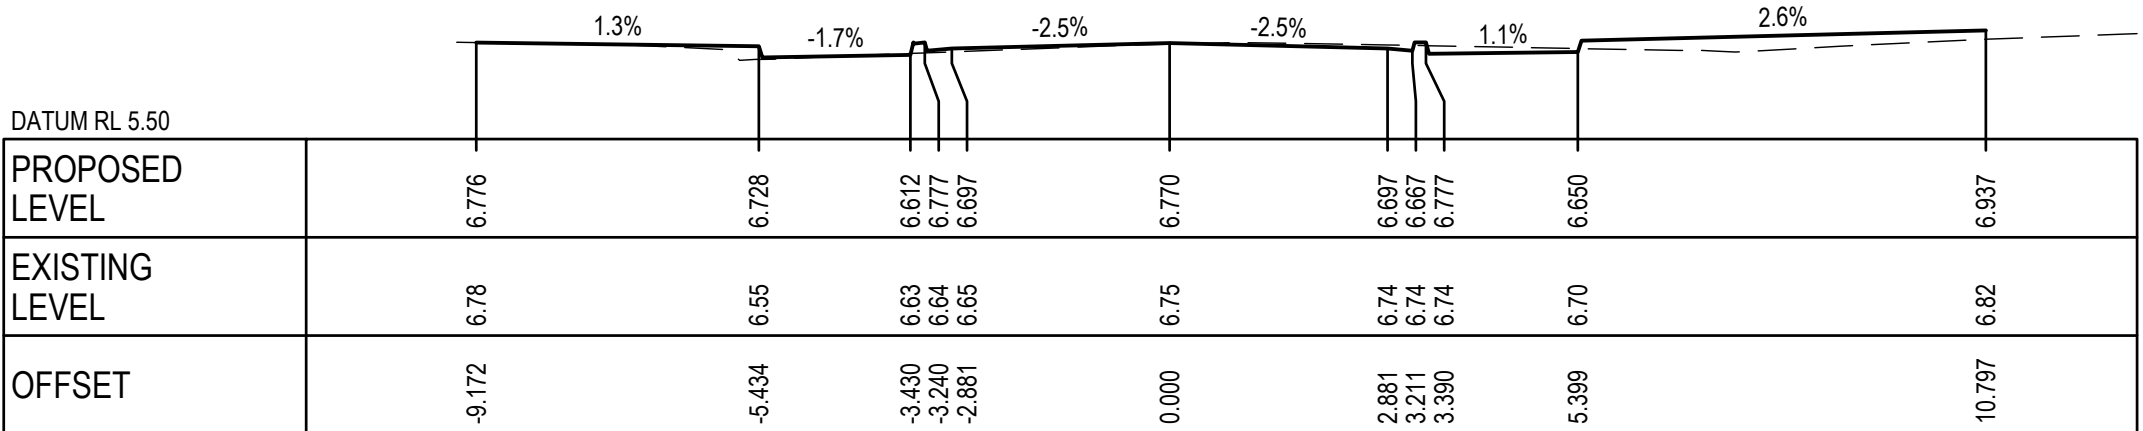
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CH 51.875

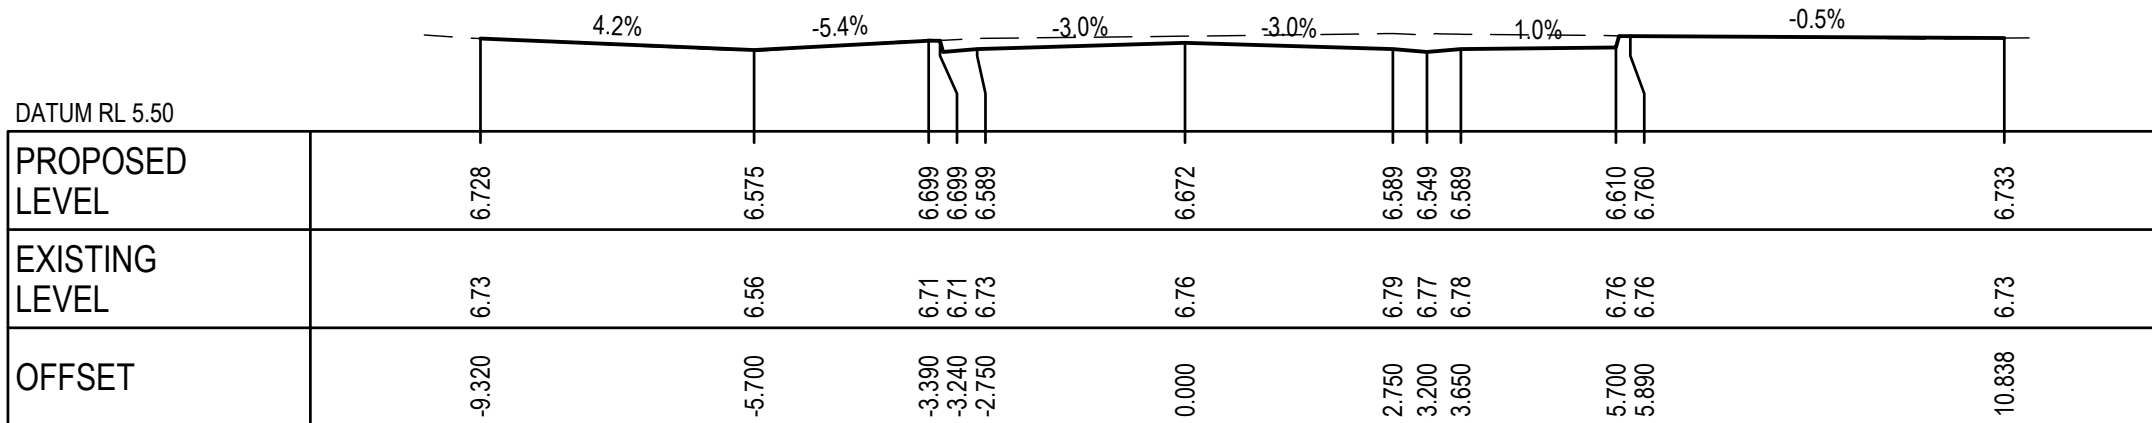


CH 50.000

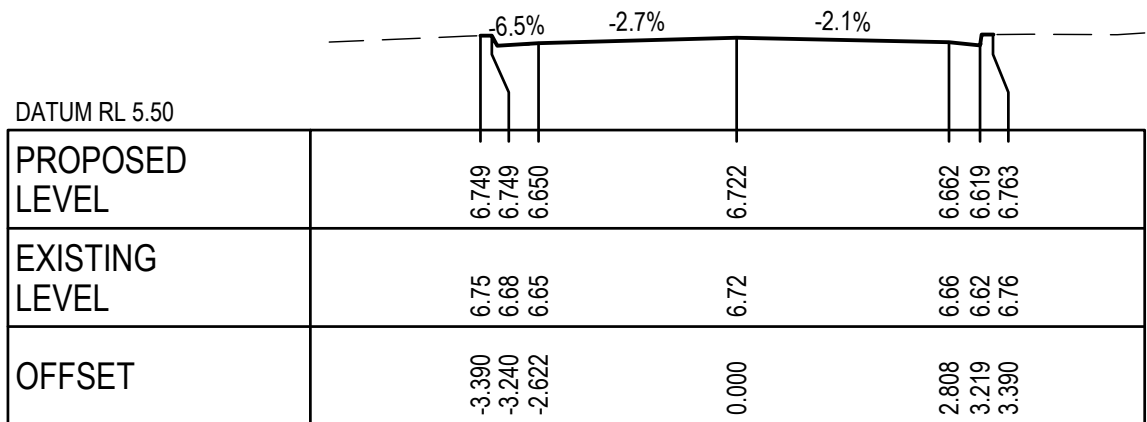

CH 40.000
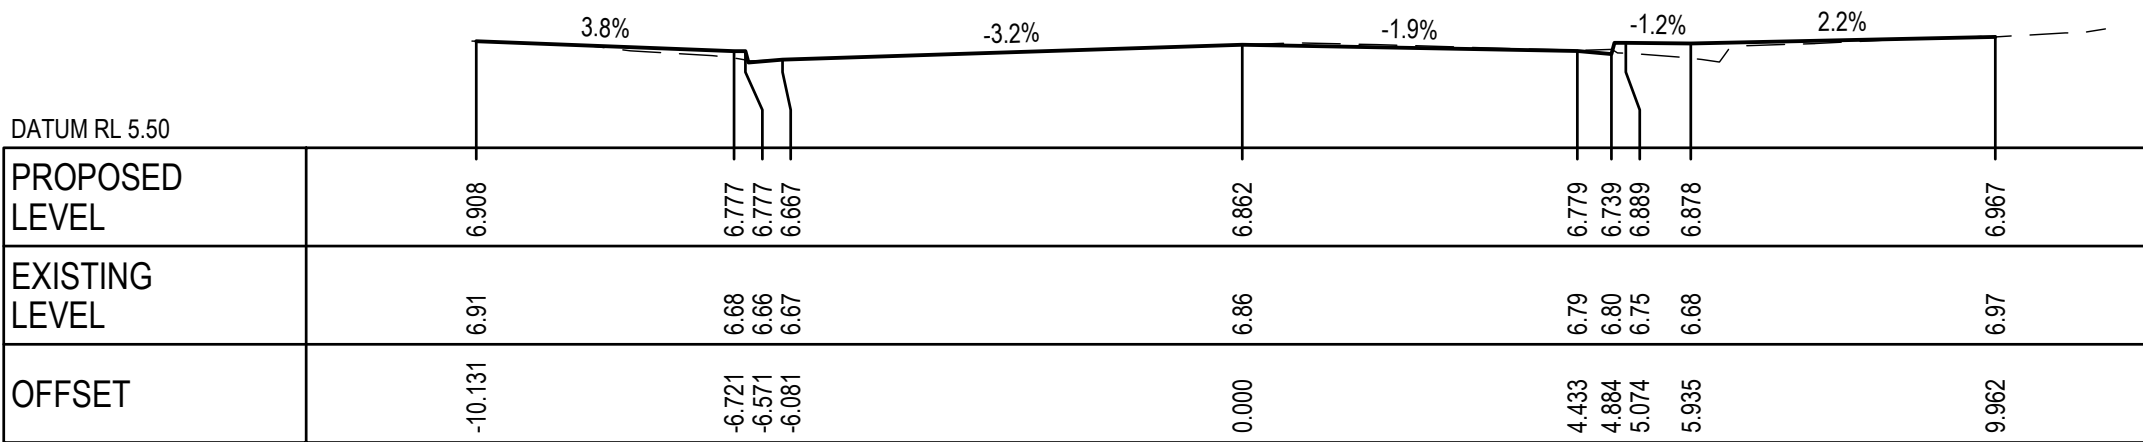
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Project Manager

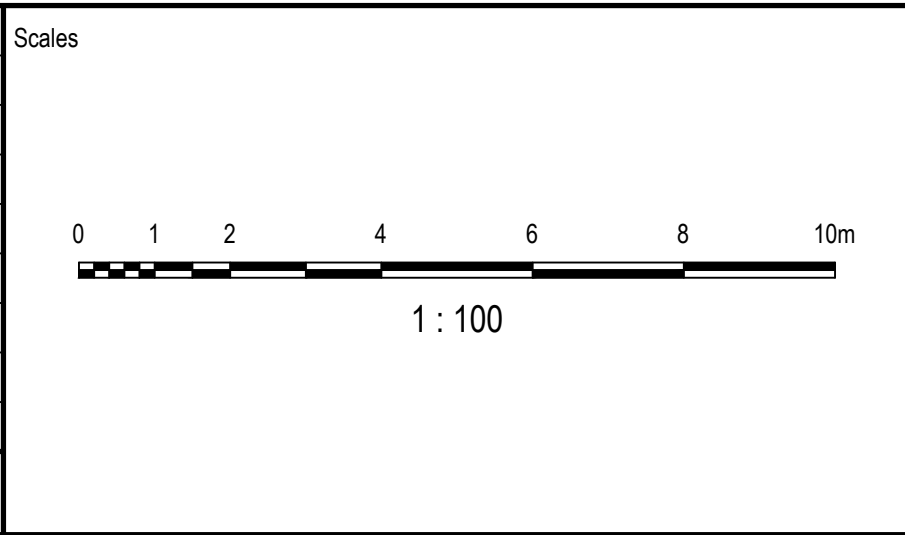S. GEERDINK

Grid

MGA/20-56

Verified

G. DUNSTAN

Project

PARRAMATTA
CIVIC LINK
PHILLIP STREET WORKS

Title

ROAD CROSS SECTIONS

Arcadis Australia Pacific Pty Limited
Level 16, 580 George Street
SYDNEY NSW 2000
ABN 76 104 485 289
Tel No: +61 2 8907 9000
www.arcadis.com/au

Project Number


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Issue

03

Drawing No.

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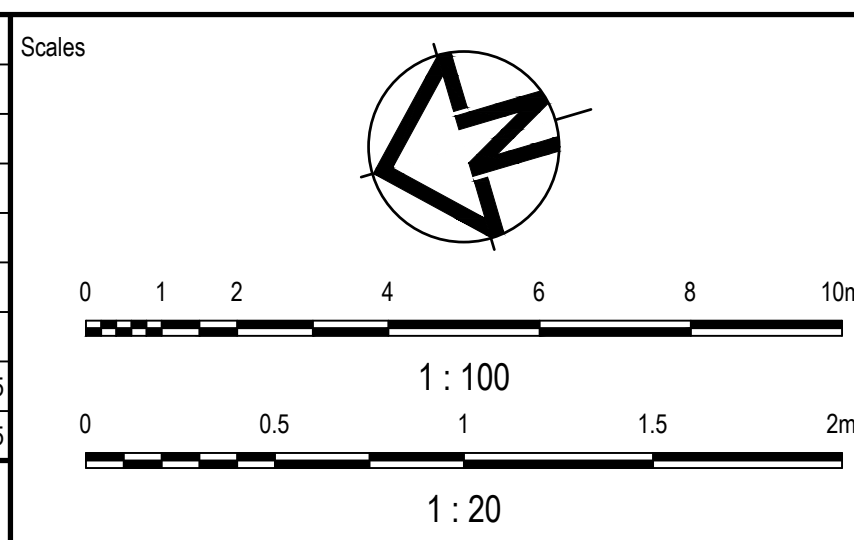


CONTROL LINE SETOUT MK02								
	PT	CHAINAGE	EASTING	NORTHING	BEARING	RAD/SPIRAL	A.LENGTH	DEFL.ANGLE
L6	BP EP	0.000 4.750	315419.458 315424.020	62566825.070 62566823.747	106° 10' 22.06"		4.750	
C1	TC IP CT	4.750 5.800 6.399	315424.020 315425.028 315425.321	62566823.747 62566823.455 62566824.463	106° 10' 22.06" 16° 10' 26.04"	R = 1.050	1.649	89°59'56.02"
L7	BP EP	6.399 7.849	315425.321 315425.725	62566824.463 62566825.856	16° 10' 26.04"		1.450	
L8	BP EP	7.849 13.153	315425.725 315430.819	62566825.856 62566824.381	106° 08' 40.31"		5.303	

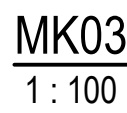
CONTROL LINE SETOUT MK03								
	PT	CHAINAGE	EASTING	NORTHING	BEARING	RAD/SPIRAL	A.LENGTH	DEFLANGLE
L9	BP EP	0.000 0.652	315455.545 315454.918	6256804.946 6256805.127	286° 08' 53.50"		0.652	
L10	BP EP	0.652 9.773	315454.918 315446.601	6256805.127 6256808.869	294° 13' 18.94"		9.120	
L11	BP EP	9.773 34.477	315446.601 315422.874	6256808.869 6256815.750	286° 10' 22.07"		24.704	
L12	BP EP	34.477 35.926	315422.874 315423.279	6256815.750 6256817.142	16° 12' 34.13"		1.449	
C2	TC IP CT	35.926 36.977 37.576	315423.279 315423.572 315422.563	6256817.142 6256818.151 6256818.443	16° 12' 34.13" 286° 10' 22.08"	R = 1.050	1.650	90°02'12.05"
L13	BP EP	37.576 42.674	315422.563 315417.667	6256818.443 6256819.863	286° 10' 22.08"		5.098	



02	ISSUED FOR INFORMATION - 100% DETAILED DESIGN	RS	SG	GD	03.10.2025
01	ISSUED FOR INFORMATION - 95% DETAILED DESIGN	RS	SG	MK	10.09.2025
Issue	Description	DR	CH	VE	Date



Surveyor

 **DURKIN**

Architect


OCULUS




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© Copyright reserved			
Original Issue Signatures			
Drawn	R. SANTOS	Original Size	A1
Designed	L. CORSCADDEN	Height Datum	AHD
Project Manager	S. GEERDINK	Grid	MGA/20-56
Verified	G. DUNSTAN		

Project	PARRAMATTA CIVIC LINK PHILLIP STREET WORKS
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KERB RETURNS
SHEET 1




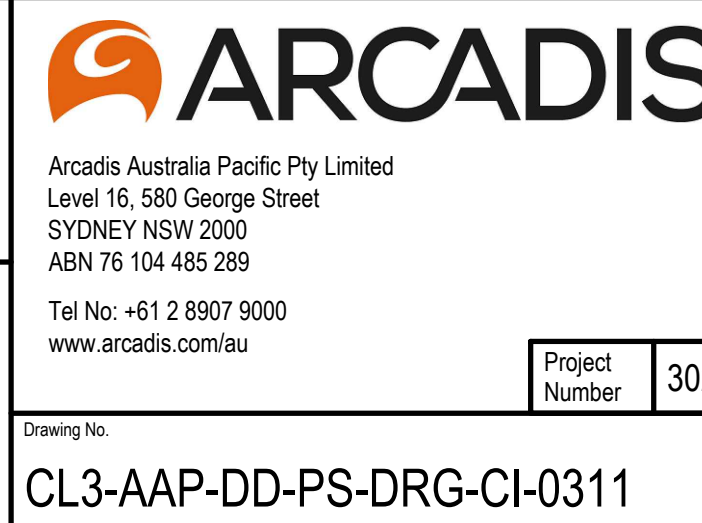

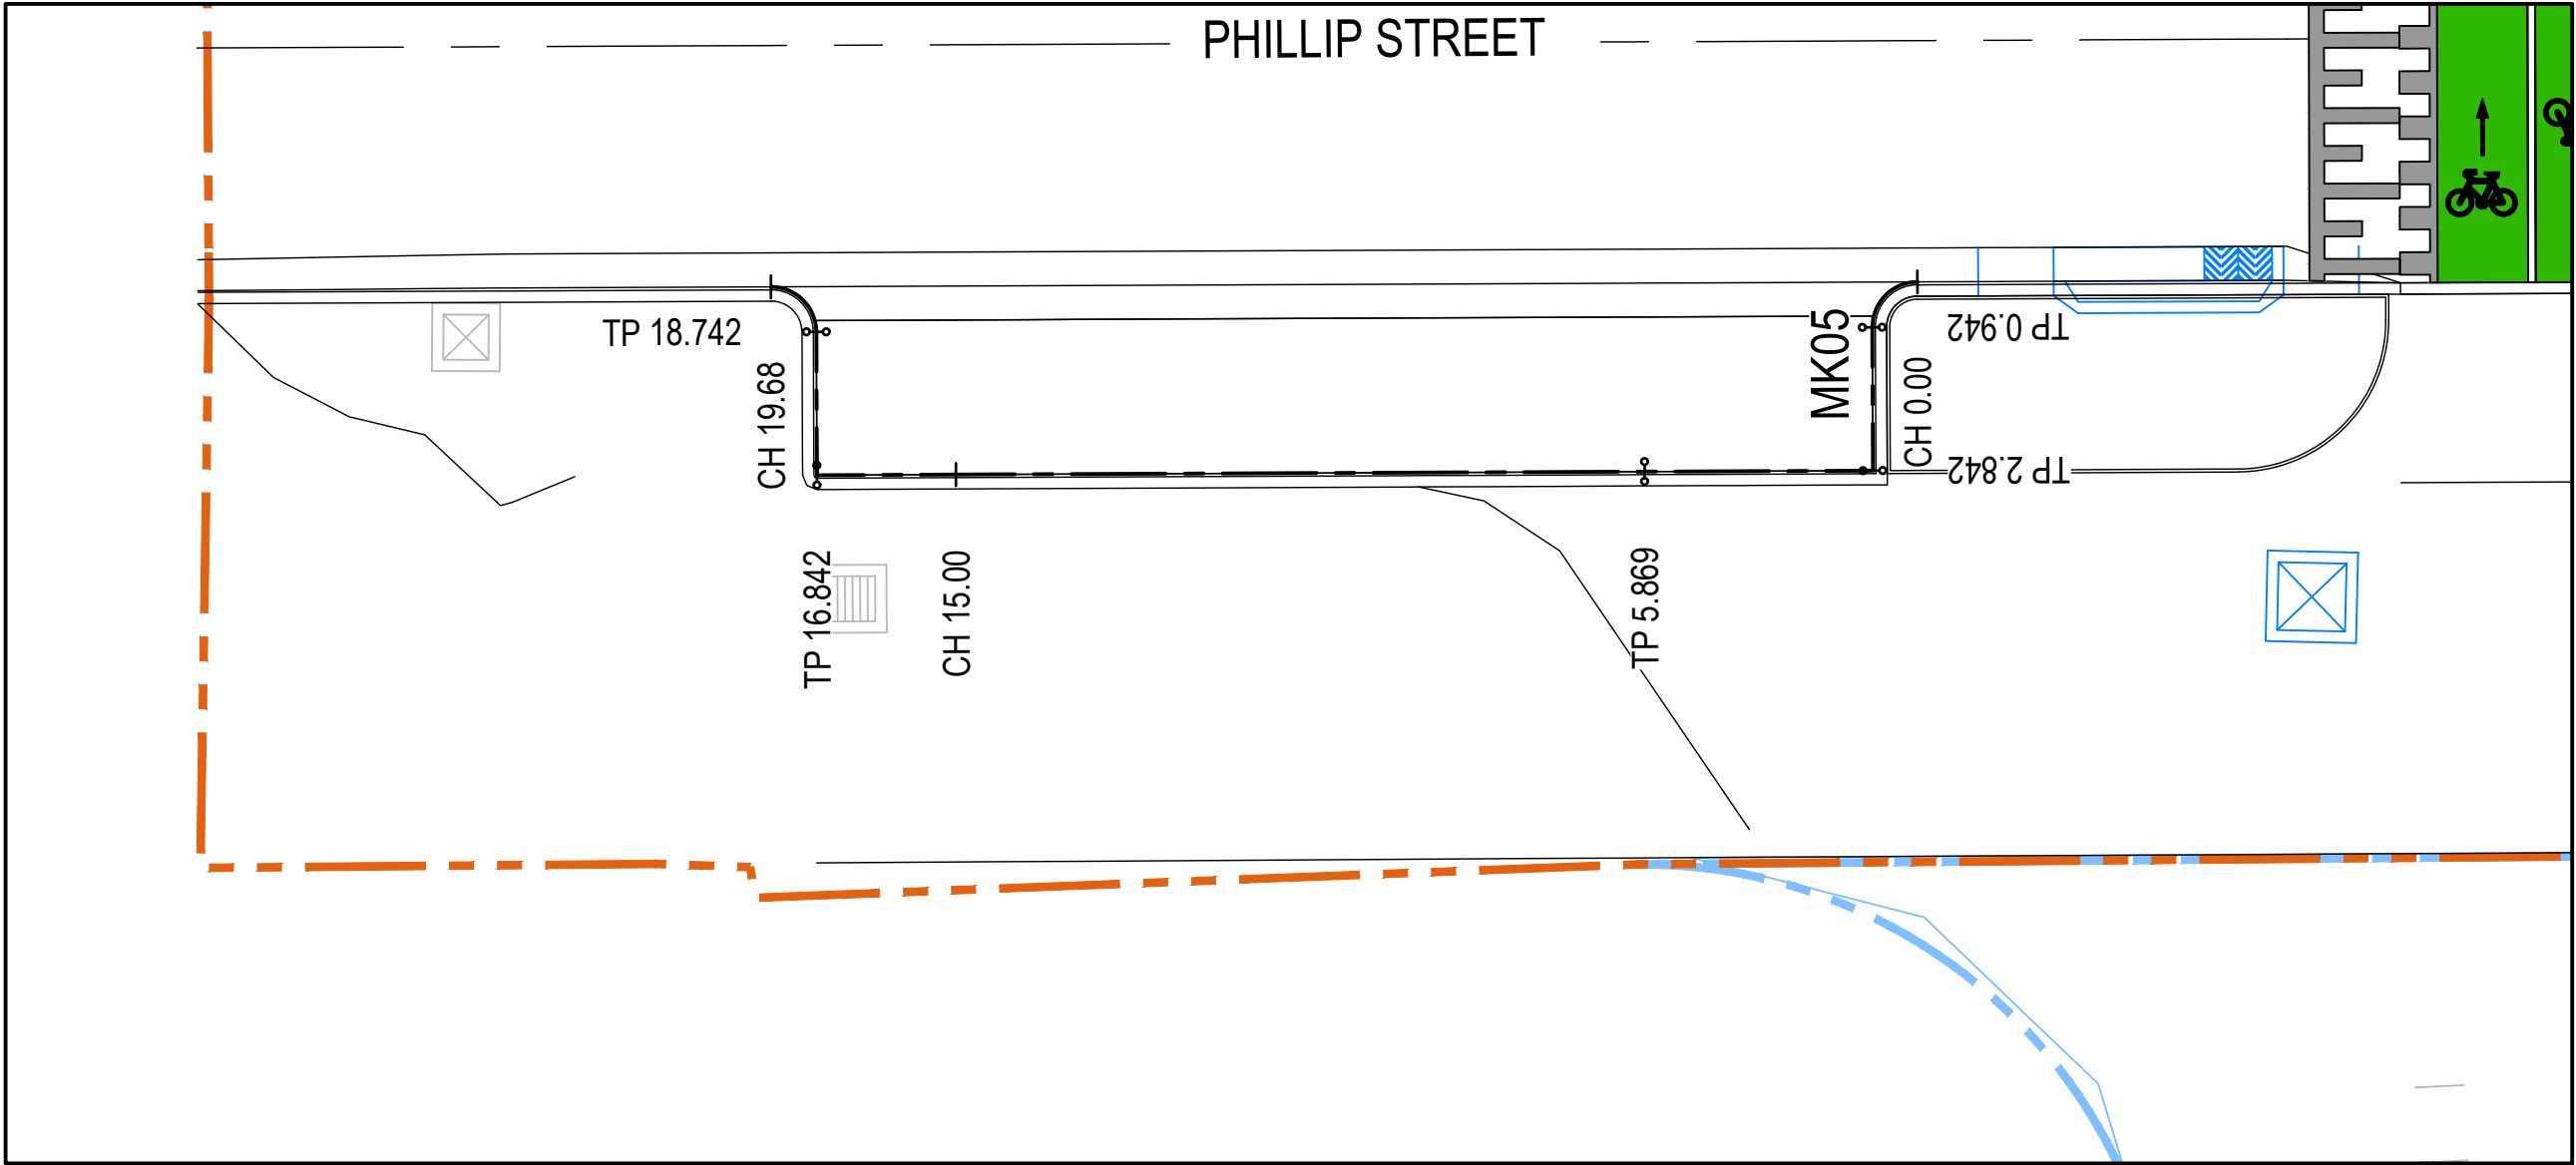MK05
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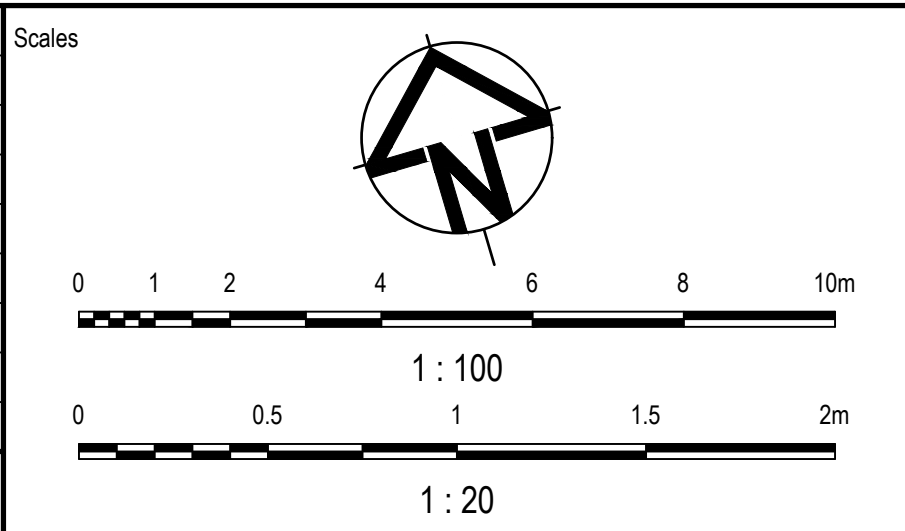
CONTROL LINE SETOUT MK05								
	PT	CHAINAGE	EASTING	NORTHING	BEARING	RAD/SPIRAL	A.LENGTH	DEFL.ANGLE
C3	TC	0.000	315400.635	6256824.334	286° 10' 22.43"	R = 0.600	0.942	90°00'00.43"
	IP	0.600	315400.058	6256824.501				
	CT	0.942	315399.891	6256823.925	196° 10' 22.00"			
L17	BP	0.942	315399.891	6256823.925	196° 10' 21.97"		1.900	
	EP	2.842	315399.362	6256822.100				
L18	BP	2.842	315399.362	6256822.100	286° 10' 22.09°		3.027	
	EP	5.869	315396.455	6256822.943				
L19	BP	5.869	315396.455	6256822.943	286° 10' 22.07°		10.973	
	EP	16.842	315385.916	6256826.000				
	CT	19.342	315386.036	6256828.568	286° 10' 22.07°			
C4	TC	16.842	315385.916	6256826.000	16° 10' 22.00°	R = 0.600	1.900	90°00'00.00°
	IP	18.742	315386.446	6256827.824				
	CT	19.342	315386.036	6256828.568	286° 10' 22.07°			

LEGEND	
	HORWOOD PLACE WORKS SITE BOUNDARY
	PHILLIP STREET WORKS SITE BOUNDARY
	CHAINAGE AND CONTROL LINE
	PROPOSED KERB INLET PIT
	PROPOSED JUNCTION PIT
	PROPOSED BUTTERFLY GRATED PIT
	EXISTING JUNCTION PIT
	EXISTING GRATED PIT

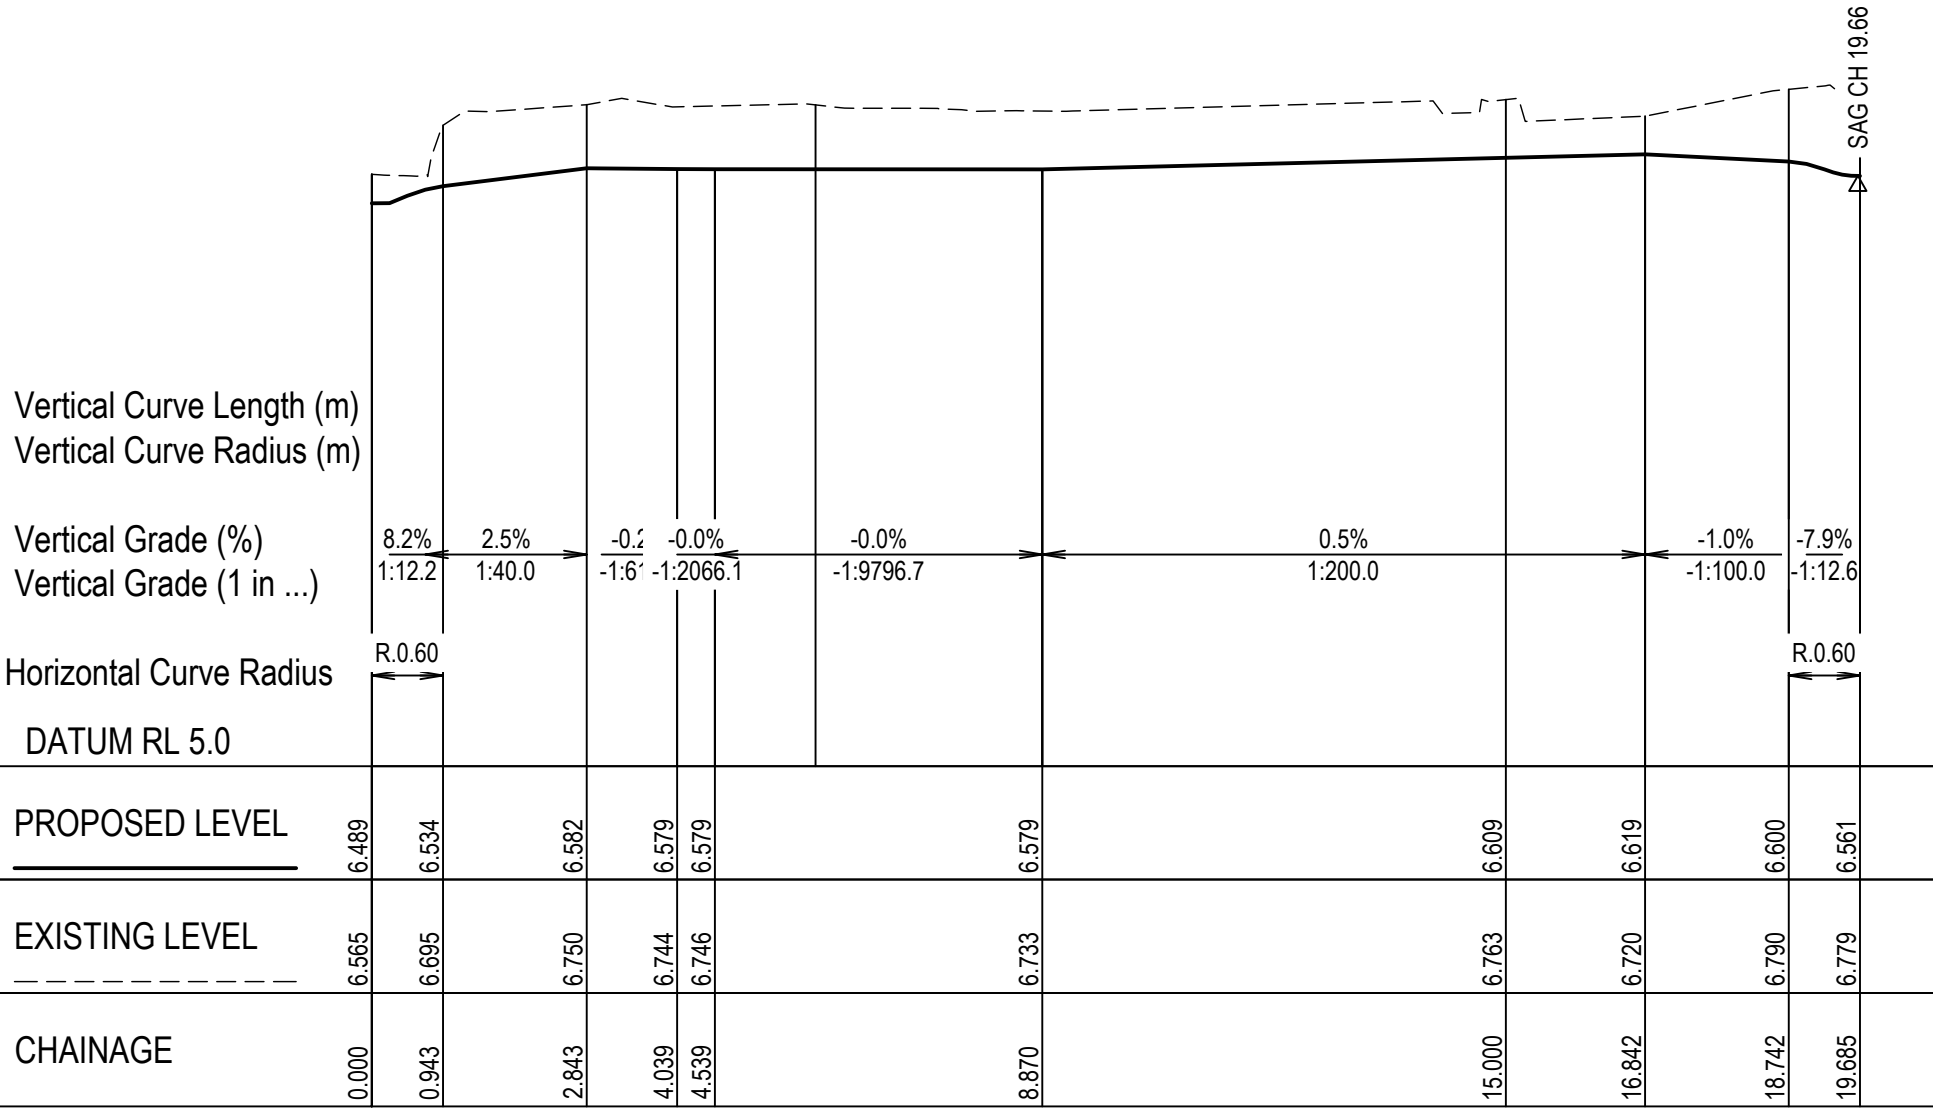

MK05 LONGITUDINAL SECTION
SCALE 1:100 HORI.
1:20 VERT.

02	ISSUED FOR INFORMATION - 100% DETAILED DESIGN	RS	SG	GD	03.10.2025
01	ISSUED FOR INFORMATION - 95% DETAILED DESIGN	RS	SG	MK	10.09.2025
Issue	Description	DR	CH	VE	Date




Surveyor	DURKIN
Architect	OCULUS

Client	CITY OF PARRAMATTA
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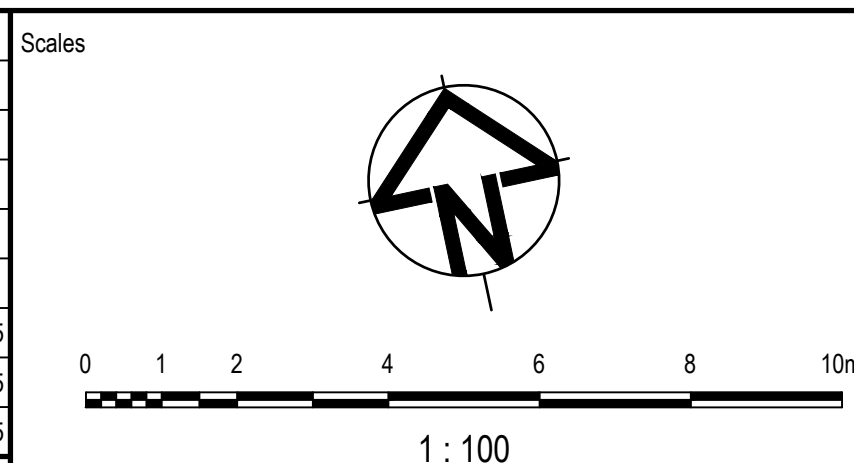
Status	PRELIMINARY NOT TO BE USED FOR CONSTRUCTION		
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Original Issue Signatures			
Drawn	R. SANTOS	Original Size	A1
Designed	L. CORSCADDEN	Height Datum	AHD
Project Manager	S. GEERDINK	Grid	MGA/20-56
Verified	G. DUNSTAN		

Project	PARRAMATTA CIVIC LINK PHILLIP STREET WORKS	
Title	KERB RETURNS SHEET 2	

		Project Number	30286862	Issue	02
Arcadis Australia Pacific Pty Limited Level 16, 580 George Street SYDNEY NSW 2000 ABN 76 104 485 289 Tel No: +61 2 8907 9000 www.arcadis.com/au		CL3-AAP-DD-PS-DRG-CI-0312			
Drawing No.					

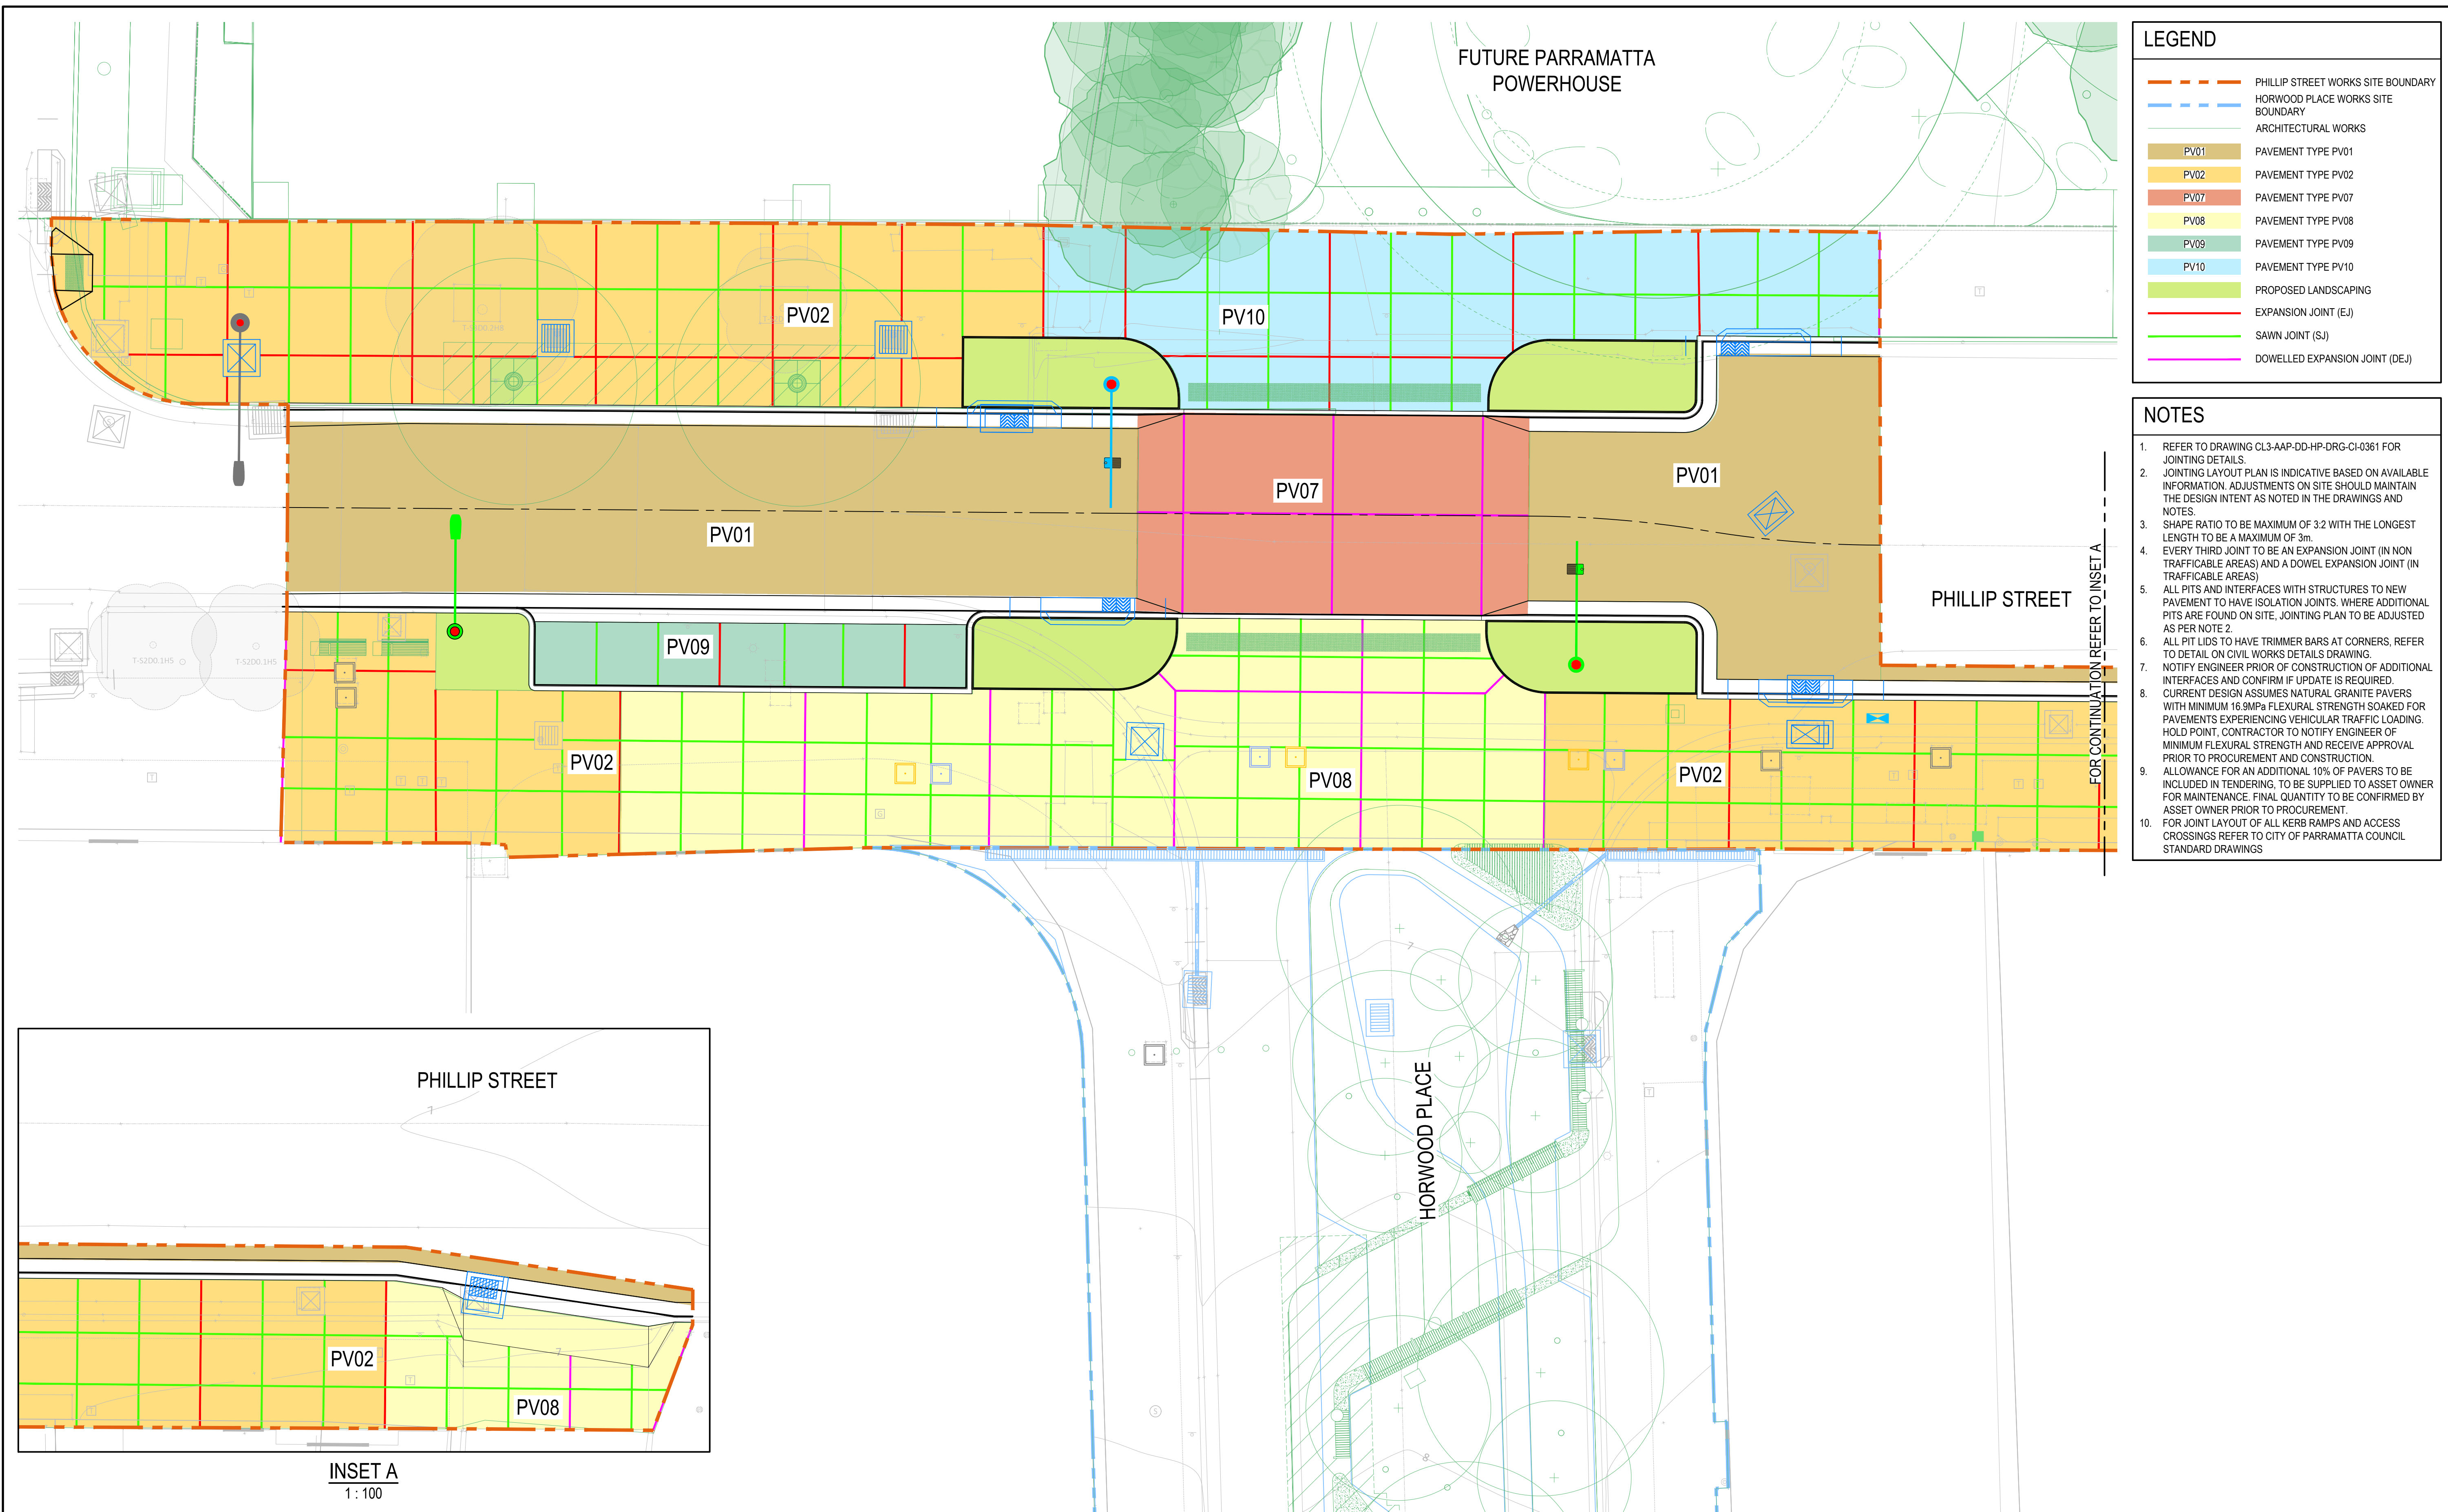

03	ISSUED FOR INFORMATION - 100% DETAILED DESIGN	RS	SG	GD	03.10.2025
02	ISSUED FOR INFORMATION - 95% DETAILED DESIGN	RS	SG	GD	10.09.2025
01	ISSUED FOR INFORMATION - 80% DETAILED DESIGN	RS	CR	MK	18.07.2025
Issue	Description	DR	CH	VE	Date



Surveyor

surveyplus

DURKIN

Architect

OCULUS



Status	<h1 style="text-align: center;">PRELIMINARY</h1> <h2 style="text-align: center;">NOT TO BE USED FOR CONSTRUCTION</h2>		
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Original Issue Signatures			
Drawn	R. SANTOS	Original Size	A1
Designed	L. CORSCADDEN	Height Datum	AHD
Project Manager	S. GEERDINK	Grid	MGA/20-56
Verified	G. DUNSTAN		

Project	PARRAMATTA CIVIC LINK PHILLIP STREET WORKS
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PAVEMENT PLAN




Arcadis Australia Pacific Pty Limited
Level 16, 580 George Street
SYDNEY NSW 2000
ABN 76 104 485 289

Tel No: +61 2 8907 9000
www.arcadis.com/au


Project Number	30286862
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Drawing No.
CL3-AAP-DD-PS-DRG-CI-0341

03

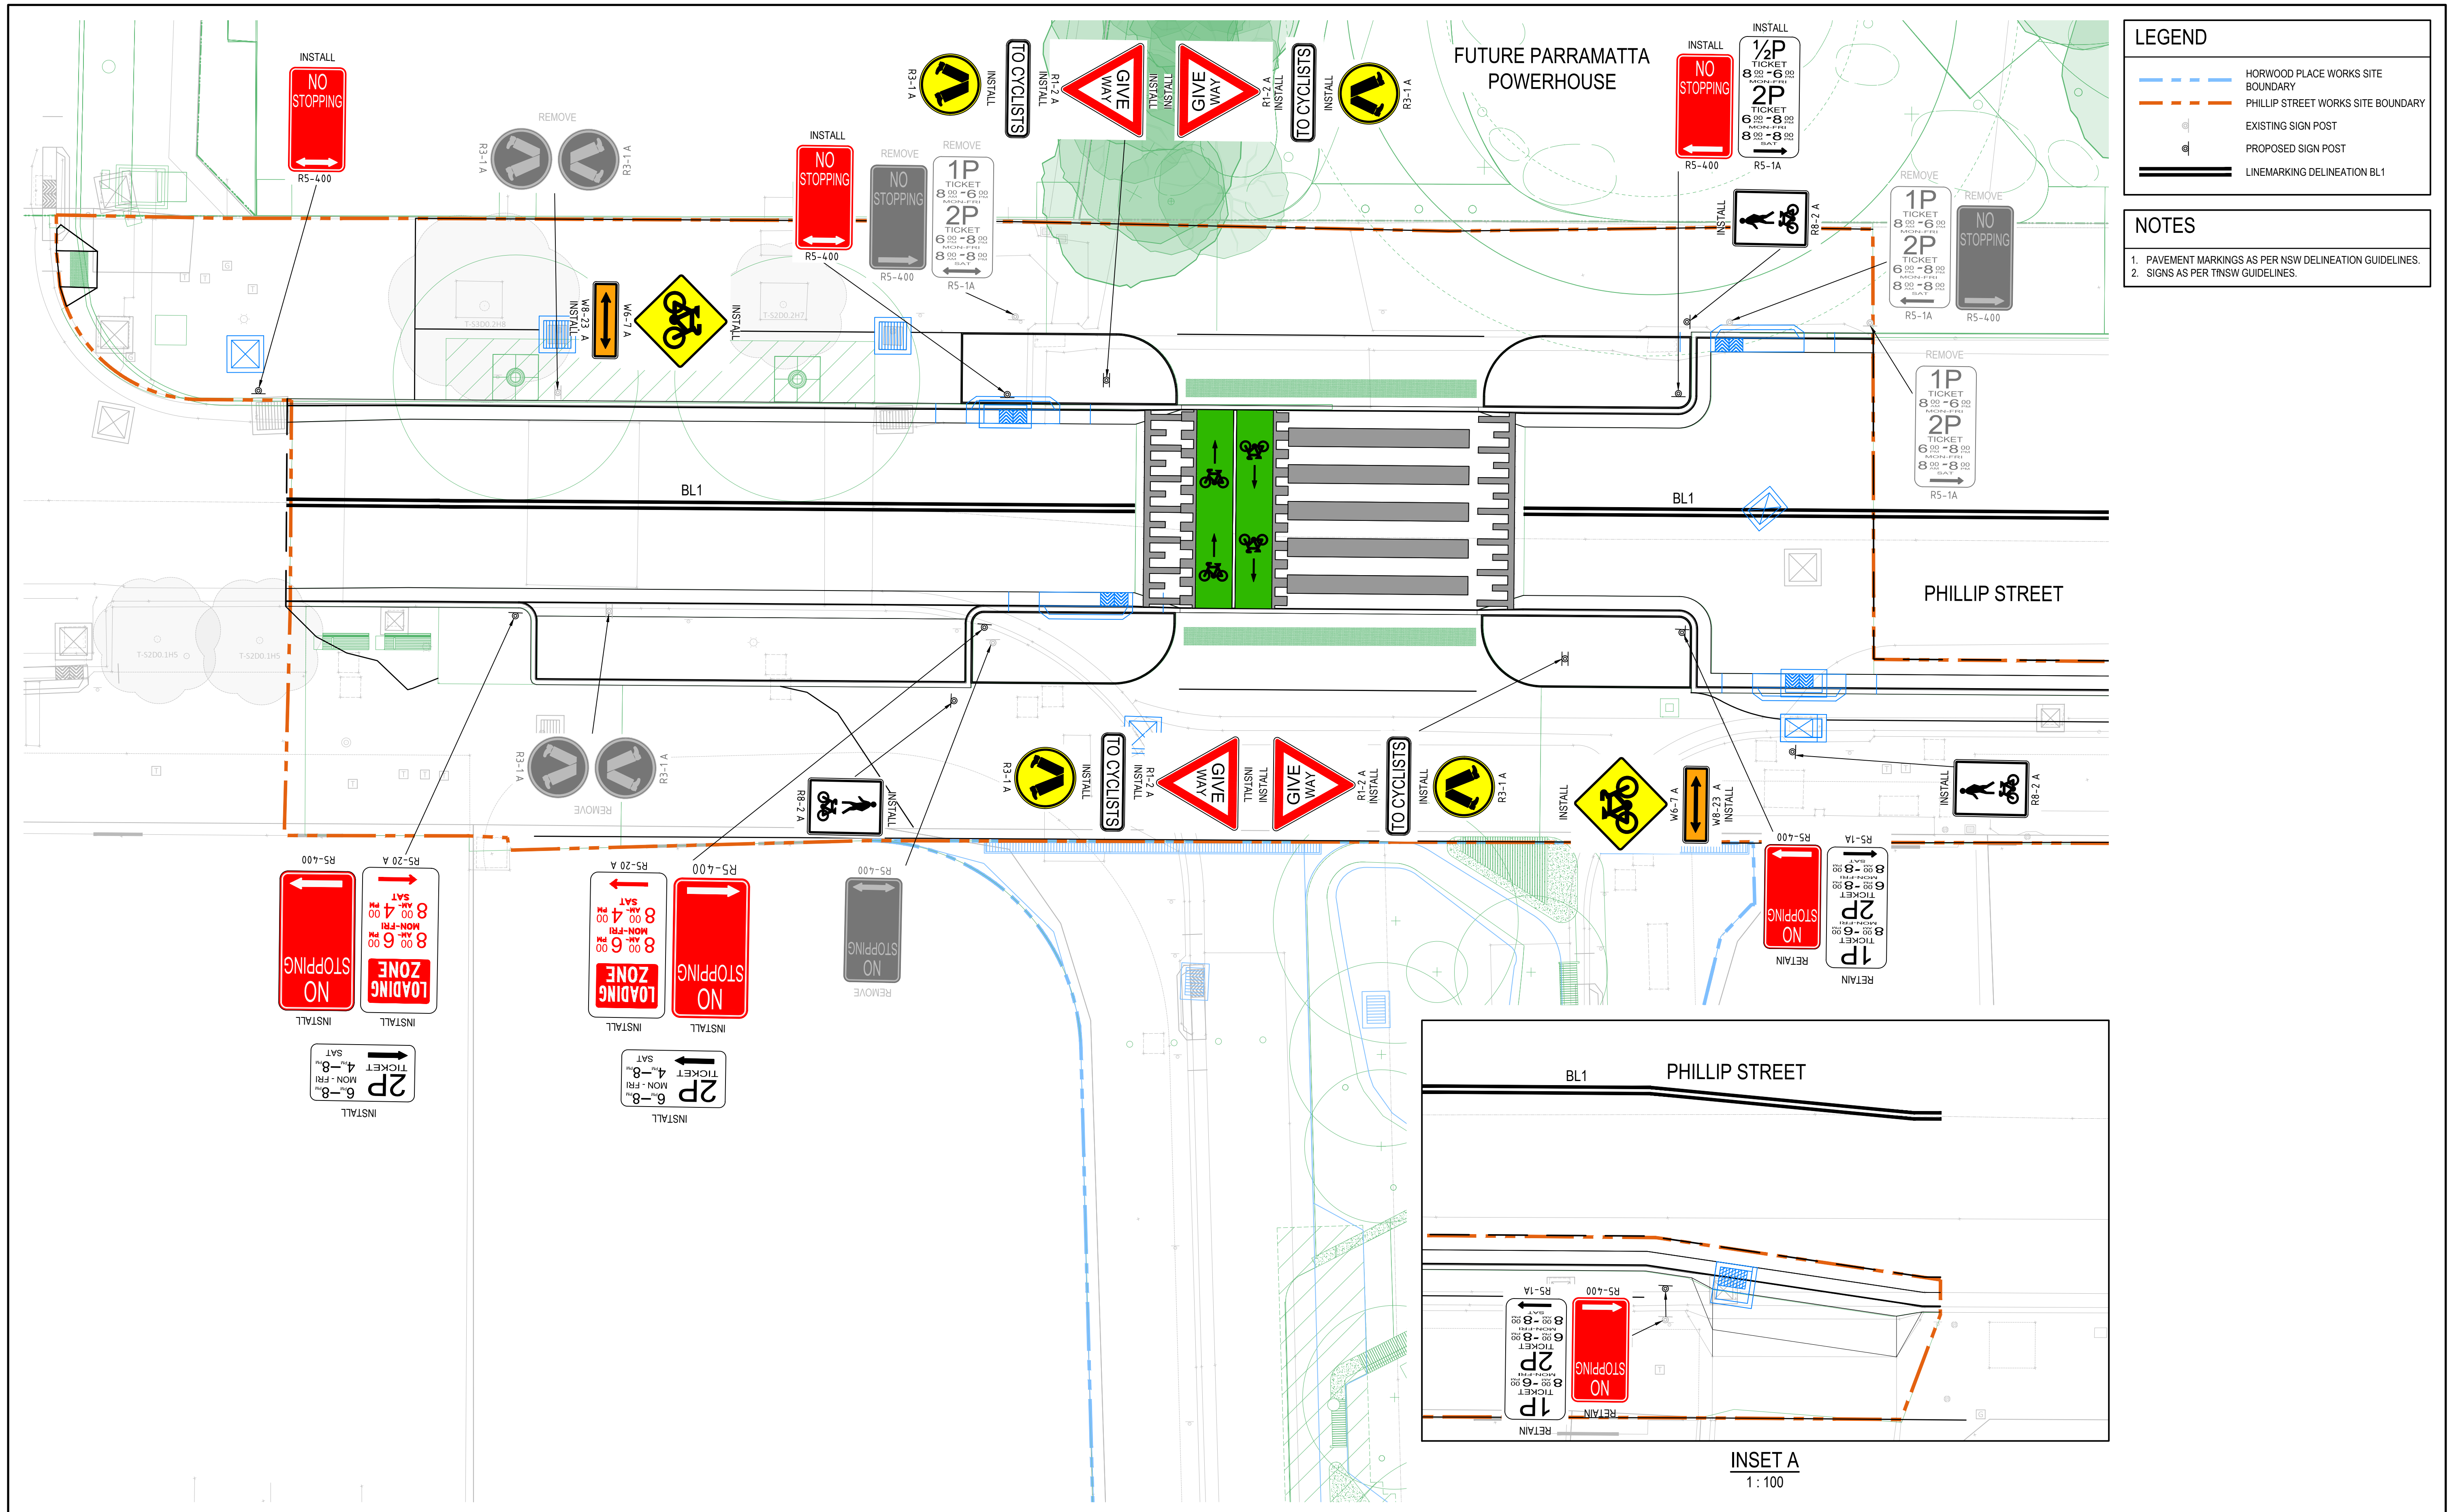

02	ISSUED FOR INFORMATION - 100% DETAILED DESIGN	RS	CR	GD	03.10.2025
01	ISSUED FOR INFORMATION - 95% DETAILED DESIGN	RS	CR	MK	03.10.2025
Issue	Description	DR	CH	VE	Date

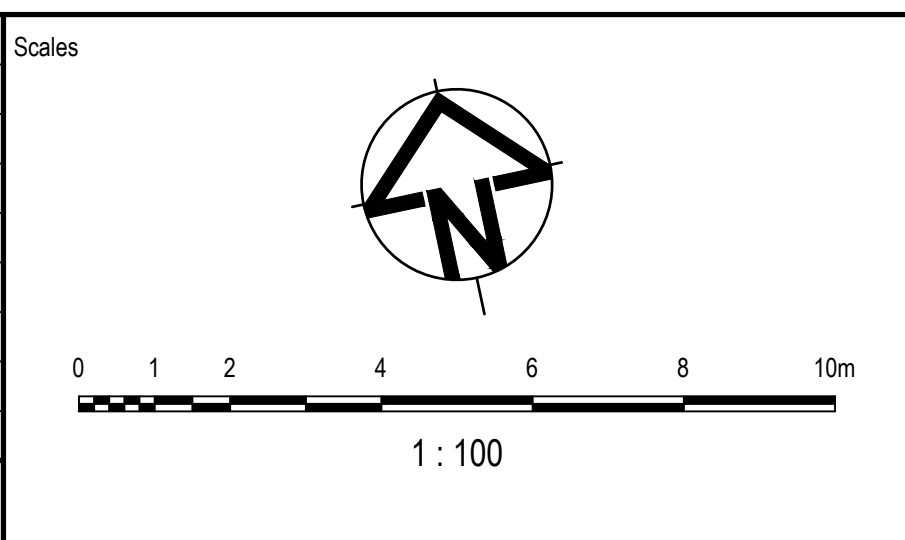

Surveyor

surveyplus **DURKIN**

Architect

OCULUS

Client

CITY OF PARRAMATTA

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Original Issue Signatures			
Drawn	R. SANTOS	Original Size	A1
Designed	L. CORSCADDEN	Height Datum	AHD
Project Manager	S. GEERDINK	Grid	MGA/20-56
Verified	G. DUNSTAN		

Project

**PARRAMATTA CIVIC LINK
PHILLIP STREET WORKS**

Title

**SIGNAGE AND
LINE MARKING PLAN**

ARCADIS

Arcadis Australia Pacific Pty Limited
Level 16, 580 George Street
SYDNEY NSW 2000
ABN 76 104 485 289
Tel No: +61 2 8907 9000
www.arcadis.com/au


Project Number **30286862**

Issue **02**


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NOTES


1. REFER TO DRAWING CL3-AAP-DD-HP-DRG-CI-0341 FOR PAVEMENT PLAN.

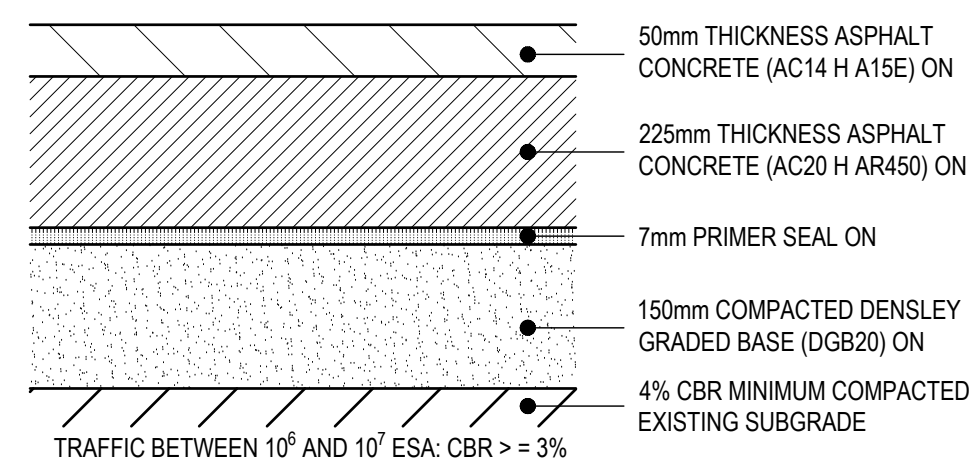


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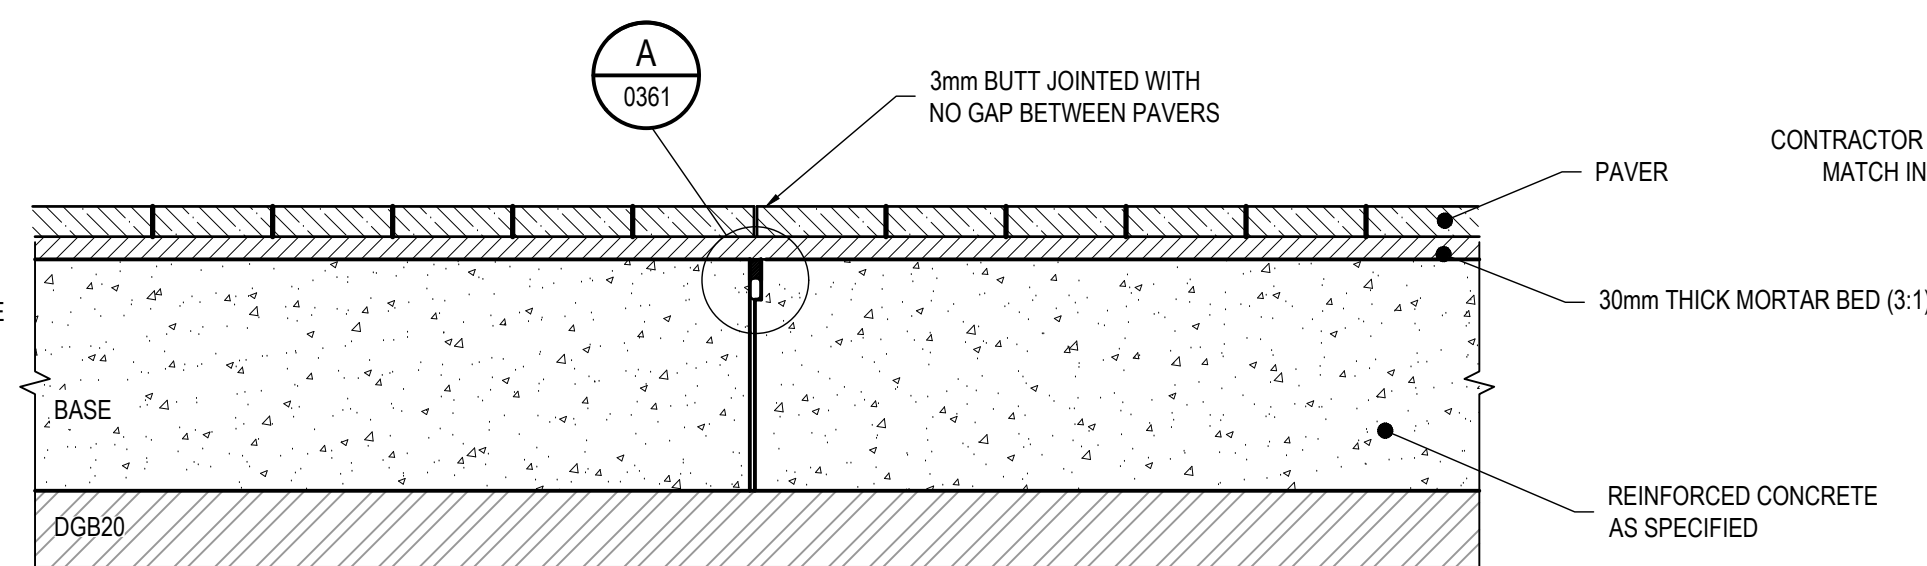
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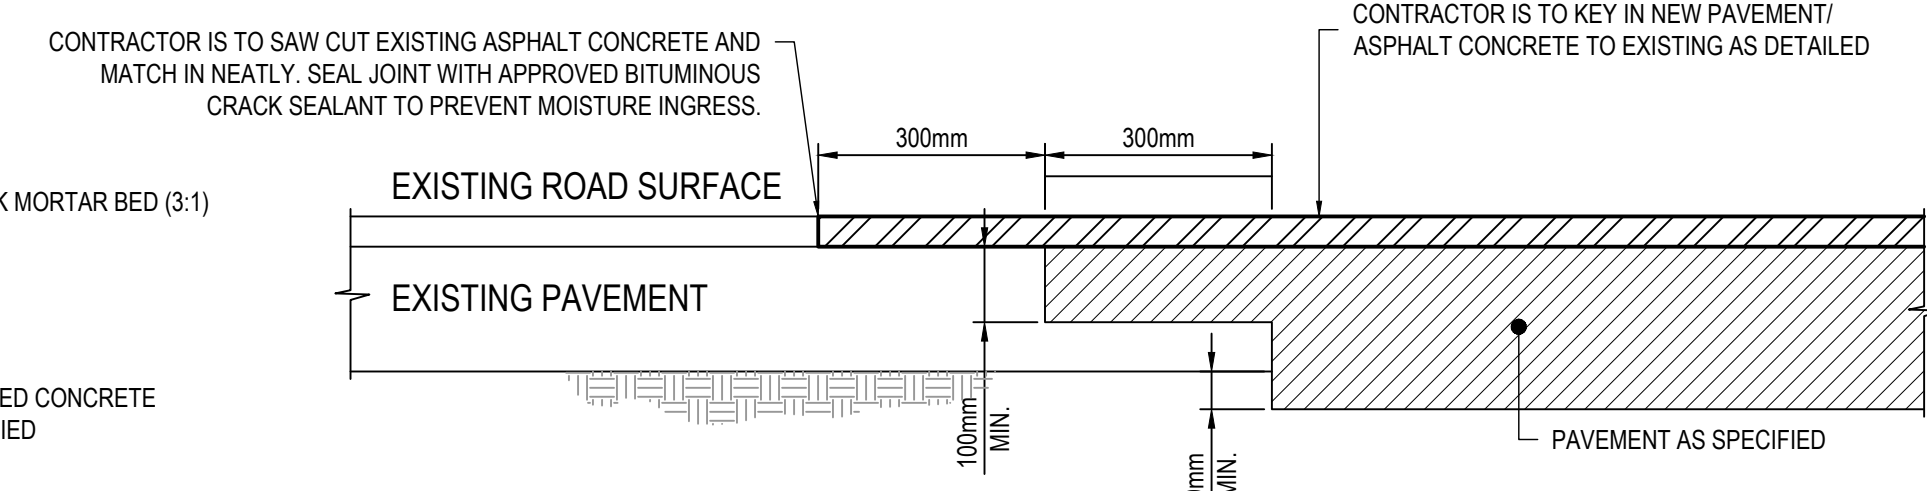
PV08 & PV09 & PV10
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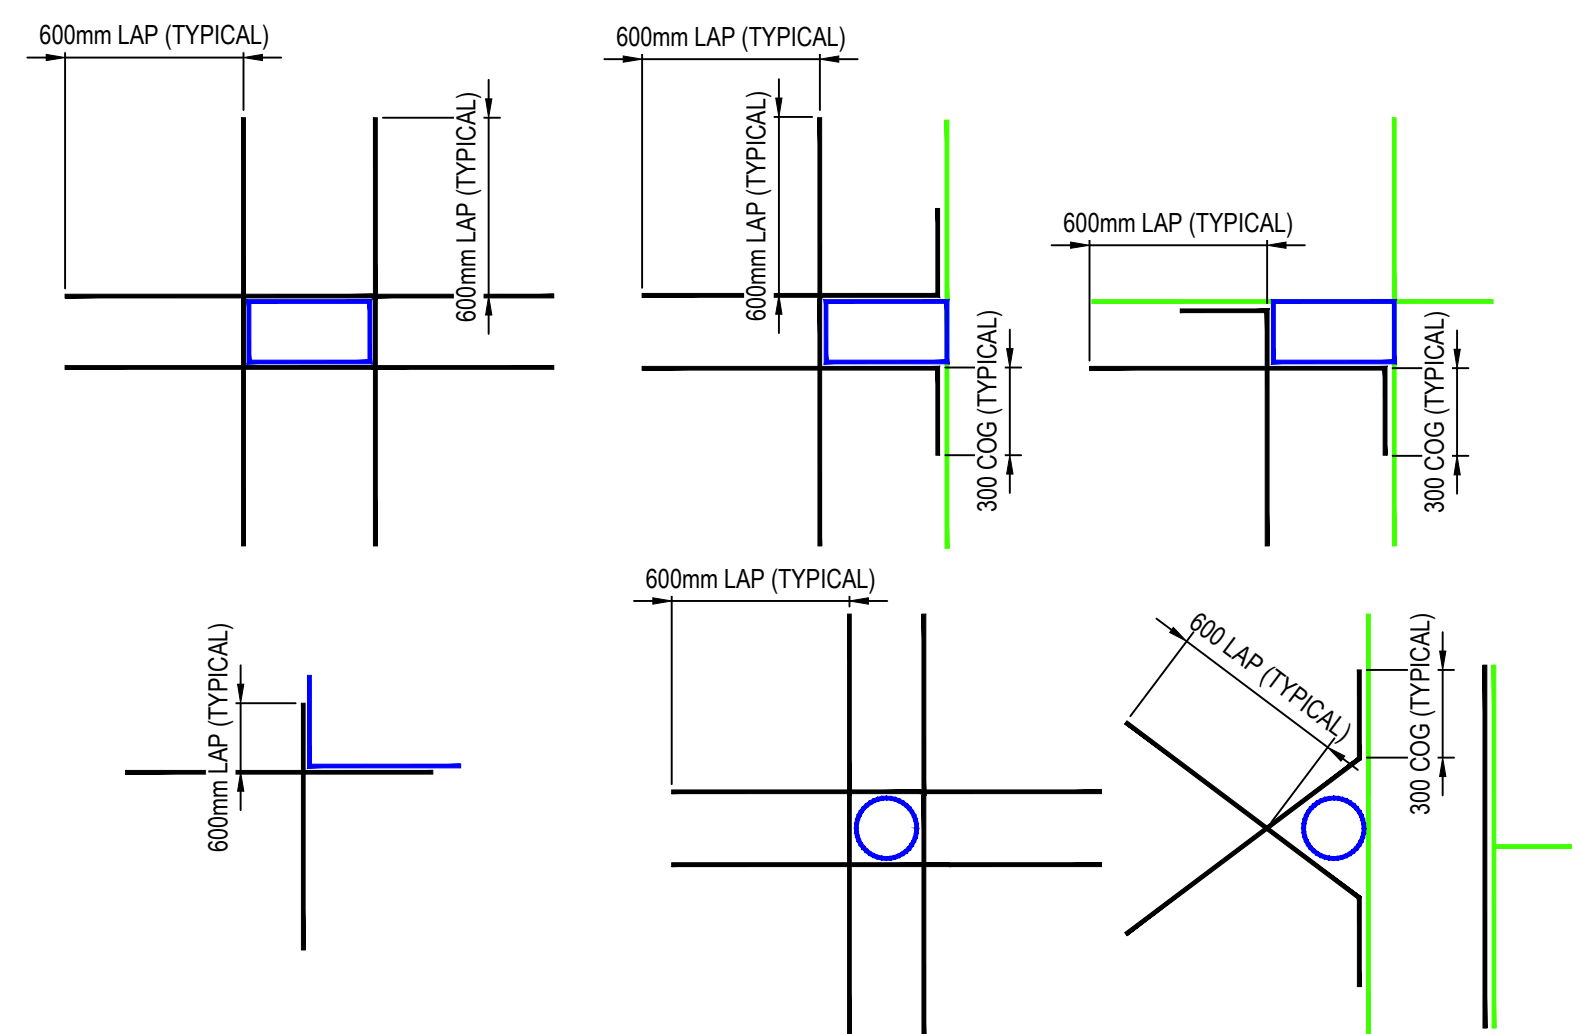
JOINT TYPE
FORMED ISOLATION JOINT (IJ)
SCALE 1:10

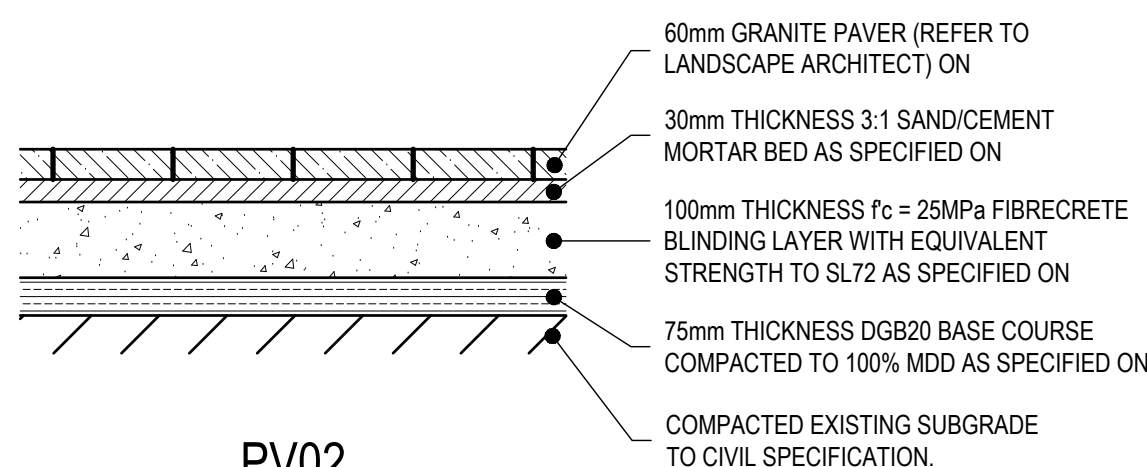

JOINT TYPE
SAWN JOINT (SJ)
SCALE 1:10

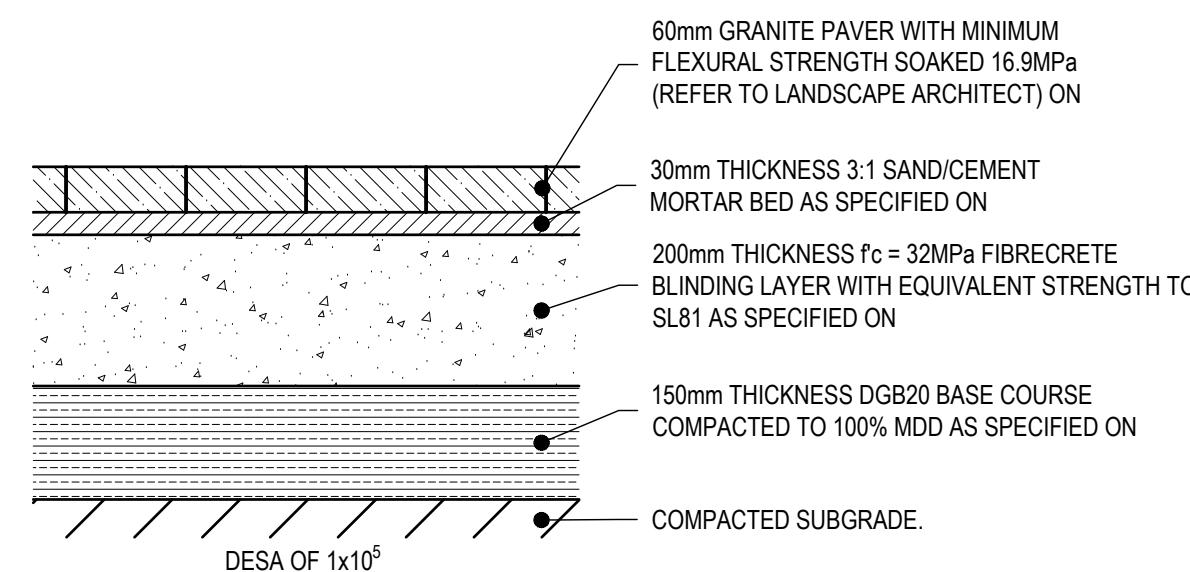


SAWCUT INTERFACE WITH EXISTING PAVEMENT
TYPICAL DETAIL SHOWING LONGITUDINAL
CONSTRUCTION DETAIL FOR CONNECTION
TO EXIST PAVEMENT/ASPHALT CONCRETE
SCALE 1:10

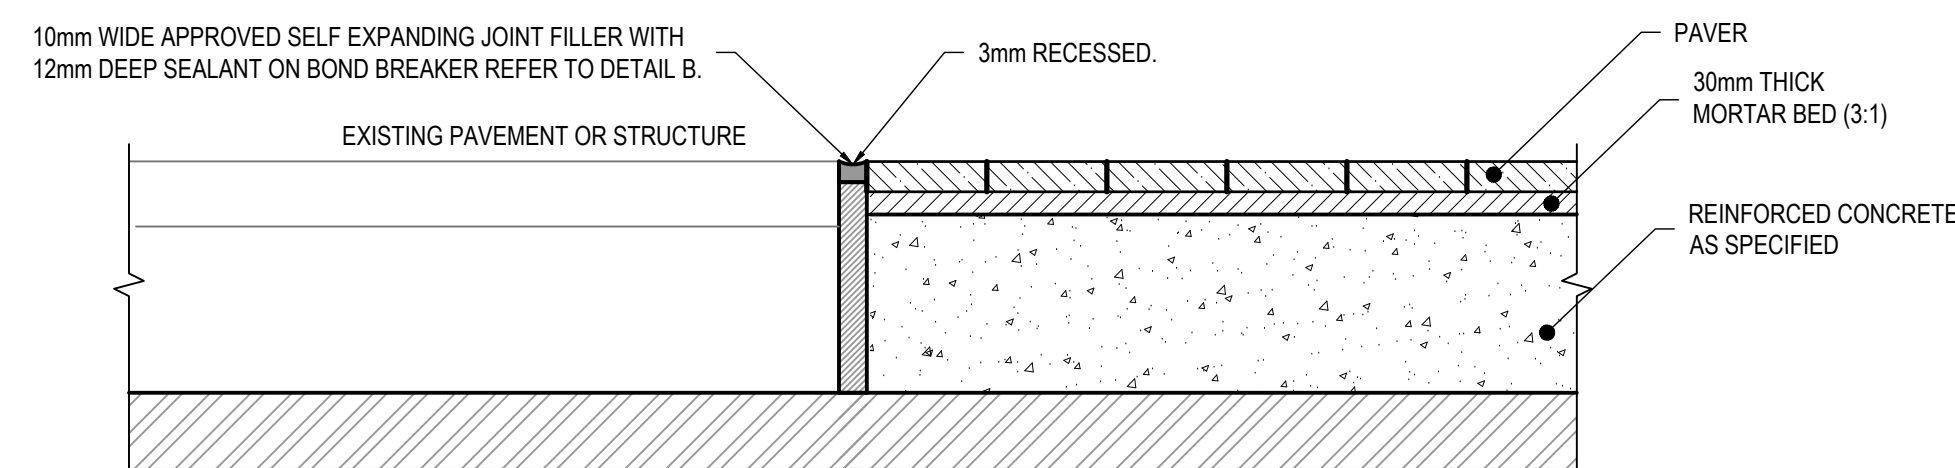


- NOTES
1. PROVIDE TRIMMER BARS AT SLAB PENETRATIONS (COLUMNS, WALLS, PITS ETC)
 2. ALL TRIMMER BARS TO BE 1N16 U.N.O
 3. PROVIDE 50 COVER EACH FACE U.N.O
 4. TRIMMER DETAILS ARE TO BE READ IN CONJUNCTION WITH GIVEN JOINTING DETAILS
 5. TRIMMER BARS TO MAINTAIN A MINIMUM OFFSET OF 50mm FROM ALL JOINTS

LEGEND	
	TRIMMER BAR
	SLAB PENETRATION WITH ISOLATION JOINT
	JOINT


TYPICAL SLAB ON GROUND TRIMMER
BAR DETAILS
SCALE N.T.S.

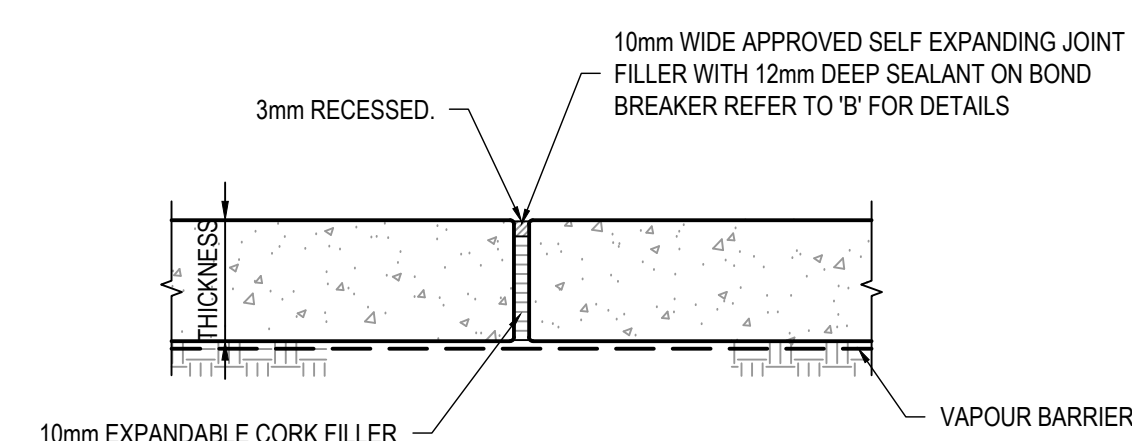


EXPANSION JOINT (EJ)
SCALE 1:10

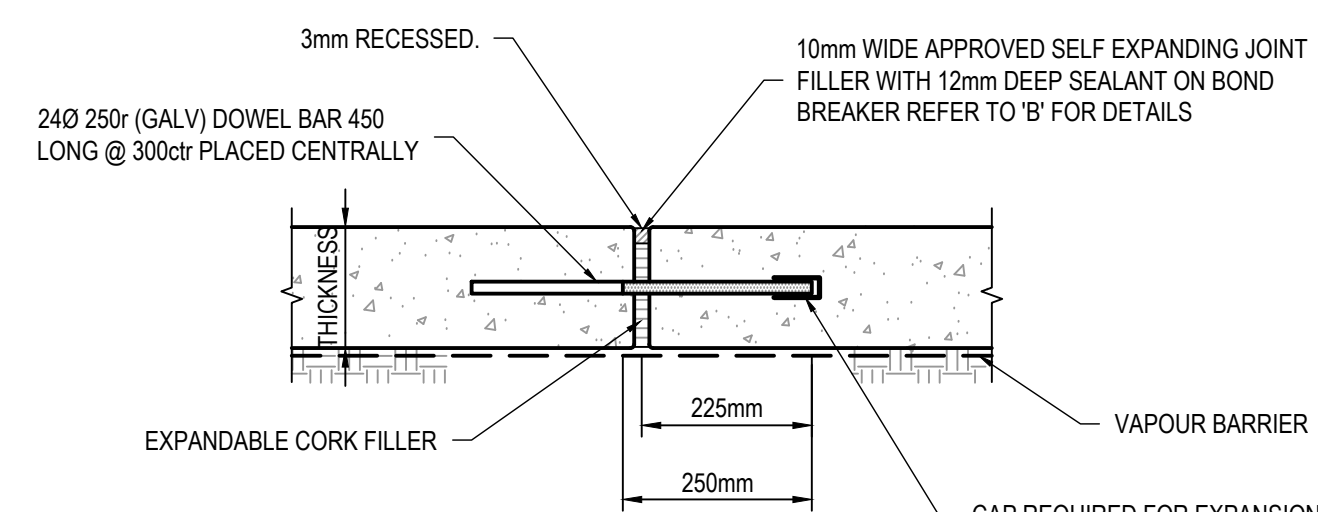


DOWELLED EXPANSION JOINT
(DEJ)
SCALE 1:10

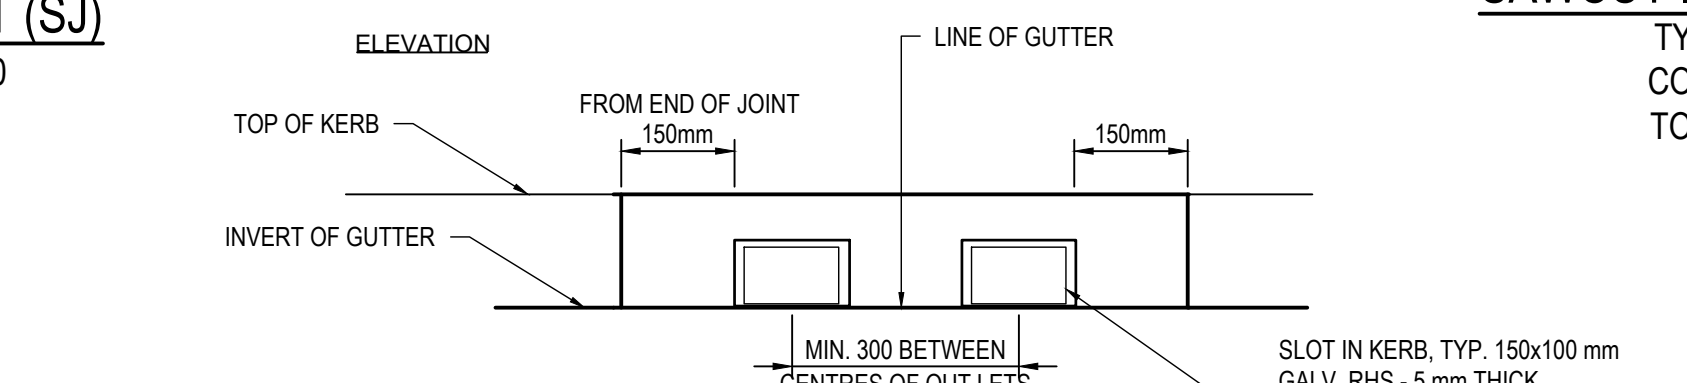


SLOTTED KERB ELEVATION
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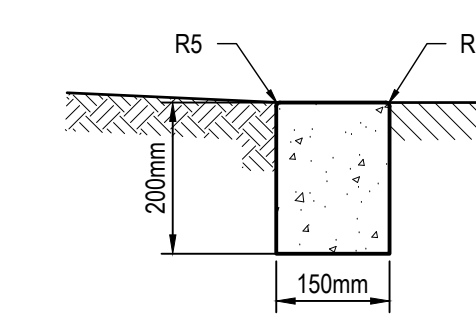
DETAIL
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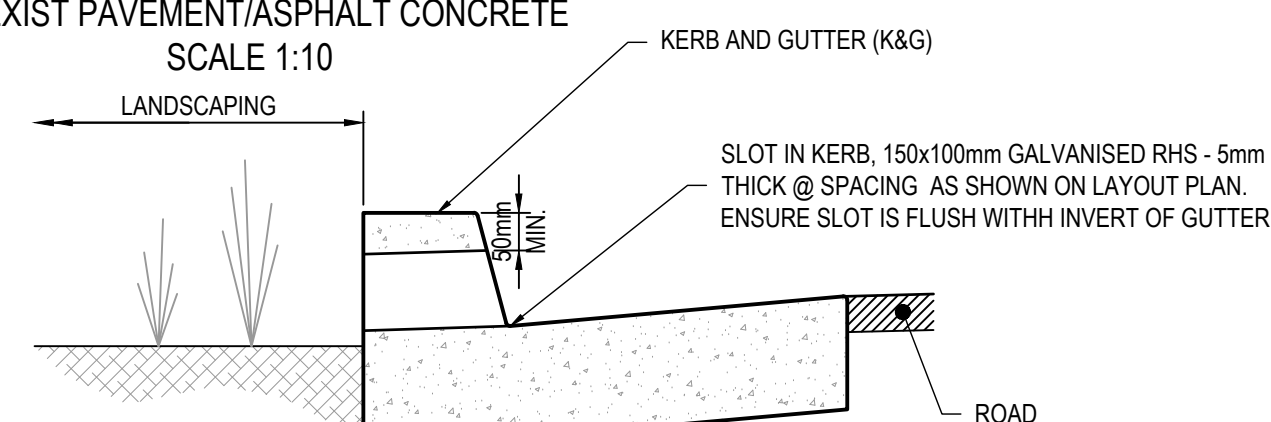
KERB ONLY
SCALE 1:10

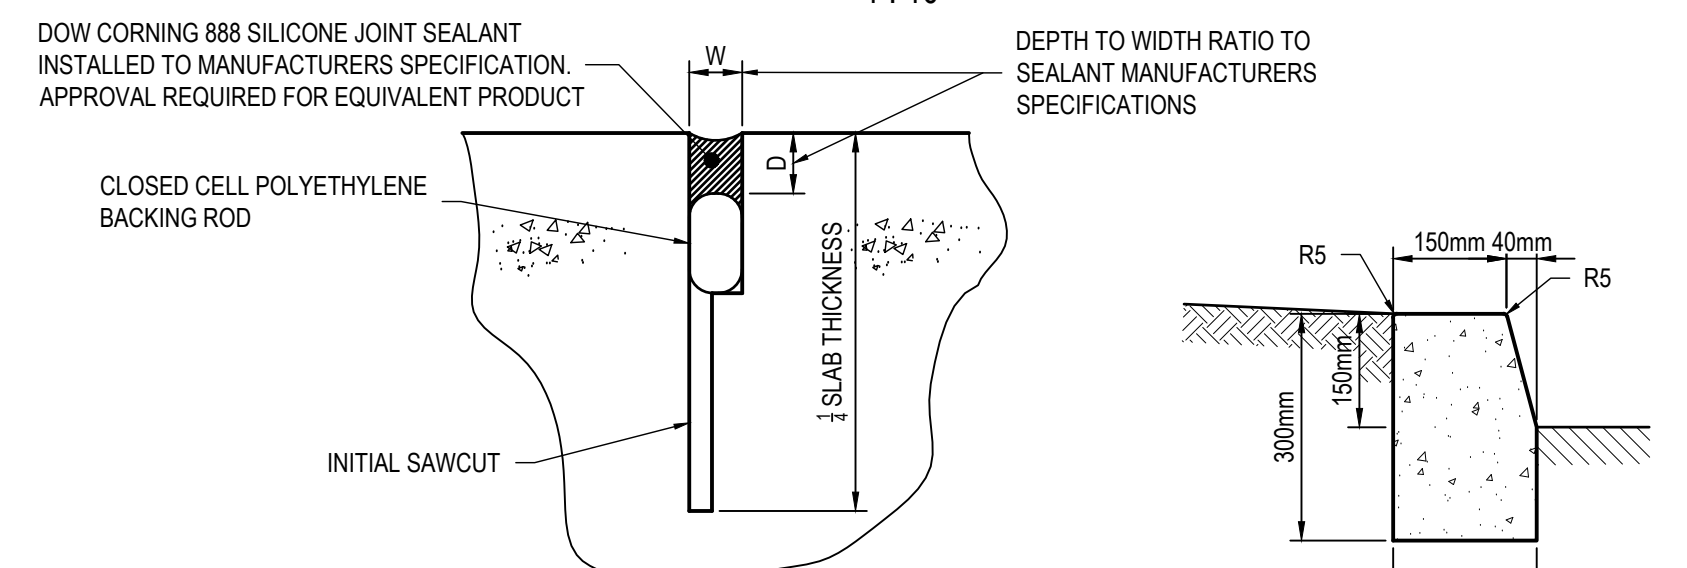


DETAIL
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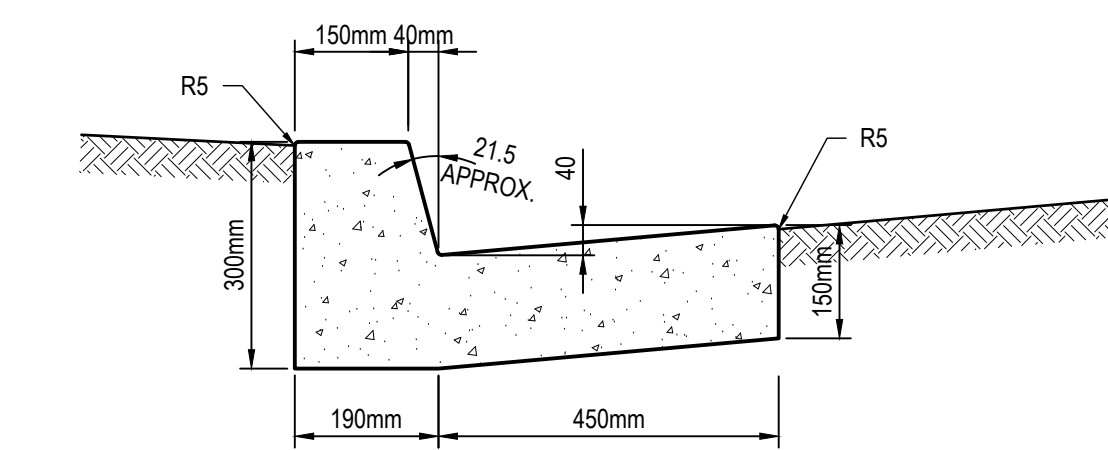
EDGE STRIP
SCALE 1:10

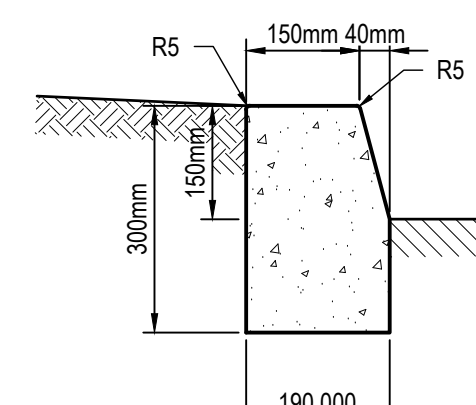

SLOTTED KERB SECTION
1:10

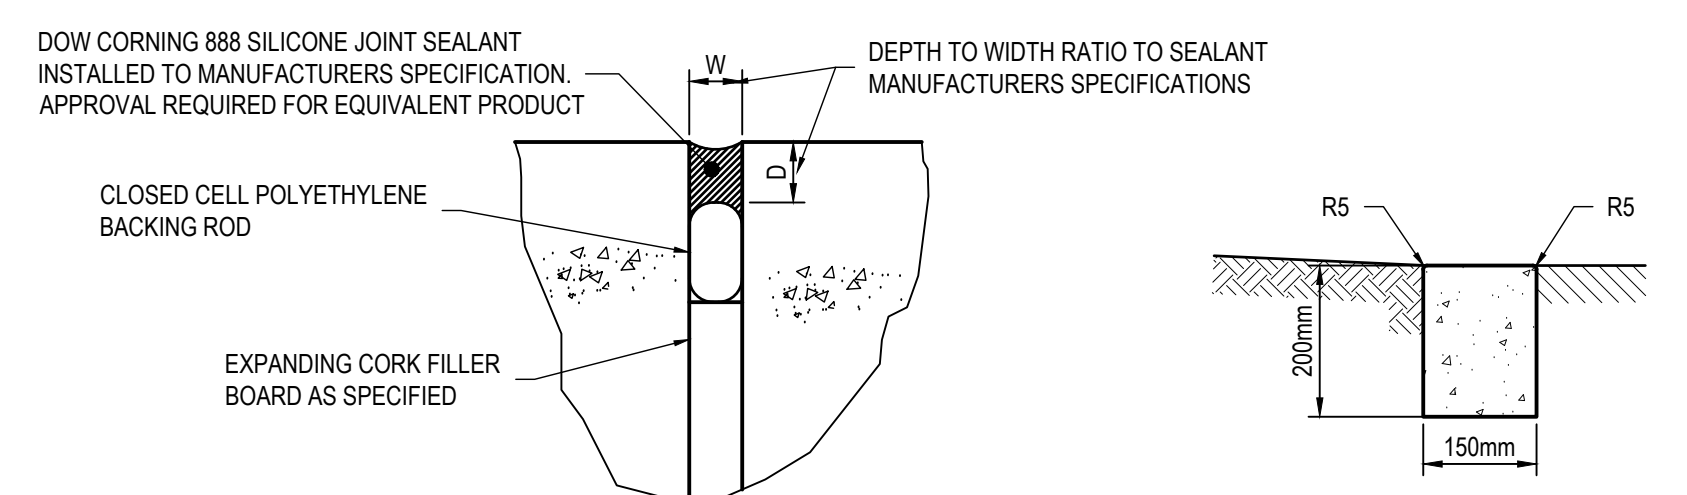


DISH DRAIN
SCALE 1:10

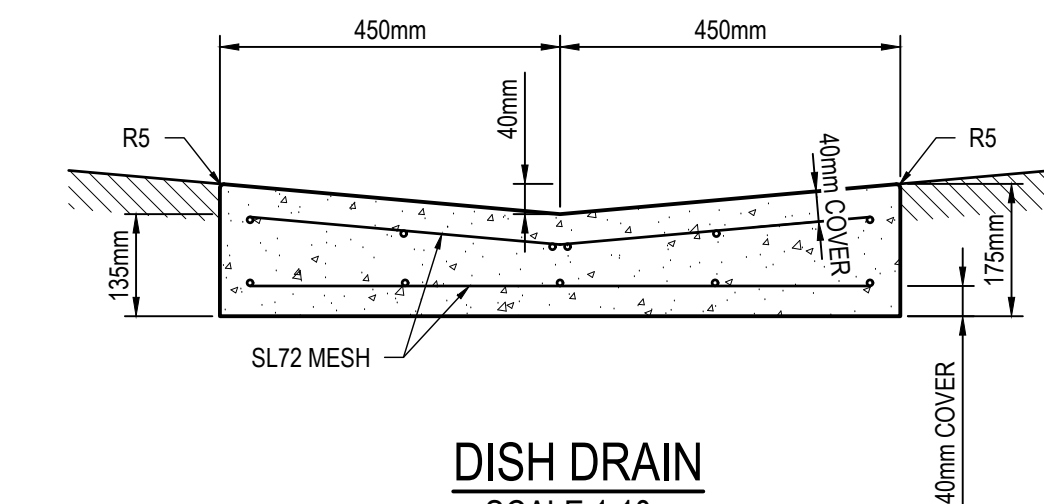

KERB & GUTTER
SCALE 1:10

Issue	Description	DR	CH	VE	Date
03	ISSUED FOR INFORMATION - 100% DETAILED DESIGN	RS	SG	GD	03.10.2025
02	ISSUED FOR INFORMATION - 95% DETAILED DESIGN	RS	SG	GD	10.09.2025
01	ISSUED FOR INFORMATION - 80% DETAILED DESIGN	RS	CR	MK	18.07.2025

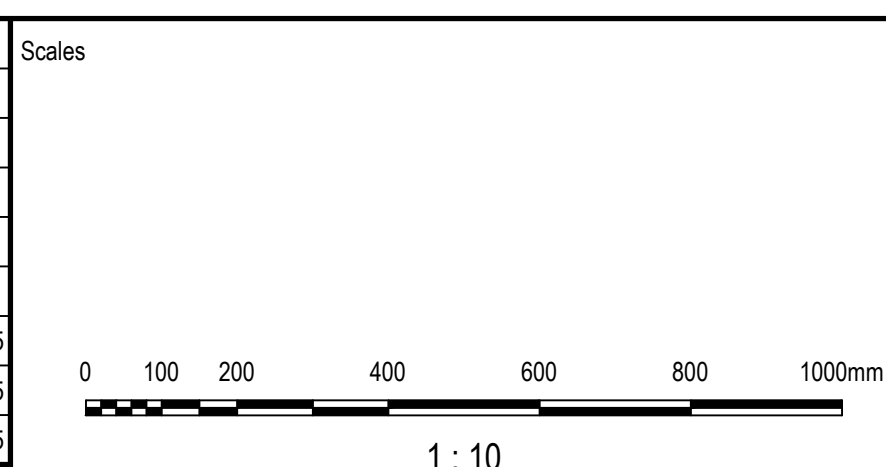


Surveyor	
Architect	

Client	
--------	--

Status	PRELIMINARY NOT TO BE USED FOR CONSTRUCTION
Original Issue Signatures	
Drawn	R. SANTOS
Designed	T. SUMMERSBY
Project Manager	S. GEERDINK
Verified	G. DUNSTAN
Original Size	A1
Height Datum	AHD
Grid	MGA/20-56


Project	PARRAMATTA CIVIC LINK PHILLIP STREET WORKS
Title	CIVIL WORKS DETAILS SHEET 1

	Arcadis Australia Pacific Pty Limited Level 16, 580 George Street SYDNEY NSW 2000 ABN 76 104 485 289 Tel No: +61 2 8907 9000 www.arcadis.com/au
Project Number	30286862
Issue	03
Drawing No.	CL3-AAP-DD-PS-DRG-CI-0361

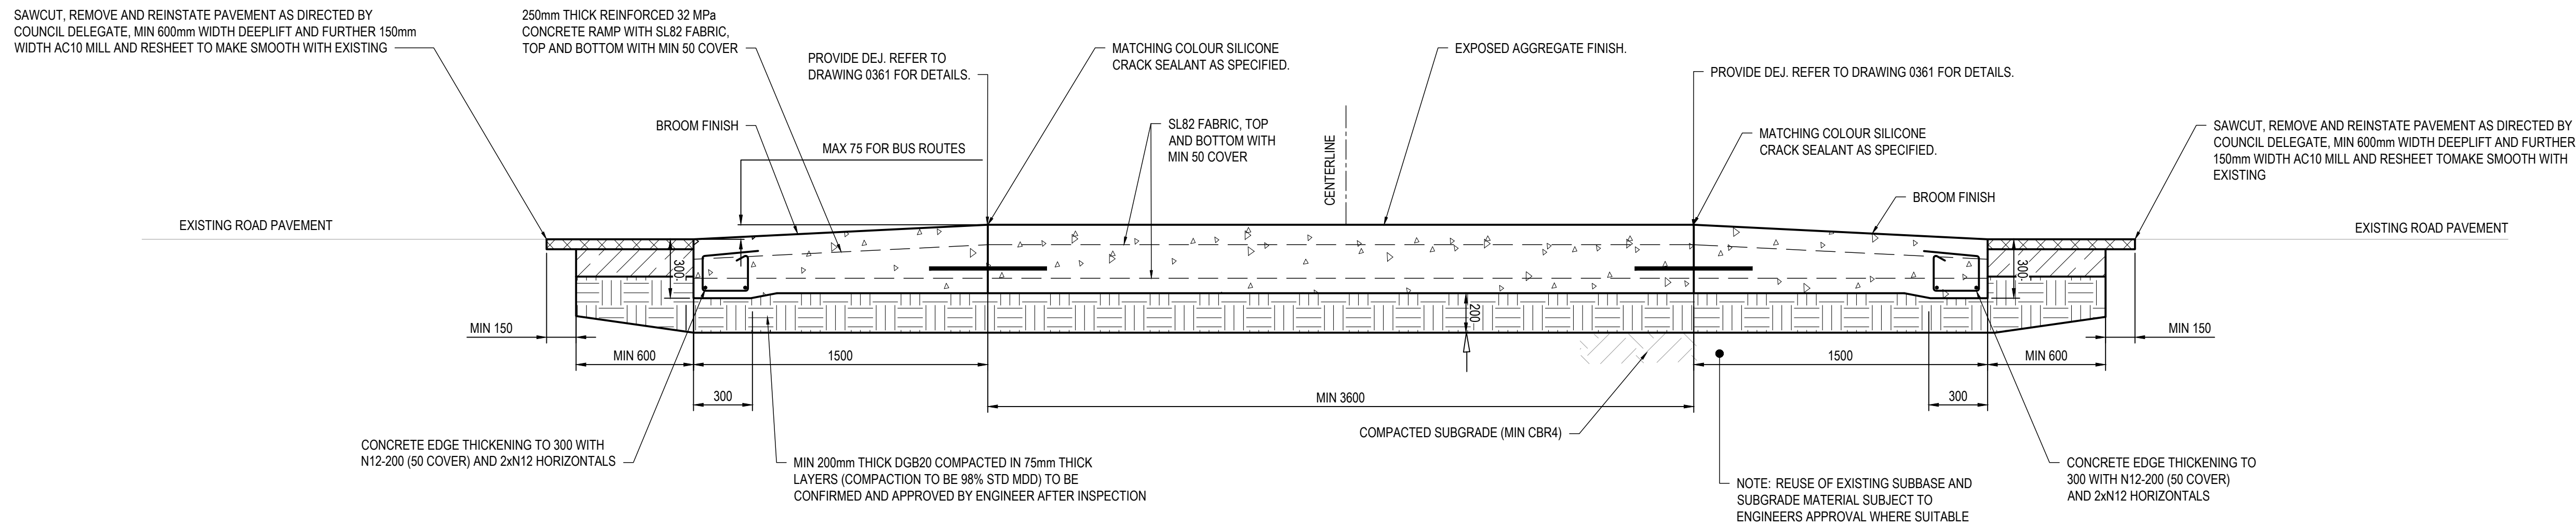


RAISED PEDESTRIAN CROSSING DETAIL (PV07)
NTS

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03	ISSUED FOR INFORMATION - 100% DETAILED DESIGN	RS	SG	GD	03.10.2025
02	ISSUED FOR INFORMATION - 95% DETAILED DESIGN	RS	SG	GD	10.09.2025
01	ISSUED FOR INFORMATION - 80% DETAILED DESIGN	RS	CR	MK	18.07.2025
Issue	Description	DR	CH	VE	Date

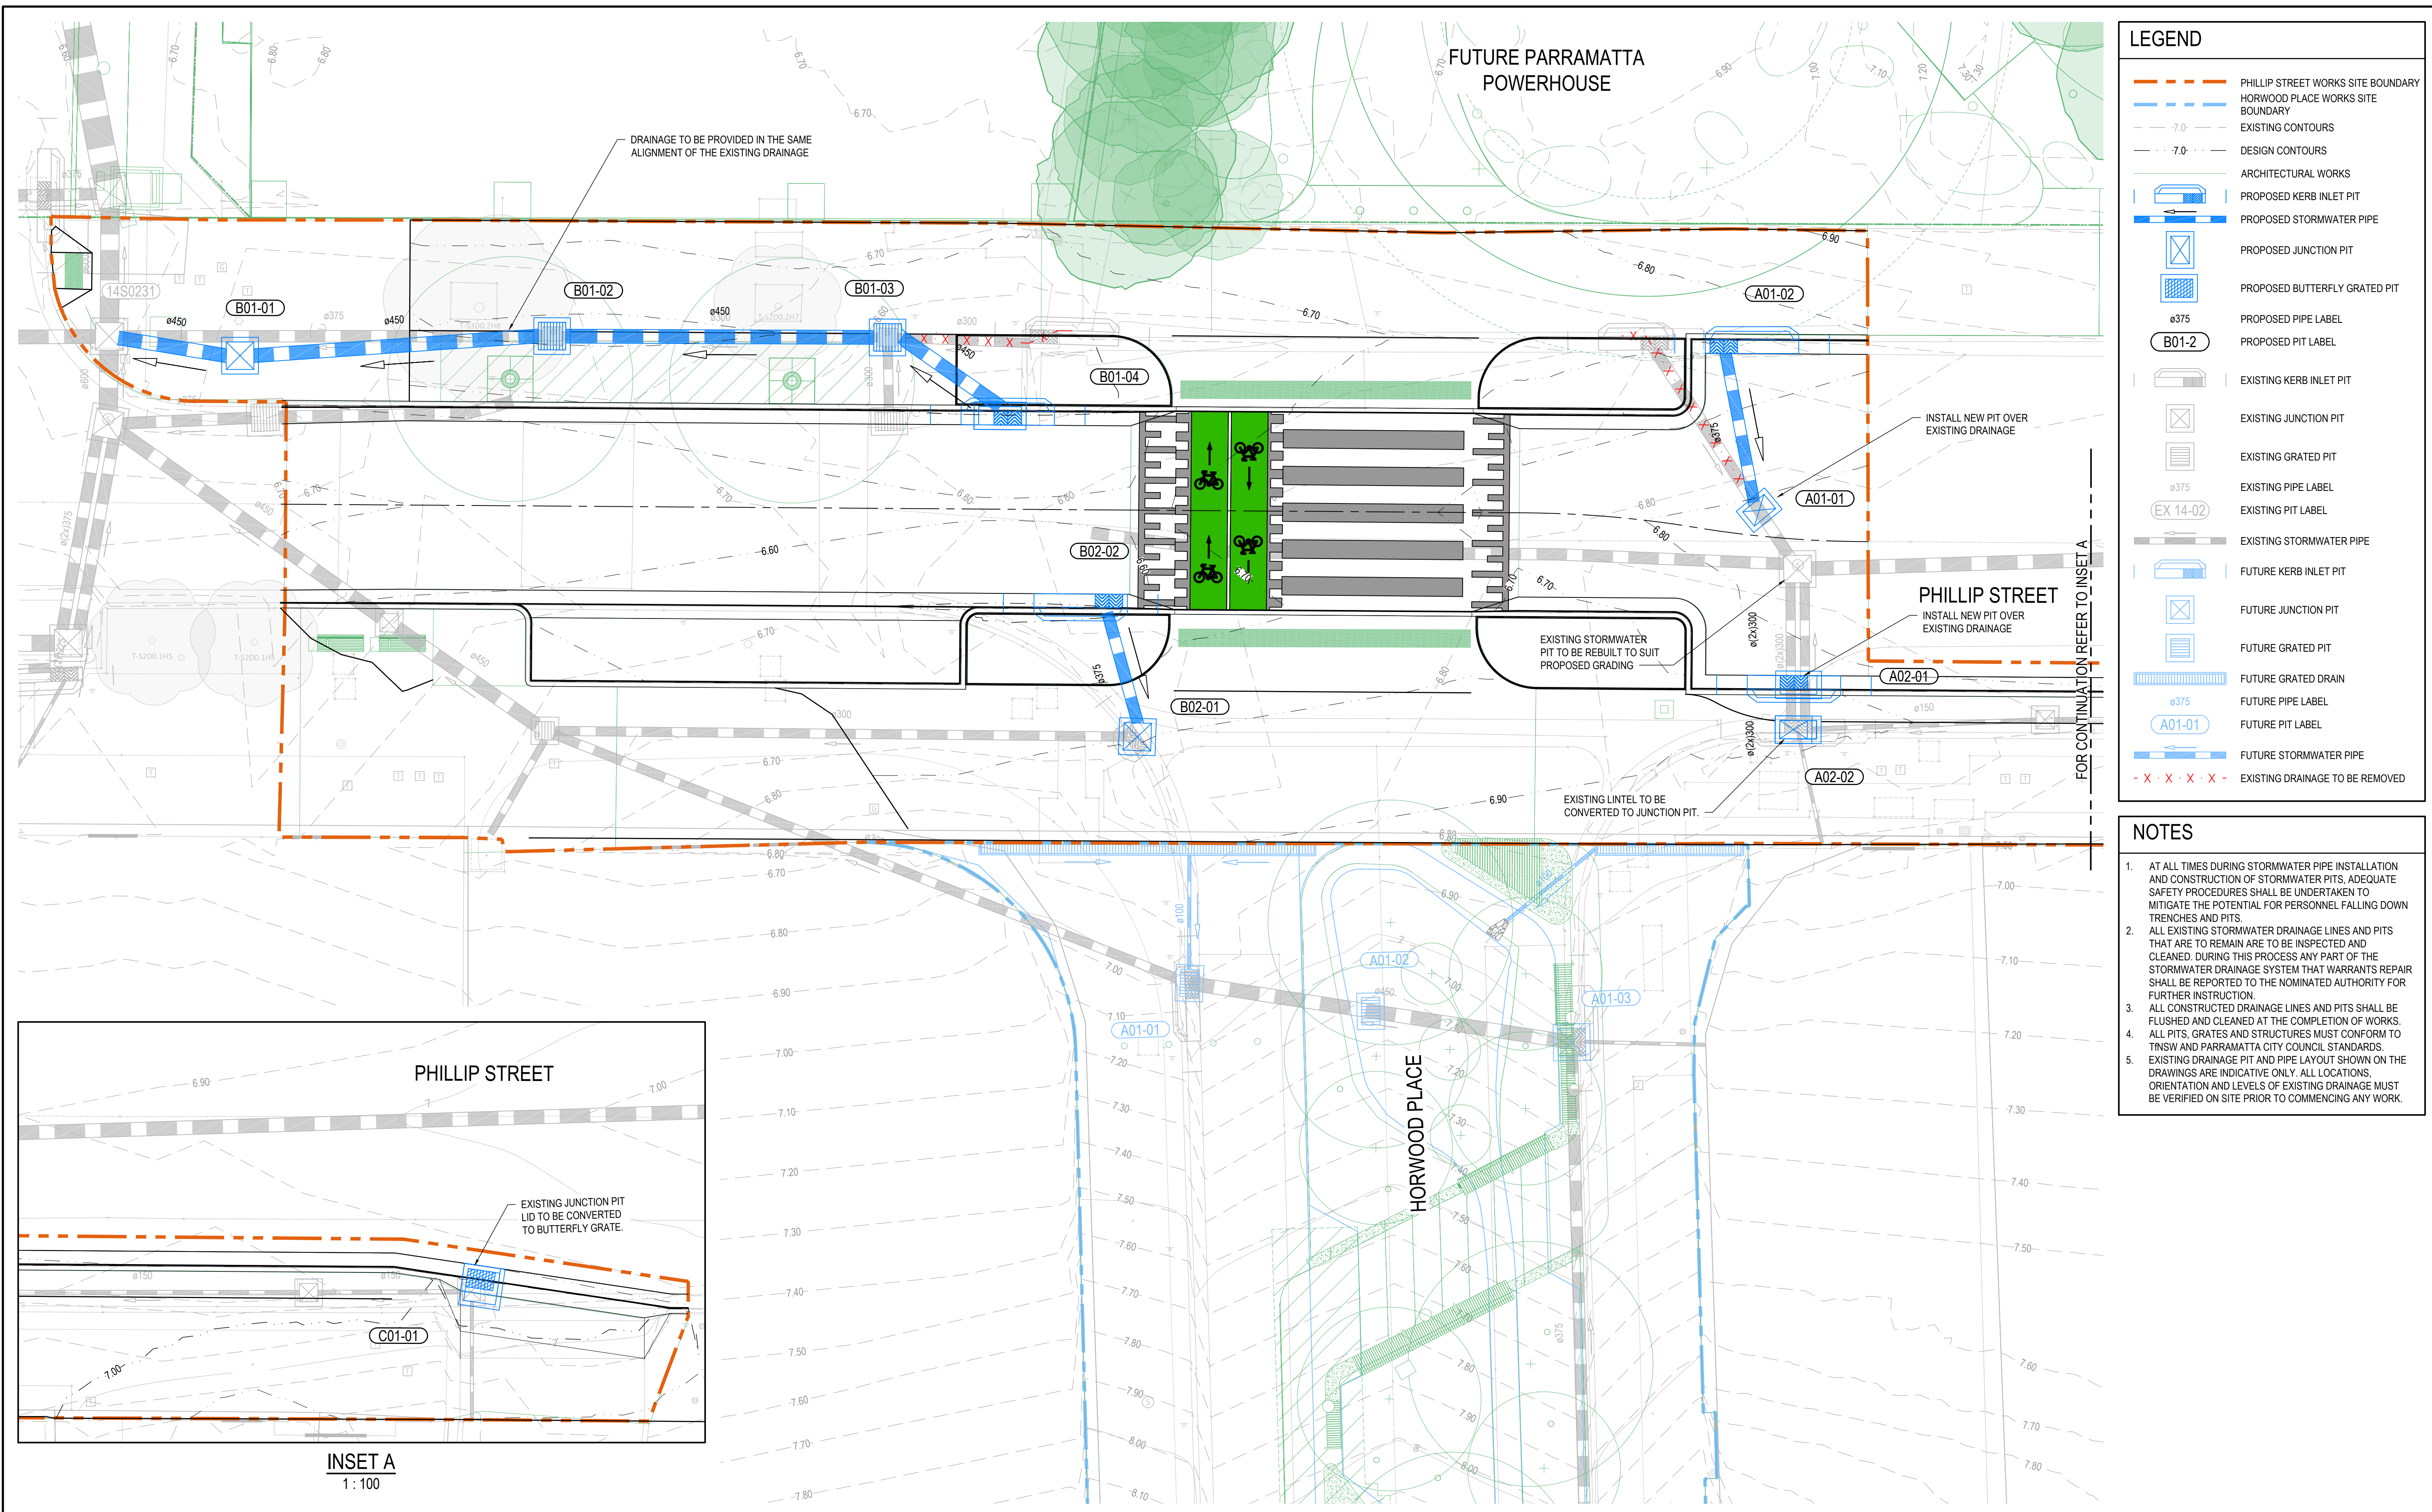

The image displays three logos. At the top left is the 'Surveyor' logo in a black sans-serif font. Below it is the 'surveyplus' logo, featuring a stylized city skyline icon above the word 'survey' in green and 'plus' in black. To the right of these is the 'DURKIN' logo, which consists of the word 'DURKIN' in a bold, italicized, white sans-serif font, set against a dark green rectangular background.

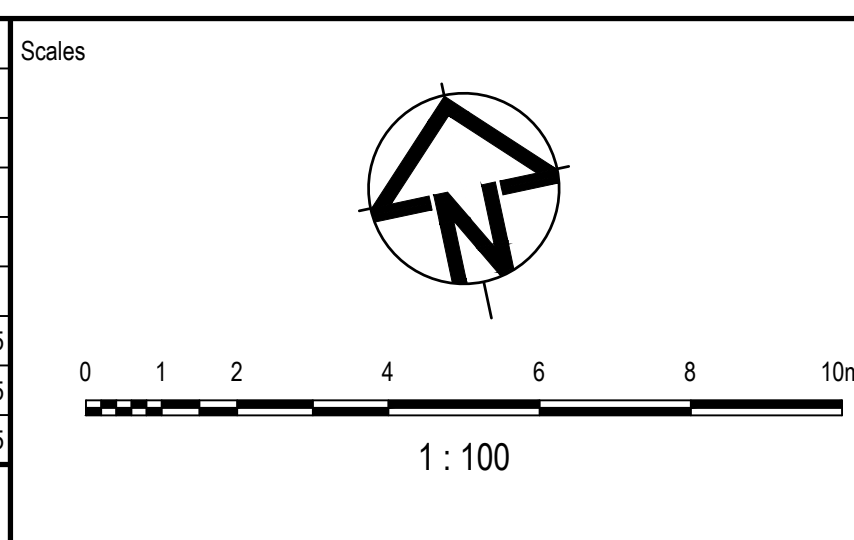Client




**CITY OF
PARRAMATTA**

Status	<h1 style="text-align: center;">PRELIMINARY</h1> <h2 style="text-align: center;">NOT TO BE USED FOR CONSTRUCTION</h2>		
© Copyright reserved			
Original Issue Signatures			
Drawn	R. SANTOS	Original Size	A1
Designed	J. PEÑA	Height Datum	AHD
Project Manager	S. GEERDINK	Grid	MGA/20-56
Verified	G. DUNSTAN		

Project	PARRAMATTA CIVIC LINK PHILLIP STREET WORKS
Title	STORMWATER PLAN

The image shows the ARCADIS logo, which consists of a stylized orange 'A' icon followed by the word 'ARCADIS' in a bold, black, sans-serif font. Below the logo, the text 'Arcadis Australia Pacific Pty Limited' is written in a smaller font. Further down, the address 'Level 16, 580 George Street' and 'SYDNEY NSW 2000' are listed, followed by the phone number 'ABN 76 104 485 289'. At the bottom, the email 'Tel No: +61 2 8907 9000' and the website 'www.arcadis.com/au' are provided. To the right of the contact information, there is a table with two columns: 'Project Number' and 'Issue'. The first row of the table shows '30286862' under 'Project Number' and '03' under 'Issue'.

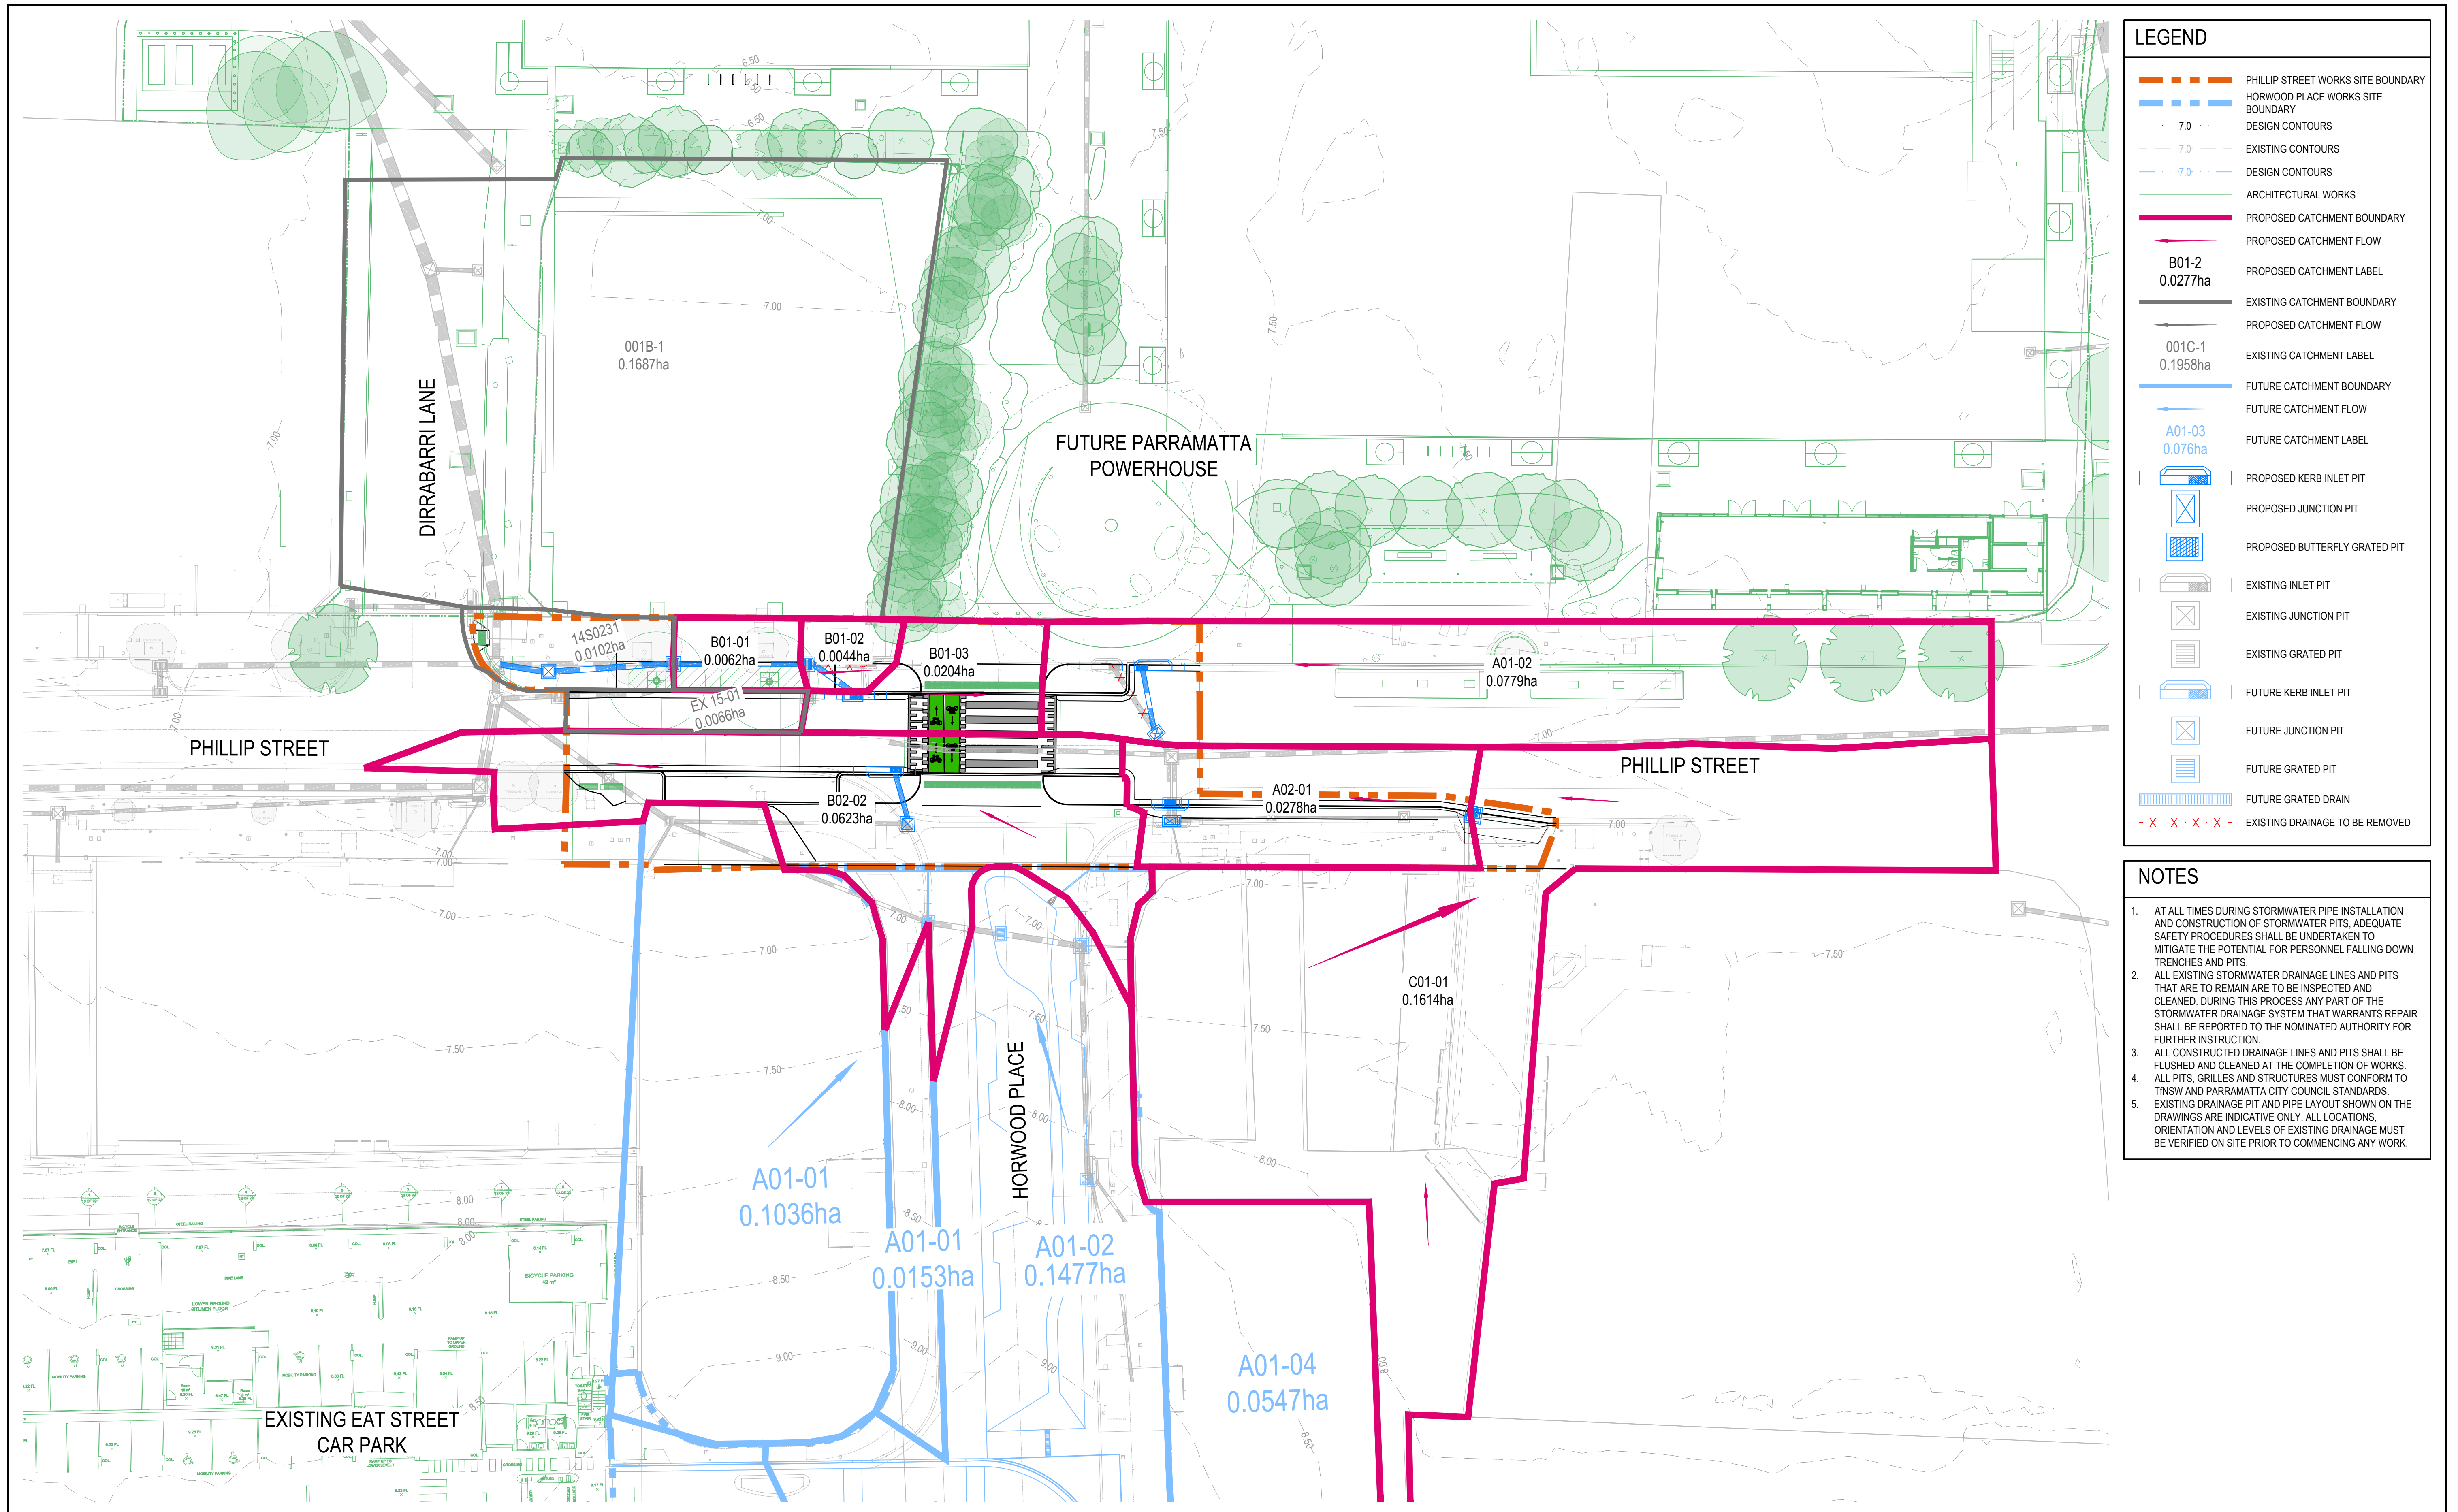

LEGEND

PHILLIP STREET WORKS SITE BOUNDARY

HORWOOD PLACE WORKS SITE BOUNDARY

DESIGN CONTOURS

EXISTING CONTOURS

DESIGN CONTOURS

ARCHITECTURAL WORKS

PROPOSED CATCHMENT BOUNDARY

PROPOSED CATCHMENT FLOW

B01-2
0.0277ha

PROPOSED CATCHMENT LABEL

EXISTING CATCHMENT BOUNDARY

PROPOSED CATCHMENT FLOW

001C-1
0.1958ha

EXISTING CATCHMENT LABEL

FUTURE CATCHMENT BOUNDARY

FUTURE CATCHMENT FLOW

A01-03
0.076ha

FUTURE CATCHMENT LABEL

PROPOSED KERB INLET PIT

PROPOSED JUNCTION PIT

PROPOSED BUTTERFLY GRATED PIT

EXISTING INLET PIT

EXISTING JUNCTION PIT

EXISTING GRATED PIT

FUTURE KERB INLET PIT

FUTURE JUNCTION PIT

FUTURE GRATED PIT

FUTURE GRATED DRAIN

- X X X X X -

EXISTING DRAINAGE TO BE REMOVED

- NOTES
1.

AT ALL TIMES DURING STORMWATER PIPE INSTALLATION AND CONSTRUCTION OF STORMWATER PITS, ADEQUATE SAFETY PROCEDURES SHALL BE UNDERTAKEN TO MITIGATE THE POTENTIAL FOR PERSONNEL FALLING DOWN TRENCHES AND PITS.
2.


ALL EXISTING STORMWATER DRAINAGE LINES AND PITS THAT ARE TO REMAIN ARE TO BE INSPECTED AND CLEANED. DURING THIS PROCESS ANY PART OF THE STORMWATER DRAINAGE SYSTEM THAT WARRANTS REPAIR SHALL BE REPORTED TO THE NOMINATED AUTHORITY FOR FURTHER INSTRUCTION.
3.

ALL CONSTRUCTED DRAINAGE LINES AND PITS SHALL BE FLUSHED AND CLEANED AT THE COMPLETION OF WORKS.
4.

ALL PITS, GRILLES AND STRUCTURES MUST CONFORM TO TNSW AND PARRAMATTA CITY COUNCIL STANDARDS.
5.

EXISTING DRAINAGE PIT AND PIPE LAYOUT SHOWN ON THE DRAWINGS ARE INDICATIVE ONLY. ALL LOCATIONS, ORIENTATION AND LEVELS OF EXISTING DRAINAGE MUST BE VERIFIED ON SITE PRIOR TO COMMENCING ANY WORK.

03	ISSUED FOR INFORMATION - 100% DETAILED DESIGN	RS	SG	GD	03.10.2025
02	ISSUED FOR INFORMATION - 95% DETAILED DESIGN	RS	SG	GD	10.09.2025
01	ISSUED FOR INFORMATION - 80% DETAILED DESIGN	RS	CR	MK	18.07.2025
Issue	Description	DR	CH	VE	Date

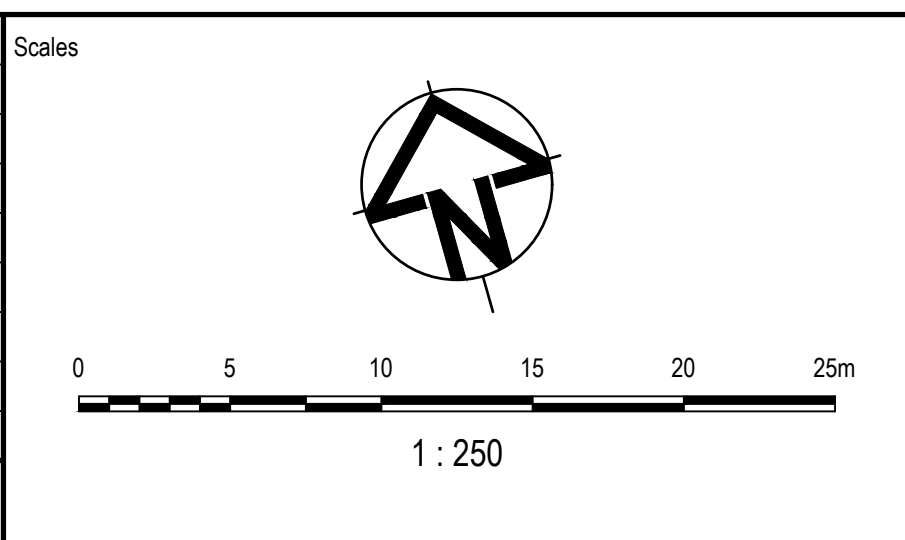

Surveyor

surveyplus

DURKIN

Architect

OCULUS

Client

CITY OF PARRAMATTA

Status	PRELIMINARY NOT TO BE USED FOR CONSTRUCTION		
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Original Issue Signatures			
Drawn	R. SANTOS	Original Size	A1
Designed	J. PEÑA	Height Datum	AHD
Project Manager	S. GEERDINK	Grid	MGA/20-56
Verified	G. DUNSTAN		

Project

PARRAMATTA
CIVIC LINK
PHILLIP STREET WORKS

CATCHMENT PLAN

ARCADIS

Arcadis Australia Pacific Pty Limited
Level 16, 580 George Street
SYDNEY NSW 2000
ABN 76 104 485 289
Tel No: +61 2 8907 9000
www.arcadis.com/au


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30286862


Issue

03



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
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02	ISSUED FOR INFORMATION - 95% DETAILED DESIGN	RS	SG	GD	10.09.2025
01	ISSUED FOR INFORMATION - 80% DETAILED DESIGN	RS	CR	MK	18.07.2025
Issue	Description	DR	CH	VE	Date

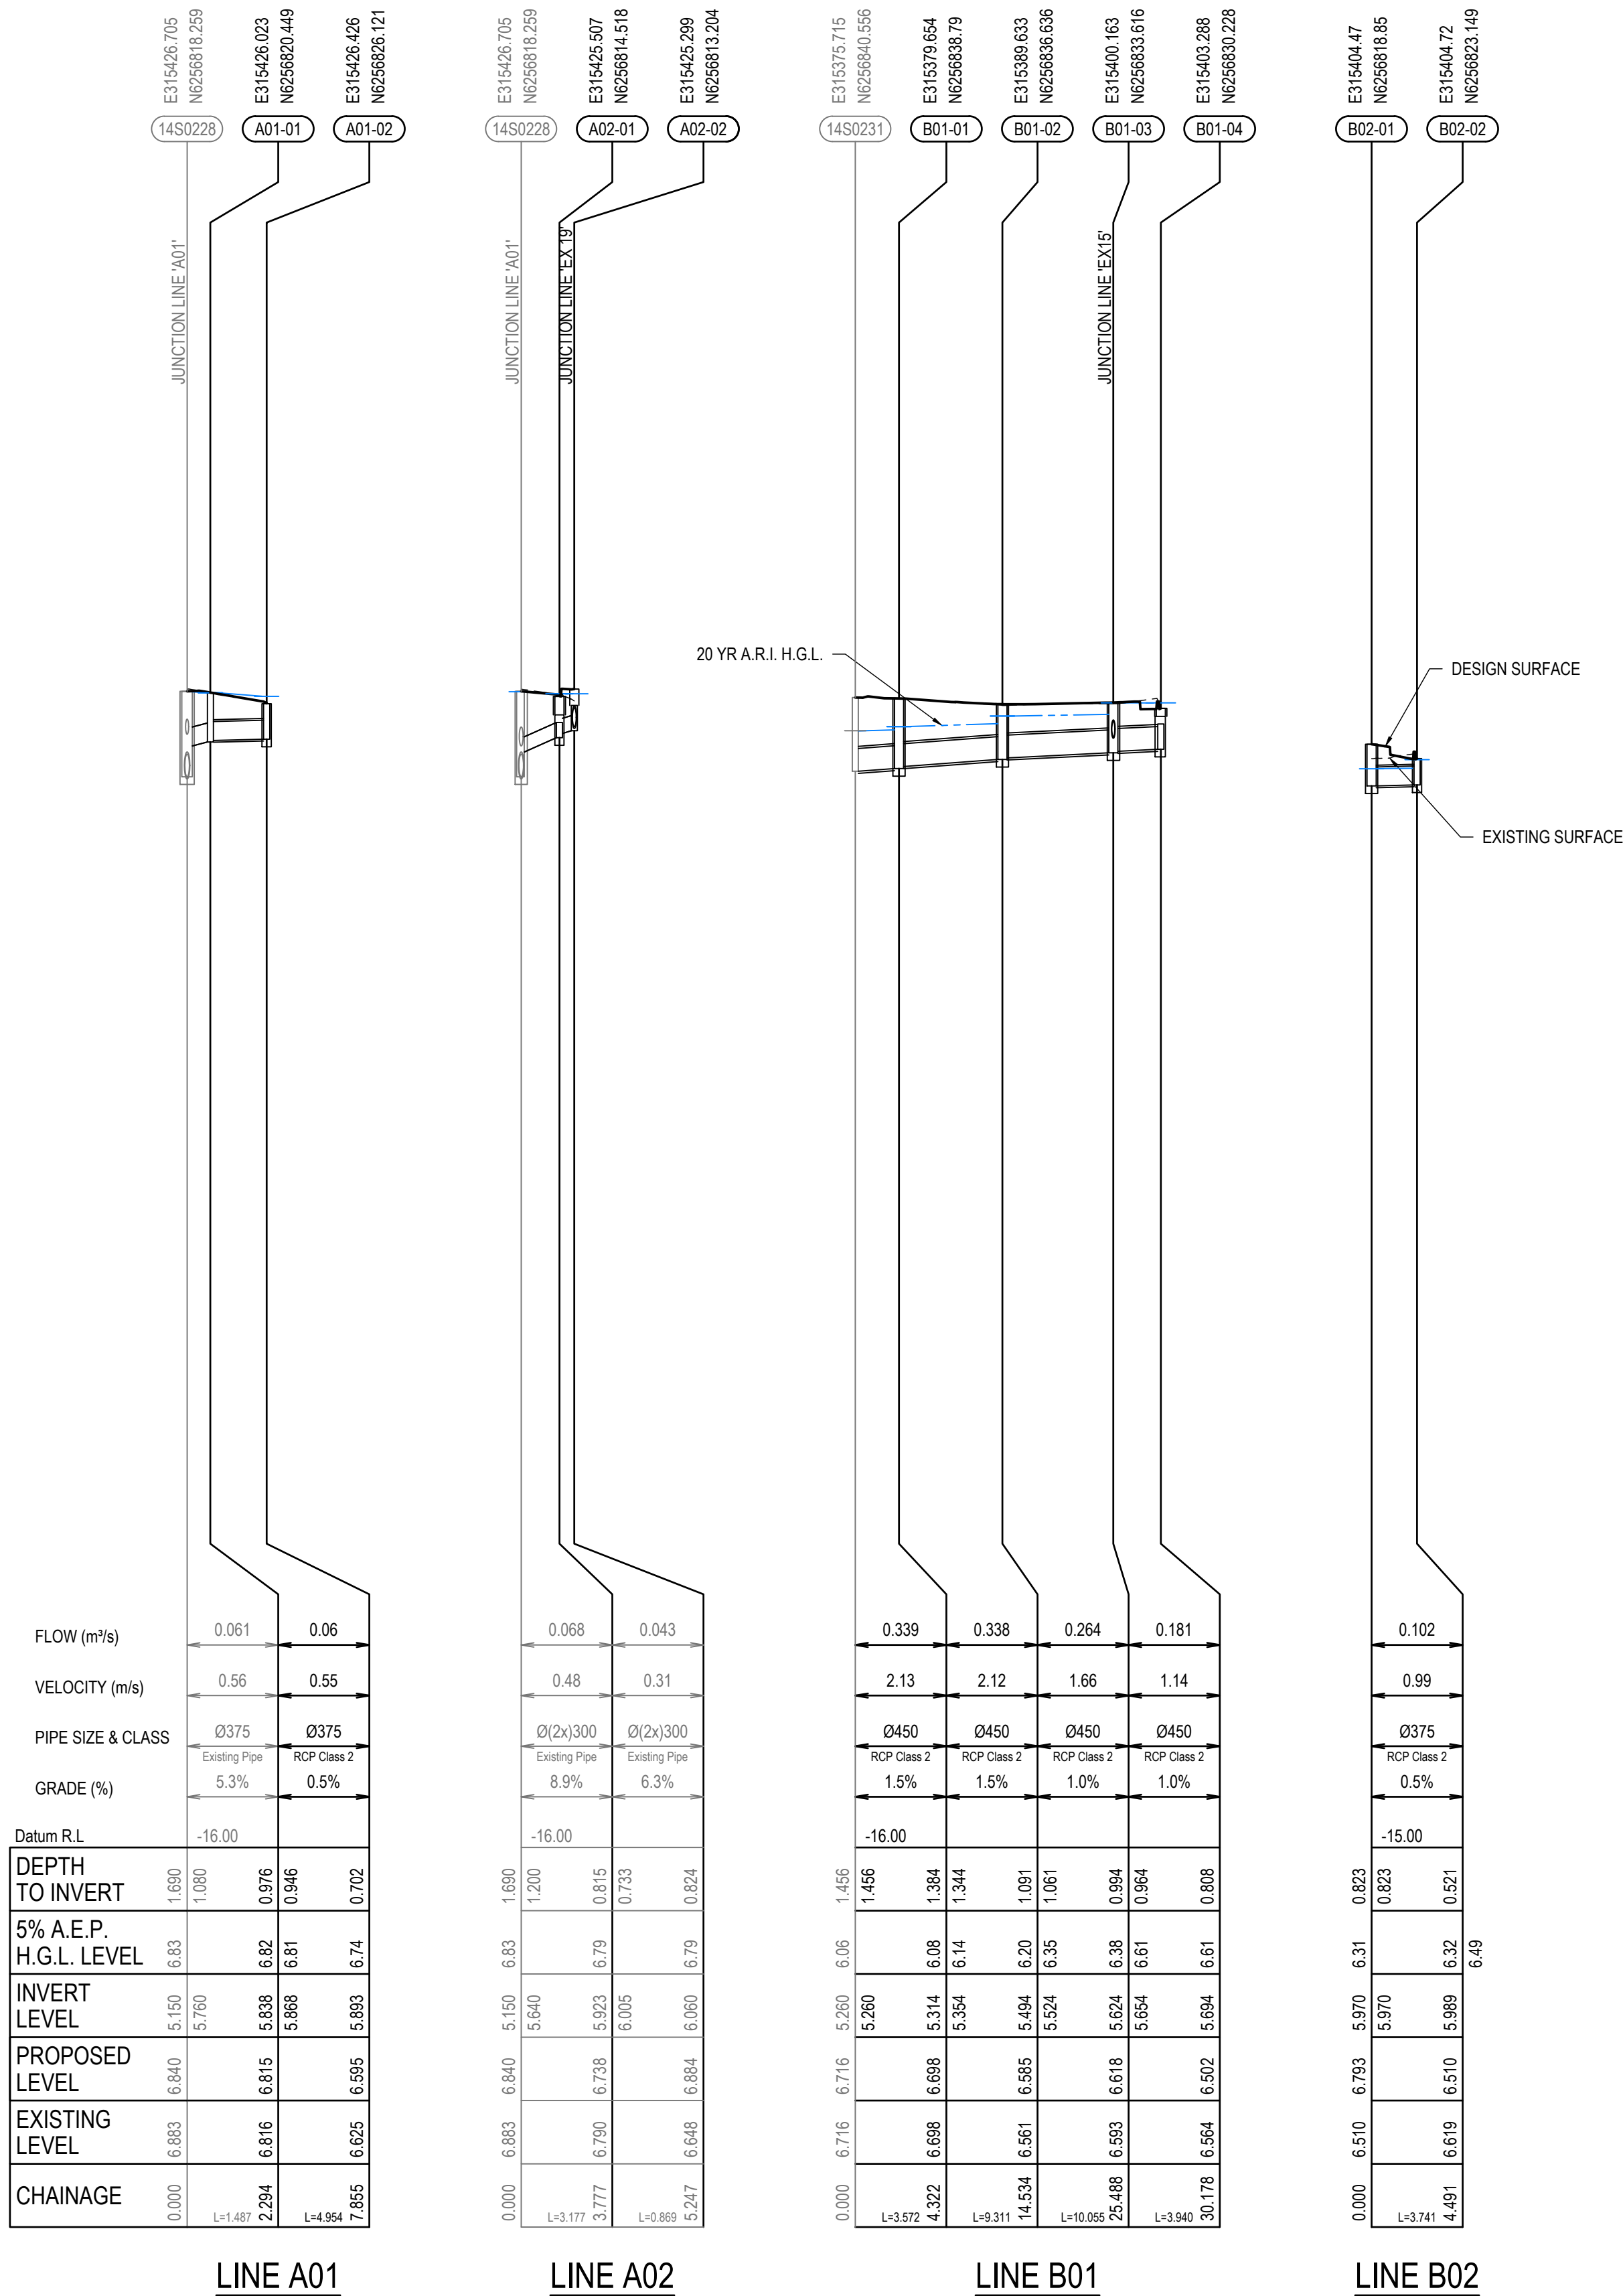

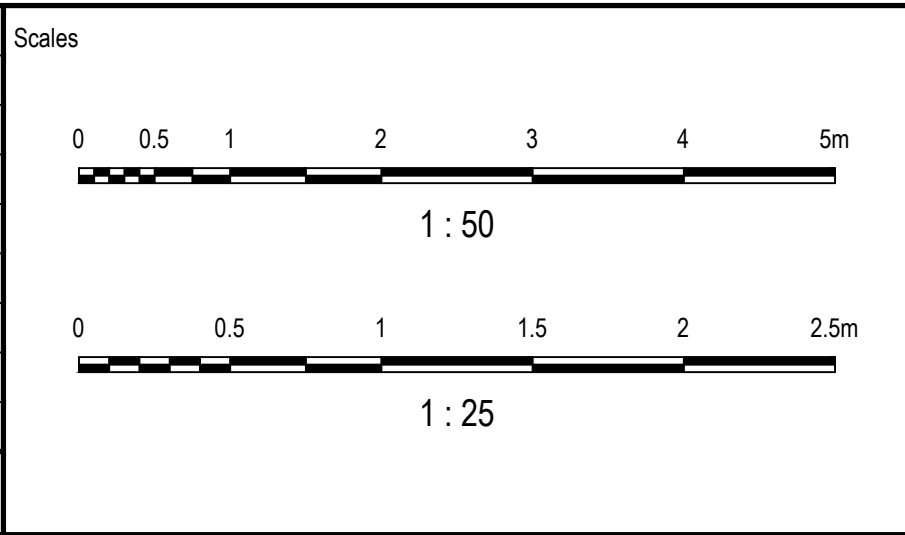Surveyor

Architect



Client

 **CITY OF PARRAMATTA**


Status	PRELIMINARY NOT TO BE USED FOR CONSTRUCTION		
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Original Issue Signatures			
Drawn	R. SANTOS	Original Size	A1
Designed	J. PEÑA	Height Datum	AHD
Project Manager	S. GEERDINK	Grid	MGA/20-56
Verified	G. DUNSTAN		

Project

**PARRAMATTA CIVIC LINK
PHILLIP STREET WORKS**

Title


STORMWATER LONGITUDINAL SECTIONS




Arcadis Australia Pacific Pty Limited
Level 16, 580 George Street
SYDNEY NSW 2000
ABN 76 104 485 289
Tel No: +61 2 8907 9000
www.arcadis.com/au

Project Number	30286862	Issue	03
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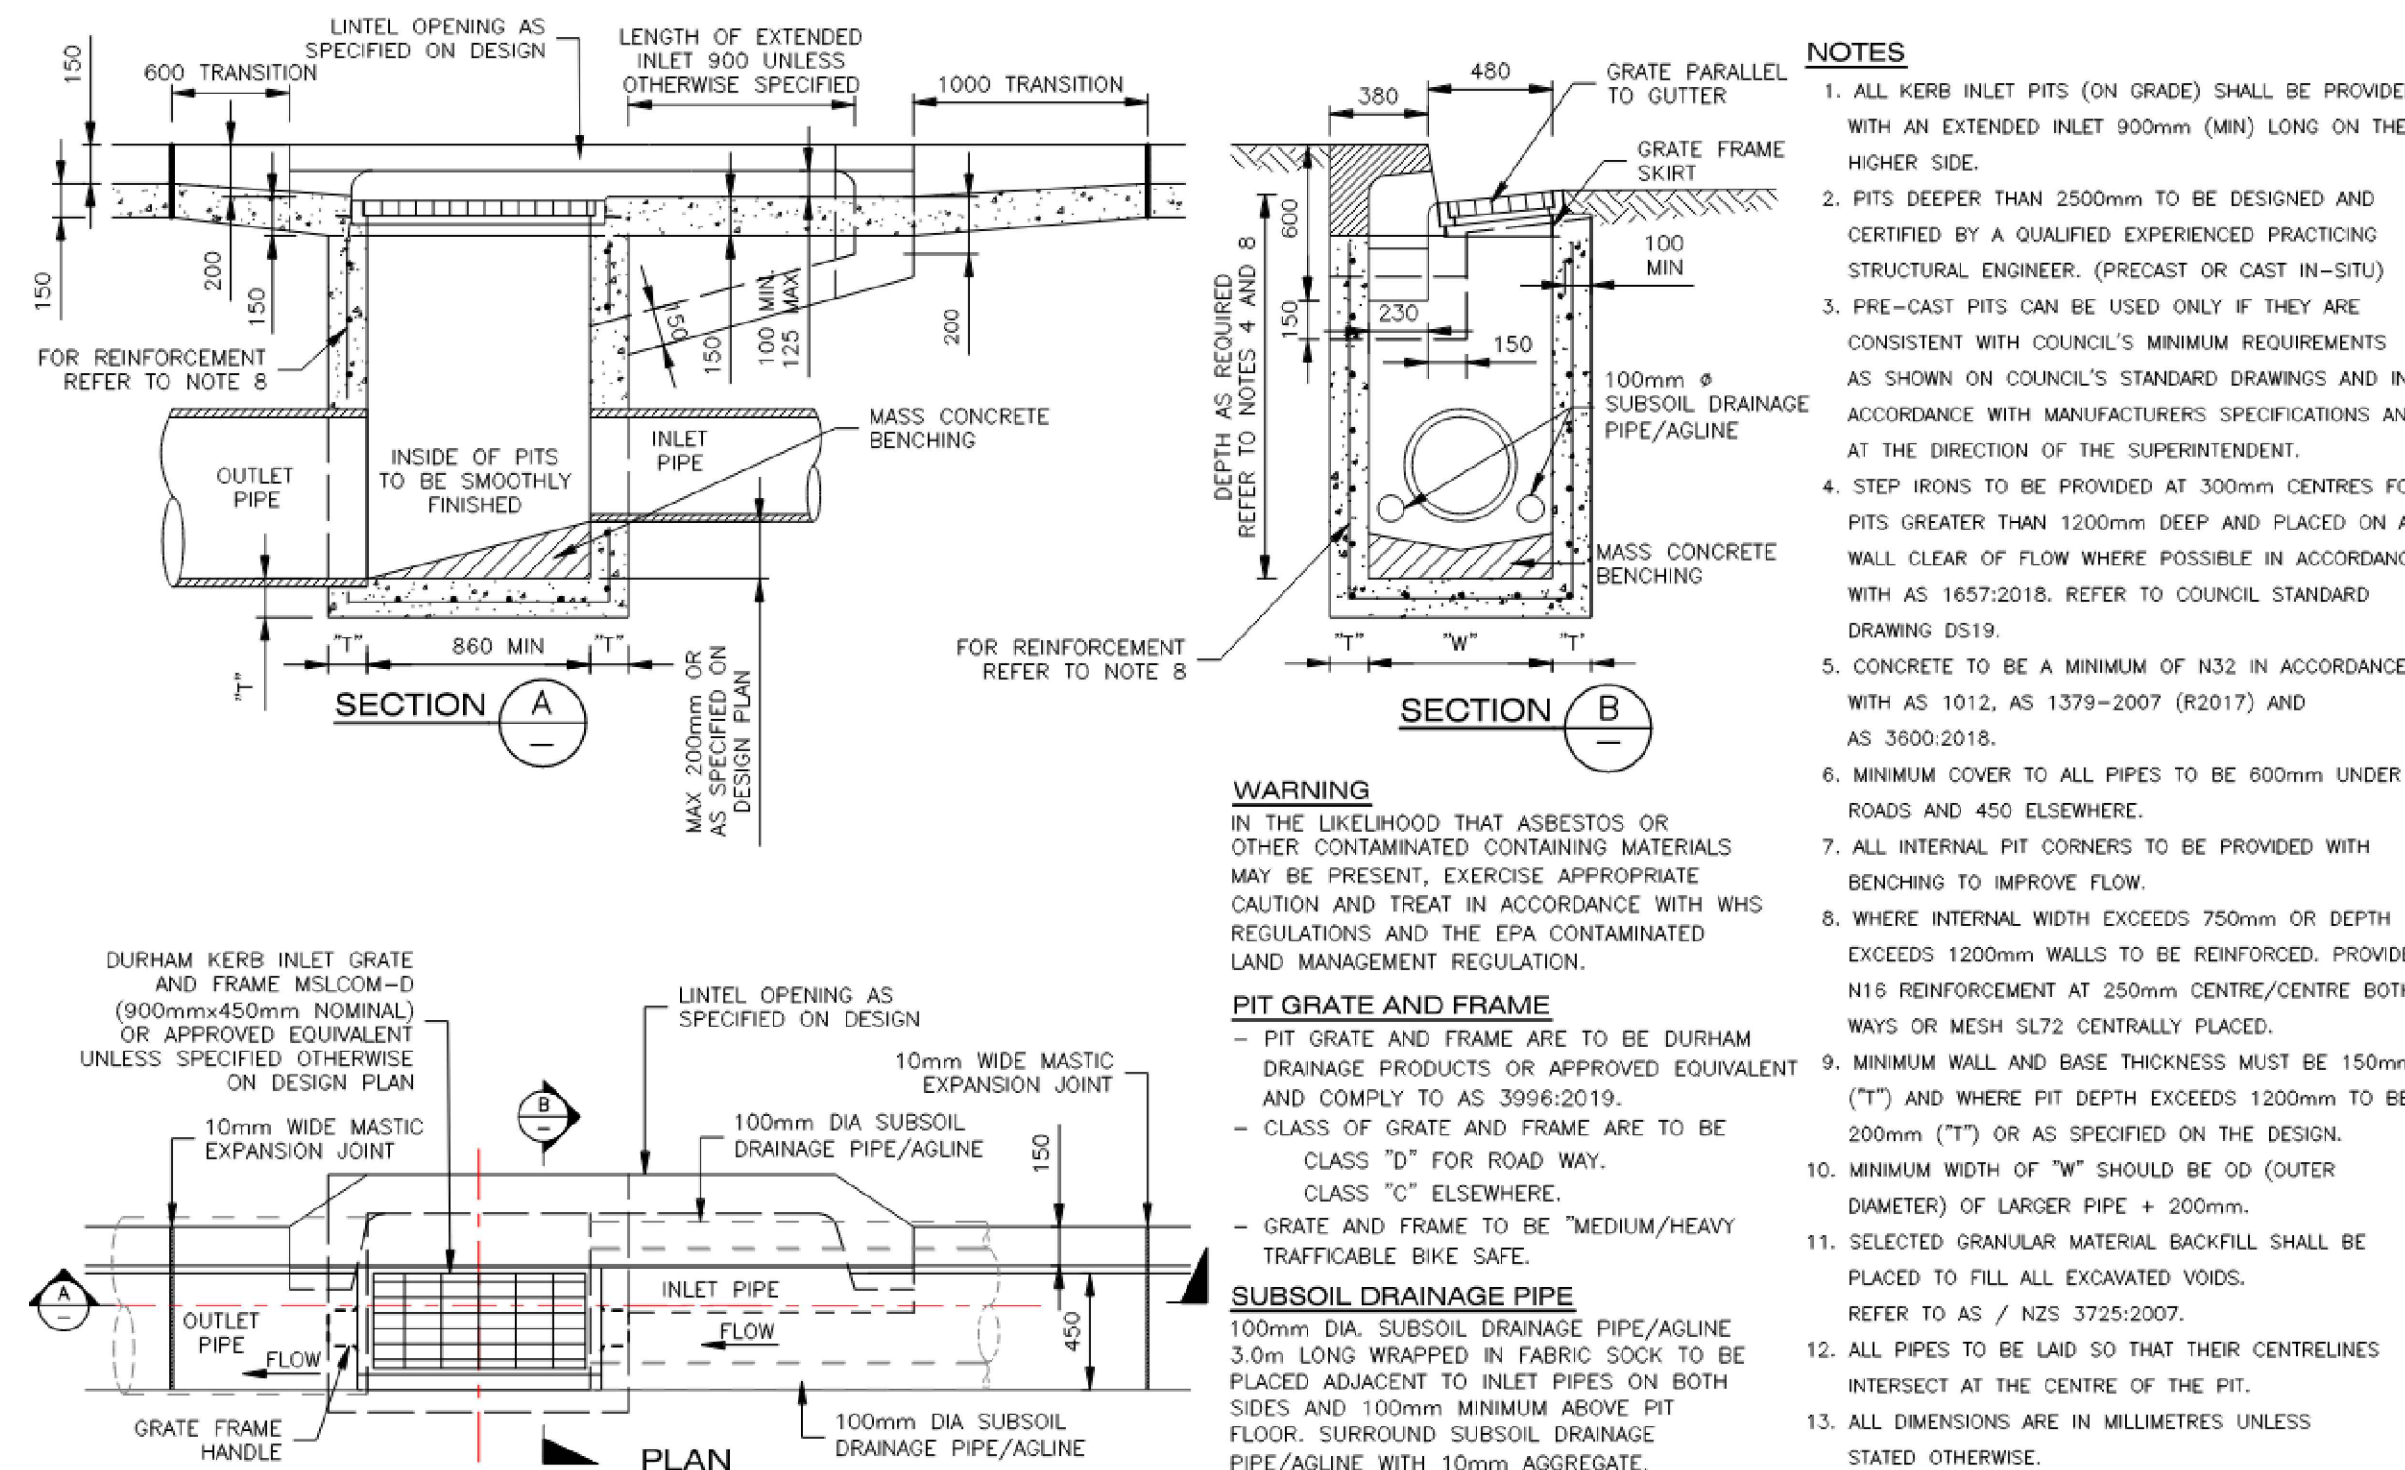
CL3-AAP-DD-PS-DRG-CI-0441

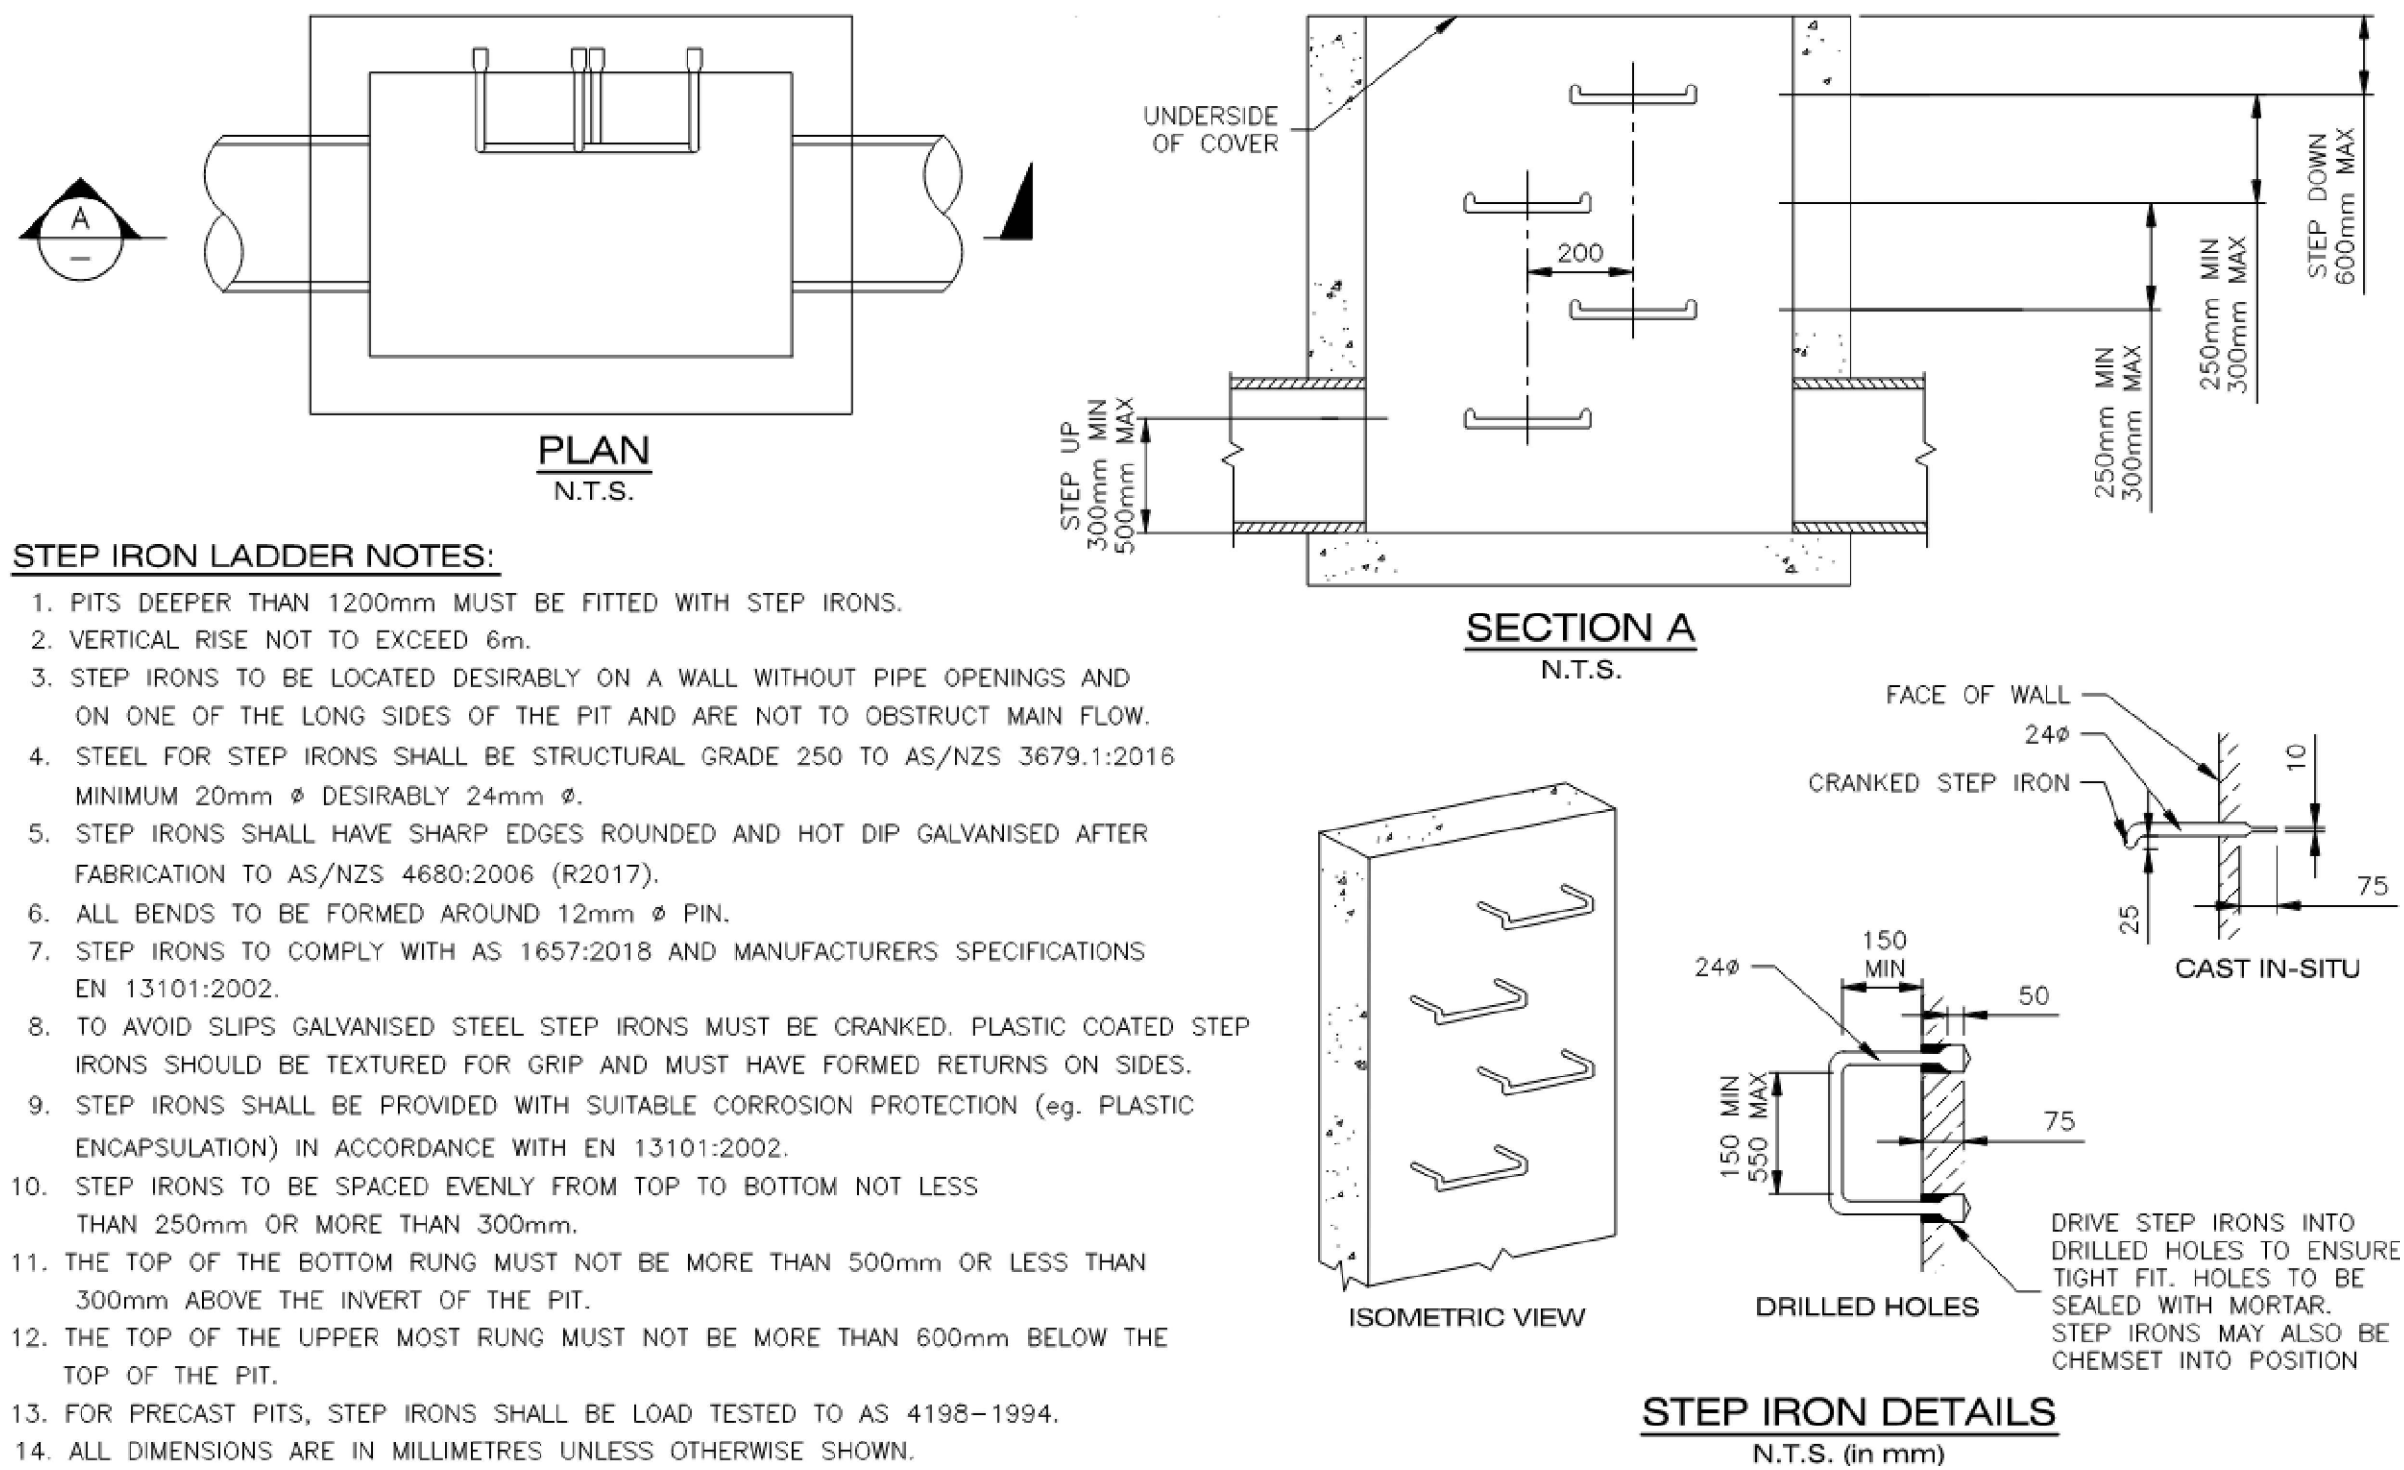


STEP IRONS CITY OF PARAMATTA COUNCIL (DS19)

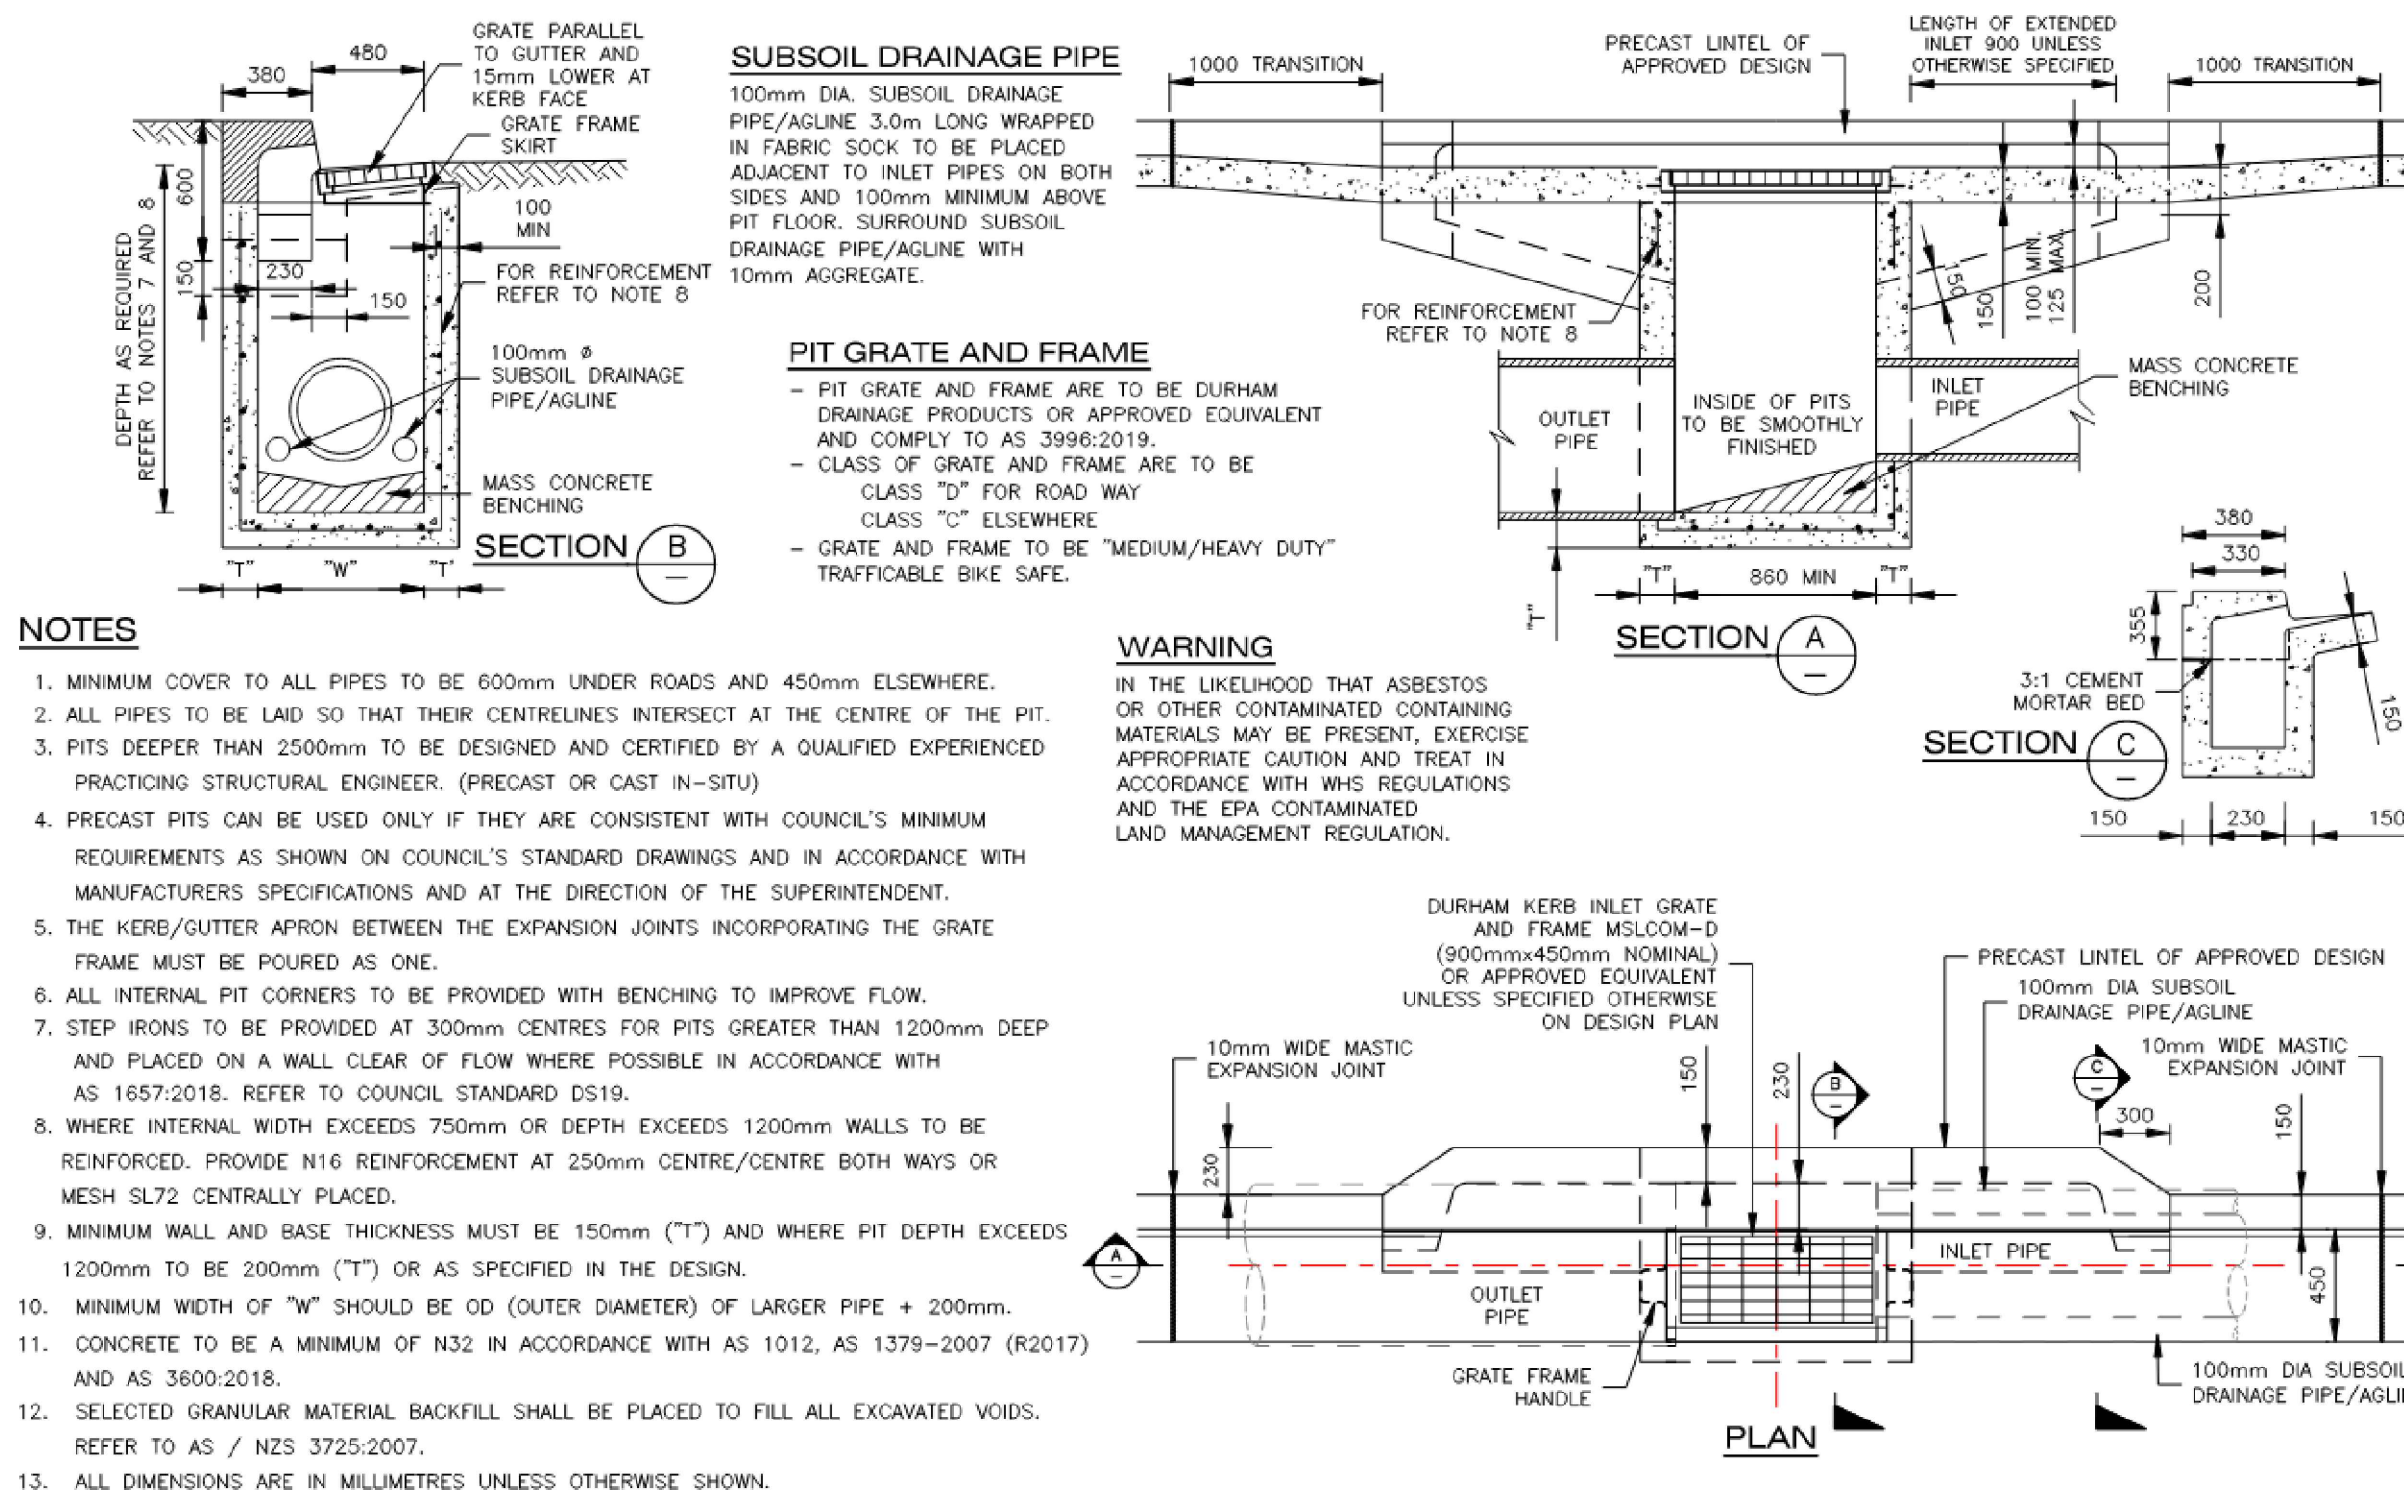

GRATED SAG PIT USING PRECAST LINTEL CITY OF PARAMATTA COUNCIL (DS24)




KERB INLET PIT (ON GRADE) CITY OF PARAMATTA COUNCIL (DS21)

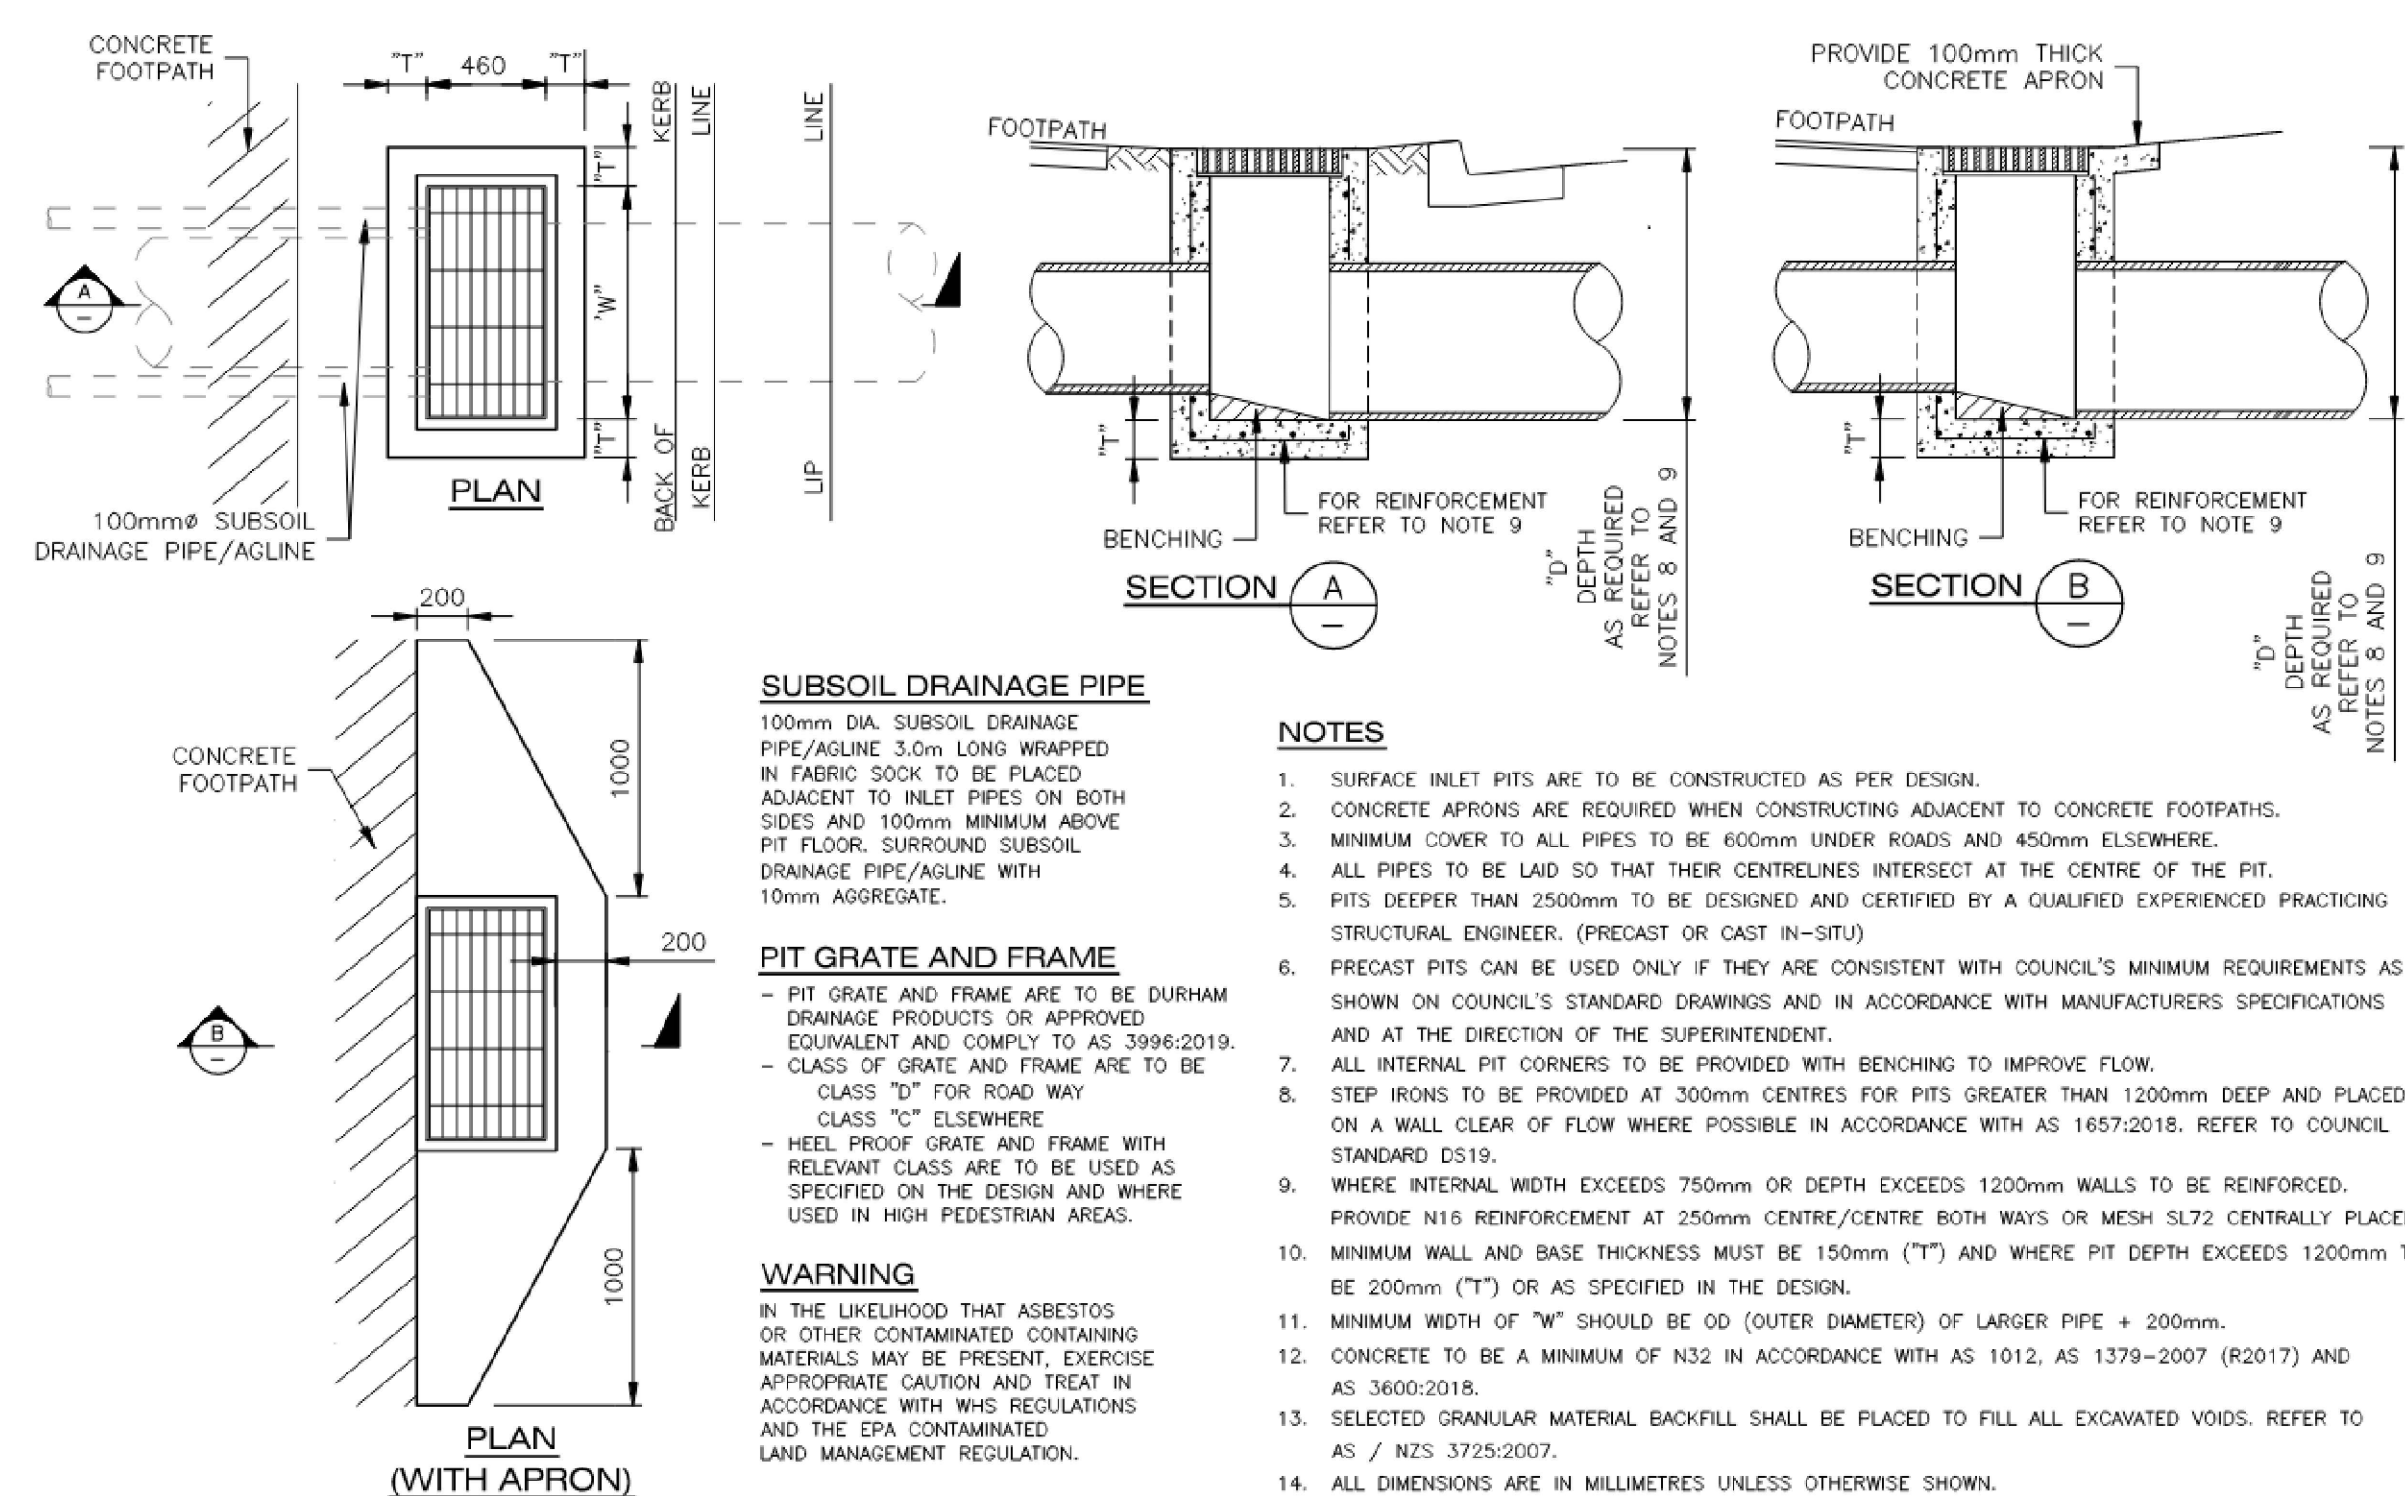


SURFACE INLET PIT CITY OF PARAMATTA COUNCIL (DS25)

					Scales					NOT TO SCALE					<div>Surveyor</div> <div><div><div><div>DURKIN</div></div></div></div> <div>Architect</div> <div><div>OCULUS</div></div>					<div>Client</div> <div><div><div><div>CITY OF PARRAMATTA</div></div></div></div>					<div>Status</div> <div>PRELIMINARY NOT TO BE USED FOR CONSTRUCTION</div> <div>© Copyright reserved</div> <div><div>Original Issue Signatures</div><div><div>Drawn</div><div>R. SANTOS</div><div>Original Size</div><div>A1</div><div>Designed</div><div>J. PEÑA</div><div>Height Datum</div><div>AHD</div><div>Project Manager</div><div>S. GEERDINK</div><div>Grid</div><div>MGA/20-56</div><div>Verified</div><div>G. DUNSTAN</div></div></div>					<div>Project</div> <div>PARRAMATTA CIVIC LINK PHILLIP STREET WORKS</div> <div><div>Title</div><div>STORMWATER DETAILS SHEET 1</div></div>					<div><div></div><div>Arcadis Australia Pacific Pty Limited Level 16, 580 George Street SYDNEY NSW 2000 ABN 76 104 485 289 Tel No: +61 2 8907 9000 www.arcadis.com/au</div><div><div>Project Number</div><div>30286862</div><div>Issue</div><div>03</div></div><div><div>CL3-AAP-DD-PS-DRG-CI-0481</div></div></div>				
03	ISSUED FOR INFORMATION - 100% DETAILED DESIGN				RS	SG	GD	03.10.2025																															
02	ISSUED FOR INFORMATION - 95% DETAILED DESIGN				RS	SG	GD	10.09.2025																															
01	ISSUED FOR INFORMATION - 80% DETAILED DESIGN				RS	CR	MK	18.07.2025																															
Issue	Description				DR	CH	VE	Date																															

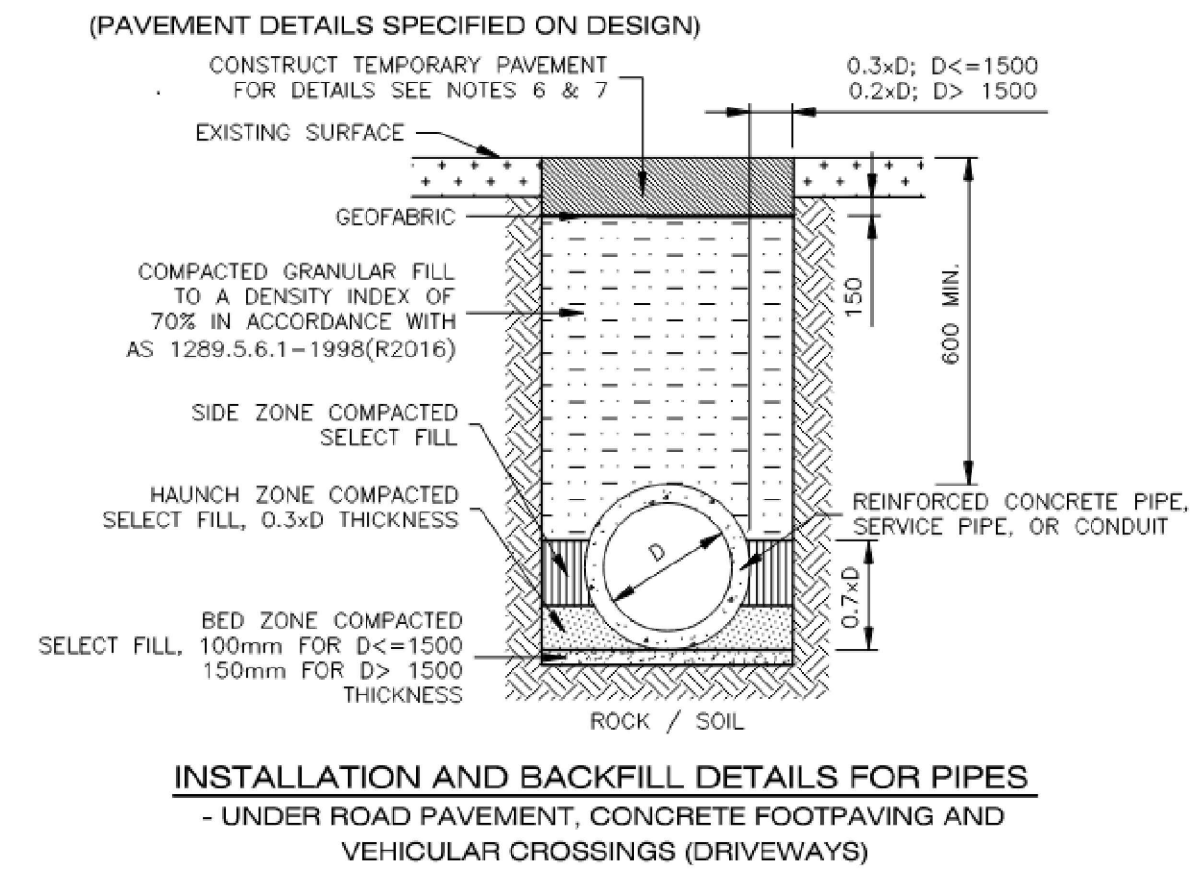


- NOTES**
1. INSTALLATION IS TO CONFORM WITH THE REQUIREMENT OF AS / NZS 3725:2007 FOR TYPE HS3 SUPPORT.
 2. FOR CONCRETE PAVEMENTS BACKFILL IS TO BE LOW STRENGTH 5MPa CONCRETE OR 14:1 SAND:CEMENT MIX.
 3. BEDDING IS TO COMPLY WITH THE REQUIREMENTS OF ANY APPROVAL GIVEN BY A PUBLIC UTILITY AUTHORITY.
 4. MINIMUM COVER OF 600mm SHALL BE PROVIDED TO ALL PIPELINES, INCLUDING SERVICES CONDUITS. SPECIFIC APPROVAL WILL BE REQUIRED FROM COUNCIL TO VARY THIS REQUIREMENT.
 5. CONCRETE VEHICULAR CROSSINGS SHALL BE SAWCUT ONCE ONLY (ALONG NEAREST JOINT) AND RESTORED TO LEAVE TWO SECTIONS ONLY.
 6. TEMPORARY PAVEMENT FOR ROADWAY AND VEHICULAR CROSSING (DRIVEWAY) RESTORATION SHALL CONSIST OF 30-50mm BITUMINOUS COLD MIX OVER COMPACTED FINE CRUSHED ROCK (GRADED TO DGB20). TOTAL ROADWAY PAVEMENT THICKNESS IS TO BE EQUIVALENT TO THE EXISTING PAVEMENT THICKNESS PLUS 150mm (300mm MIN. THICKNESS SHALL APPLY).
 7. TEMPORARY PAVEMENT FOR FOOTPAVING SHALL CONSIST OF 30-50mm BITUMINOUS COLD MIX OVER 100mm (MIN. THICKNESS) OF COMPACTED FINE CRUSHED ROCK (GRADED TO DGB20).
 8. ALL DIMENSIONS ARE IN MILLIMETRES UNLESS OTHERWISE SHOWN.

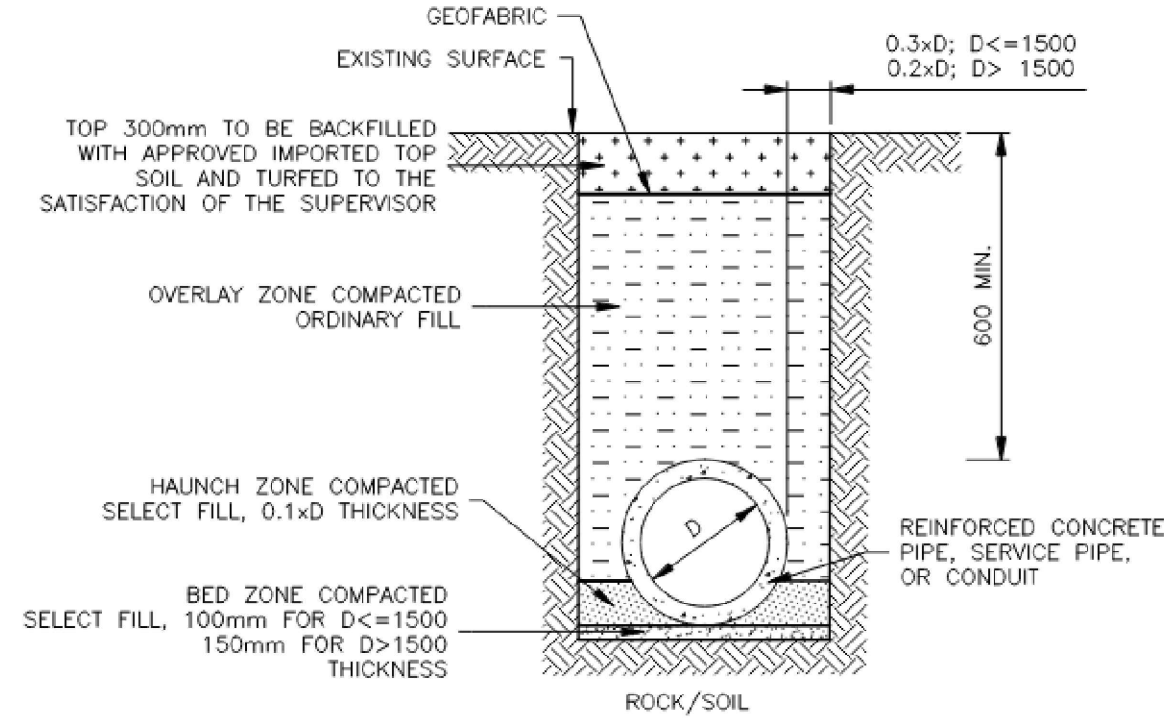

- NOTES**
1. INSTALLATION IS TO CONFORM WITH THE REQUIREMENT OF AS / NZS 3725:2007 FOR TYPE HS1 SUPPORT.
 2. ALL DIMENSIONS ARE IN MILLIMETRES UNLESS OTHERWISE SHOWN.
- WARNING**
- IN THE LIKELIHOOD THAT ASBESTOS OR OTHER CONTAMINATED CONTAINING MATERIALS MAY BE PRESENT, EXERCISE APPROPRIATE CAUTION AND TREAT IN ACCORDANCE WITH WHS REGULATIONS AND THE EPA CONTAMINATED LAND MANAGEMENT REGULATION.

INSTALLATION OF PIPELINES AND RESTORATION OF TRENCHES (DRAINAGE)
CITY OF PARAMATTA COUNCIL (DS37)

						Scales	Surveyor		Client	Status				Project		ARCADIS	
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							Drawn			R. SANTOS		Original Size					
						Designed		J. PEÑA		Height Datum		AHD		Title			
						Project Manager		S. GEERDINK		Grid		MGA/20-56					
						Verified		G. DUNSTAN									

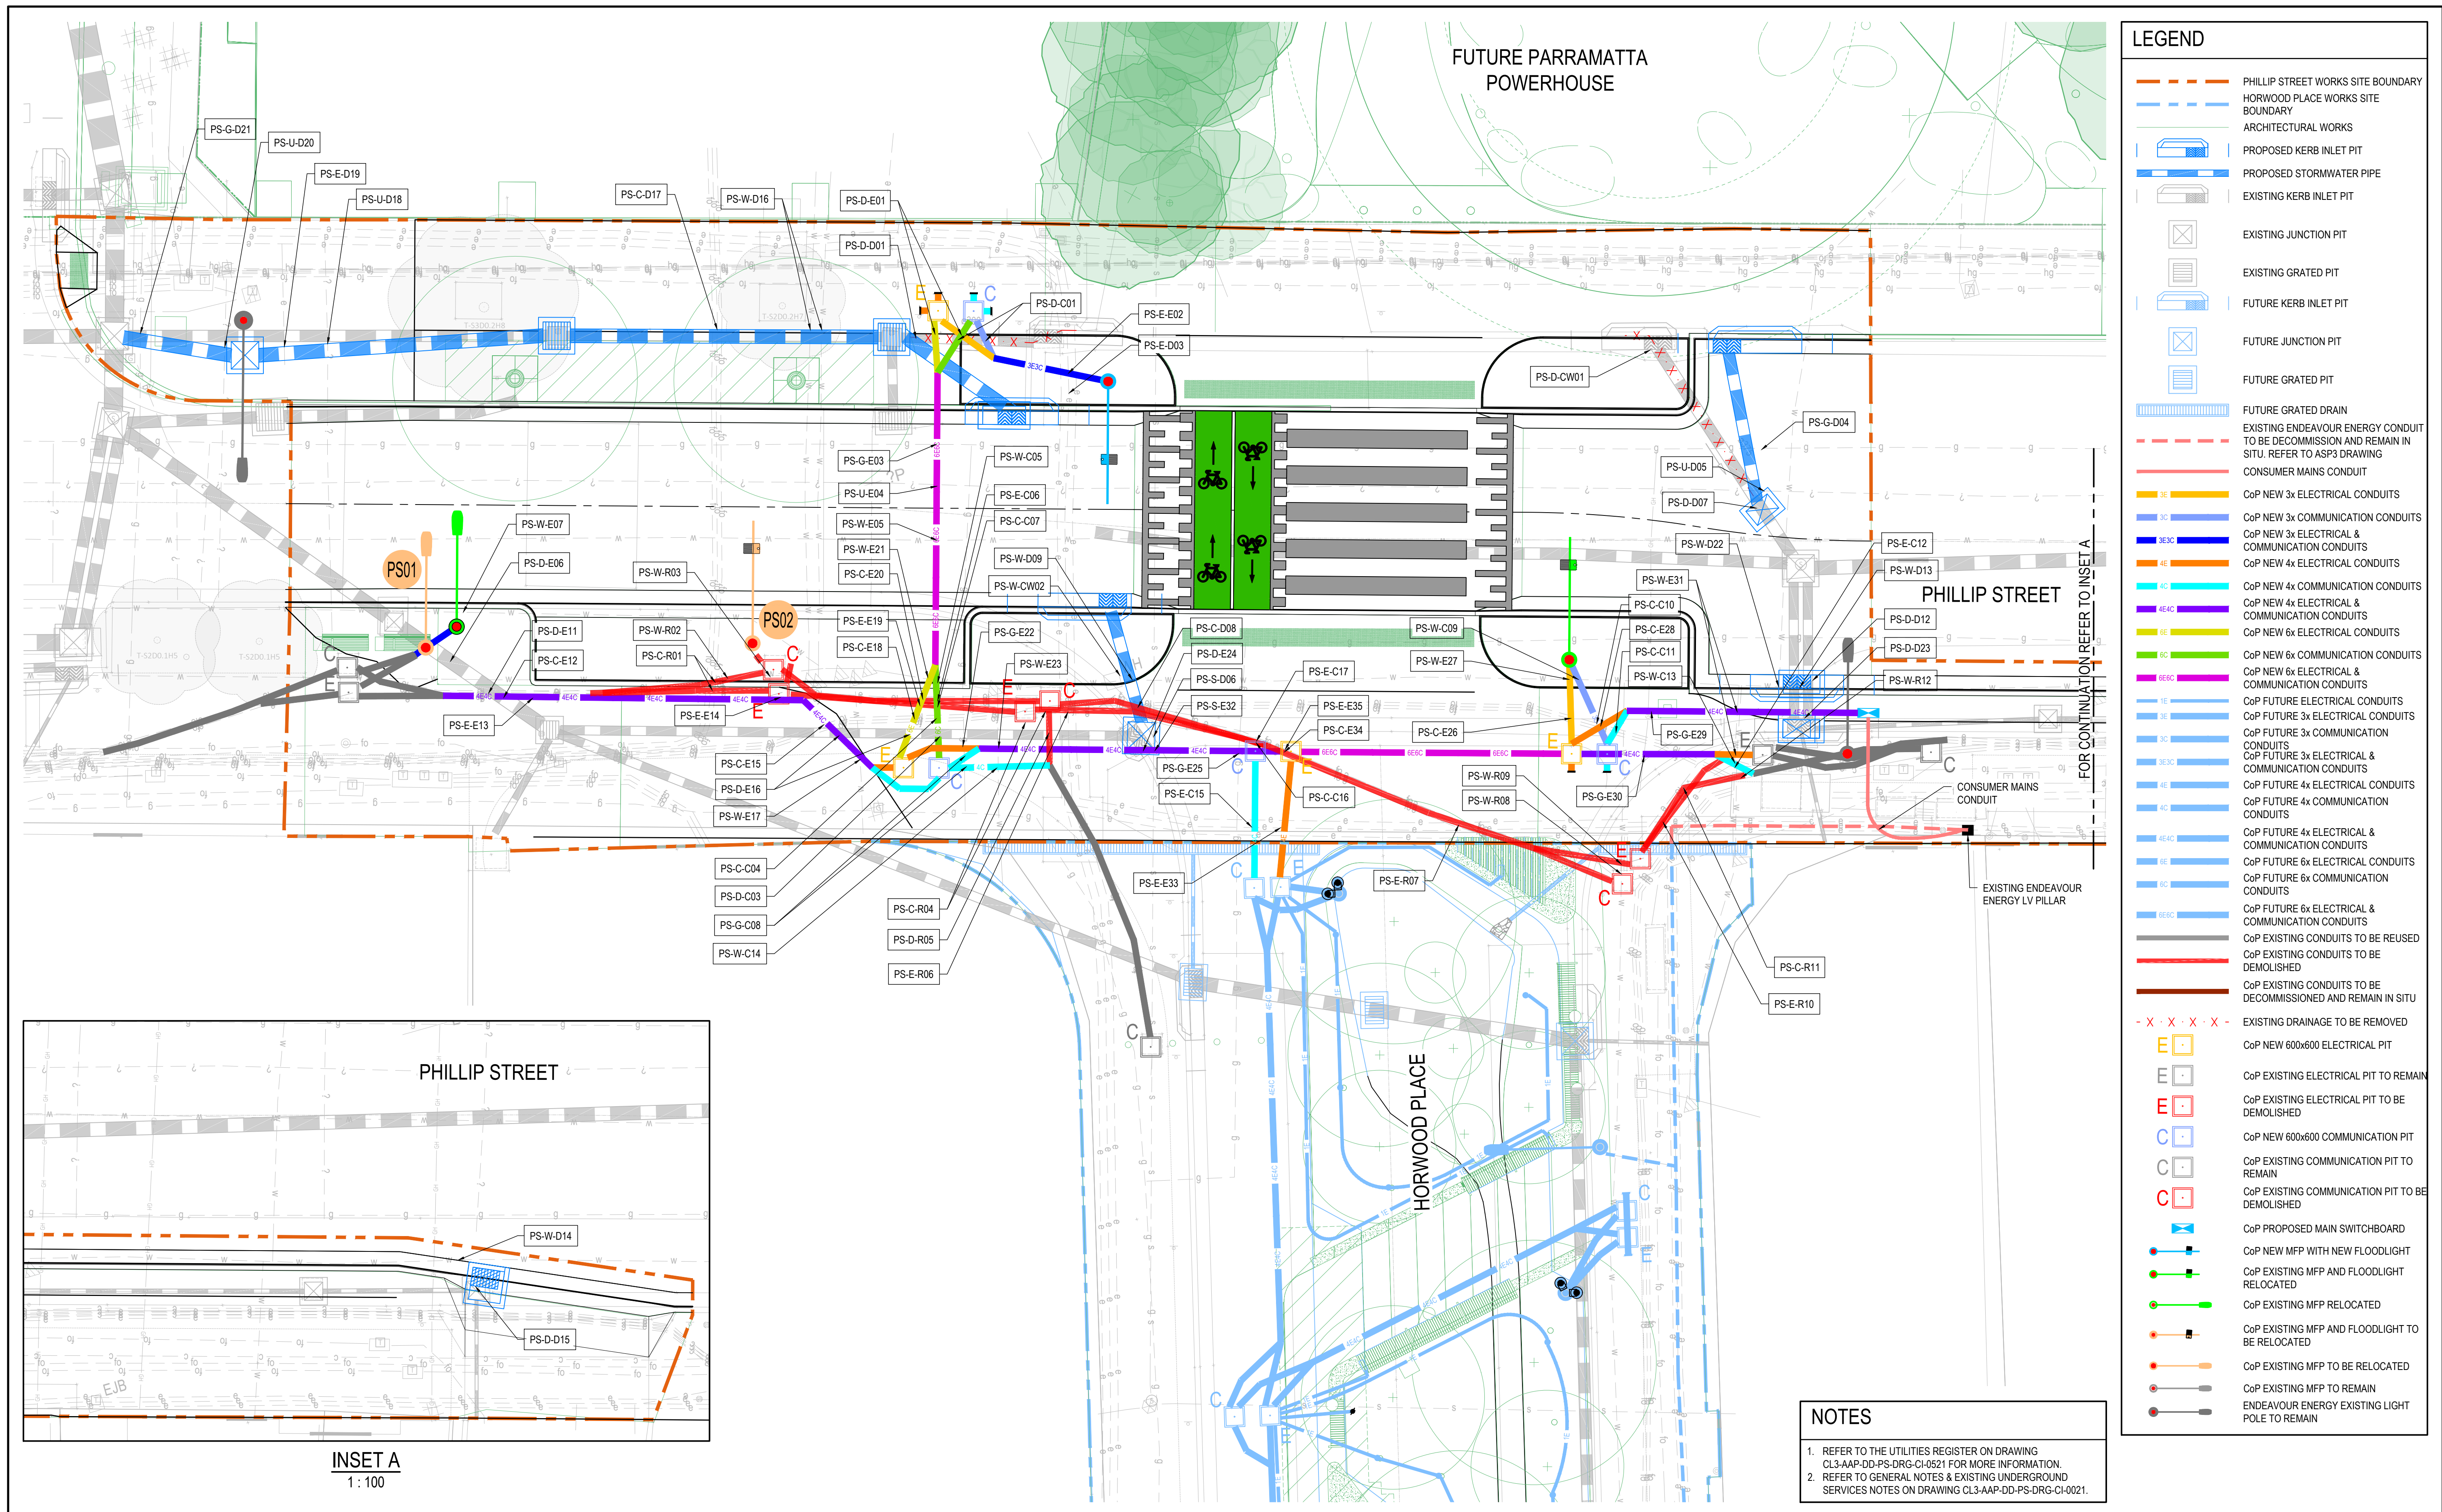


LEGEND	
	PHILLIP STREET WORKS SITE BOUNDARY
	HORWOOD PLACE WORKS SITE BOUNDARY
	ARCHITECTURAL WORKS
	PROPOSED KERB INLET PIT
	PROPOSED STORMWATER PIPE
	EXISTING KERB INLET PIT
	EXISTING JUNCTION PIT
	EXISTING GRATED PIT
	FUTURE KERB INLET PIT
	FUTURE JUNCTION PIT
	FUTURE GRATED PIT
	FUTURE GRATED DRAIN
	EXISTING ENDEAVOUR ENERGY CONDUIT TO BE DECOMMISSIONED AND REMAIN IN SITU. REFER TO ASP3 DRAWING
	CONSUMER MAINS CONDUIT
	COP NEW 3x ELECTRICAL CONDUITS
	COP NEW 3x COMMUNICATION CONDUITS
	COP NEW 3x ELECTRICAL & COMMUNICATION CONDUITS
	COP NEW 4x ELECTRICAL CONDUITS
	COP NEW 4x COMMUNICATION CONDUITS
	COP NEW 4x ELECTRICAL & COMMUNICATION CONDUITS
	COP NEW 6x ELECTRICAL CONDUITS
	COP NEW 6x COMMUNICATION CONDUITS
	COP NEW 6x ELECTRICAL & COMMUNICATION CONDUITS
	COP FUTURE 3x ELECTRICAL CONDUITS
	COP FUTURE 3x COMMUNICATION CONDUITS
	COP FUTURE 3x ELECTRICAL & COMMUNICATION CONDUITS
	COP FUTURE 4x ELECTRICAL CONDUITS
	COP FUTURE 4x COMMUNICATION CONDUITS
	COP FUTURE 4x ELECTRICAL & COMMUNICATION CONDUITS
	COP FUTURE 6x ELECTRICAL CONDUITS
	COP FUTURE 6x COMMUNICATION CONDUITS
	COP FUTURE 6x ELECTRICAL & COMMUNICATION CONDUITS
	COP EXISTING CONDUITS TO BE REUSED
	COP EXISTING CONDUITS TO BE DEMOLISHED
	COP EXISTING CONDUITS TO BE DECOMMISSIONED AND REMAIN IN SITU
	EXISTING DRAINAGE TO BE REMOVED
	COP NEW 600x600 ELECTRICAL PIT
	COP EXISTING ELECTRICAL PIT TO REMAIN
	COP EXISTING ELECTRICAL PIT TO BE DEMOLISHED
	COP NEW 600x600 COMMUNICATION PIT
	COP EXISTING COMMUNICATION PIT TO REMAIN
	COP EXISTING COMMUNICATION PIT TO BE DEMOLISHED
	COP PROPOSED MAIN SWITCHBOARD
	COP NEW MFP WITH NEW FLOODLIGHT
	COP EXISTING MFP AND FLOODLIGHT RELOCATED
	COP EXISTING MFP RELOCATED
	COP EXISTING MFP AND FLOODLIGHT TO BE RELOCATED
	COP EXISTING MFP TO BE RELOCATED
	COP EXISTING MFP TO REMAIN
	ENDEAVOUR ENERGY EXISTING LIGHT POLE TO REMAIN

NOTES

- REFER TO THE UTILITIES REGISTER ON DRAWING CL3-AAP-DD-PS-DRG-CI-0521 FOR MORE INFORMATION.
- REFER TO GENERAL NOTES & EXISTING UNDERGROUND SERVICES NOTES ON DRAWING CL3-AAP-DD-PS-DRG-CI-0021.

Issue	Description	DR	CH	VE	Date
03	ISSUED FOR INFORMATION - 100% DETAILED DESIGN	RS	CN	GD	03.10.2025
02	ISSUED FOR INFORMATION - 95% DETAILED DESIGN	RS	CN	GD	10.09.2025
01	ISSUED FOR INFORMATION - 80% DETAILED DESIGN	RS	CR	MK	18.07.2025

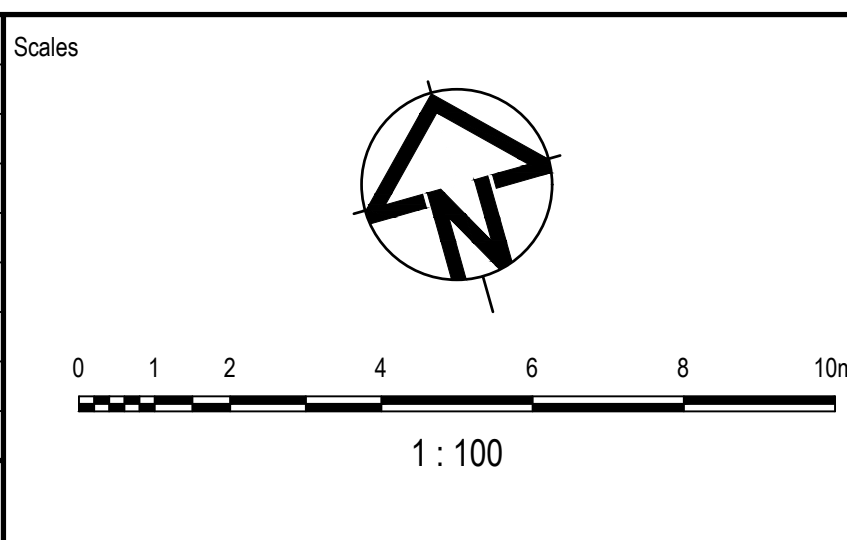

Surveyor

Architect

Client

Status

PRELIMINARY
NOT TO BE USED FOR CONSTRUCTION

Original Issue Signatures

Drawn	R. SANTOS	Original Size	A1
Designed	C. NUGPO	Height Datum	AHD
Project Manager	S. GEERDINK	Grid	MGA/20-56
Verified	G. DUNSTAN		

Project

PARRAMATTA CIVIC LINK
PHILLIP STREET WORKS

Utilities Register
PLAN

Arcadis Australia Pacific Pty Limited
Level 16, 580 George Street
SYDNEY NSW 2000
ABN 76 104 485 289
Tel No: +61 2 8907 9000
www.arcadis.com/au

Project Number	30286862
Issue	03

CL3-AAP-DD-PS-DRG-CI-0511

EXISTING UNDERGROUND UTILITIES - PHILLIP STREET (EARLY WORKS)						
Clash ID (Phillip Street- Existing Asset- Proposed Asset [Interface Number])	Existing Asset Classification	Existing Asset Information	Asset Owner	Clash Description	Criticality	Proposed Action
PS-G-D21	Gas	Unknown	Jemena	Proposed drainage will cross existing gas with approx. 850mm cover.	Medium	Coordinate
PS-U-D20	Unknown	TBC	TBC	Proposed drainage will cross existing unknown with approx. 800mm cover.	Low	Identify
PS-E-D19	Electrical	Unknown	Endeavour Energy	Proposed drainage will cross existing electrical.	Low	Coordinate
PS-U-D18	Unknown	TBC	TBC	Proposed drainage will cross existing unknown with approx. 500mm cover.	Low	Identify
PS-C-D17	Communications	TBC	TBC	Proposed drainage will cross existing communications with approx. 900mm cover.	Low	Coordinate
PS-W-D16	Potable water	Property connection	Sydney Water	Proposed drainage will cross existing potable water with approx. 600mm cover.	Low	Protect
PS-D-E01	Drainage	DN375	Council	Proposed electrical will cross existing drainage.	Low	Remove
PS-D-D01	Drainage	DN375	Council	Proposed drainage will cross existing drainage.	Low	Remove
PS-D-C01	Drainage	DN375	Council	Proposed communications will cross existing drainage.	Low	Remove
PS-E-E02	Electrical	"1 x 2 DN50 PVC 2 x 3 DN140 Fibro Conduit (Asbestos)"	Endeavour Energy	Proposed electrical will cross existing electrical with approx. 900mm cover.	High	Coordinate
PS-E-D03	Electrical	"1 x 2 DN50 PVC 2 x 3 DN140 Fibro Conduit (Asbestos)"	Endeavour Energy	Proposed drainage pit will be adjacent to existing electrical with approx. 900mm cover.	High	Coordinate
PS-D-CW01	Drainage	Kerb inlet pit and DN375	Council	Proposed civil works clash with existing drainage.	Low	Relocate
PS-G-D04	Gas	"DN50 NY 7kPa low pressure"	Jemena	Proposed drainage will cross existing gas with approx. 600mm cover.	Medium	Coordinate
PS-U-D05	Unknown	TBC	TBC	Proposed drainage will cross existing unknown with approx. 1.08m cover.	Low	Identify
PS-D-D07	Drainage	DN375	Council	Proposed drainage pit clashes with existing drainage.	Low	Coordinate
PS-G-E03	Gas	7kPa low pressure	Jemena	Proposed electrical will cross existing gas with approx. 500mm cover.	Medium	Coordinate
PS-U-E04	Unknown	TBC	TBC	Proposed electrical will cross existing unknown with approx. 1m cover.	Low	Identify
PS-W-E05	Potable water	DN900 CICL	Sydney Water	Proposed electrical will cross existing potable water with approx. 1.3m cover.	High	Protect
PS-W-E07	Potable water	DN200 oPVC	Sydney Water	Proposed light pole footing will be adjacent to existing potable water with approx. 900m cover.	Medium	Protect
PS-D-E06	Drainage	DN450	Council	Proposed light pole footing will be adjacent to existing drainage.	Low	Coordinate
PS-D-E11	Drainage	DN450	Council	Proposed electrical will cross existing drainage.	Low	Coordinate
PS-C-E12	Communications	TBC	TBC	Proposed electrical will run along adjacent to existing communications with approx. 400mm cover.	Low	Coordinate
PS-E-E13	Electrical	Unknown	Council (TBC)	Proposed electrical will run along adjacent to existing electrical with approx. 400mm cover.	Low	Coordinate
PS-W-R03	Potable water	Abandoned	Sydney Water	Existing communications pit to be demolished crosses existing potable water.	Low	Identify
PS-W-R02	Potable water	Abandoned	Sydney Water	Existing conduits to be removed cross existing potable water.	Low	Identify
PS-C-R01	Communications	TBC	TBC	Existing conduits to be removed cross existing communications with approx. 1m cover.	Low	Protect
PS-E-E14	Electrical	Electrical pit	Council (TBC)	Proposed electrical clashes with existing electrical pit. Existing pit to be demolished.	Low	Remove
PS-C-E15	Communications	TBC	TBC	Proposed electrical will cross existing communications with approx. 900mm cover.	Low	Coordinate
PS-D-E16	Drainage	DN300	Council	Proposed electrical will cross existing drainage.	Low	Coordinate
PS-W-E17	Potable water	Property connection	Sydney Water	Proposed electrical will cross existing potable water with approx. 500mm cover.	Low	Protect
PS-C-C04	Communications	TBC	TBC	Proposed communications will cross existing communications with approx. 1.3m cover.	Low	Coordinate
PS-D-C03	Drainage	DN300	Council	Proposed communications will cross existing drainage.	Low	Coordinate
PS-G-C08	Gas	7kPa low pressure	Jemena	Proposed communications will cross existing gas with approx. 600mm cover.	Medium	Coordinate
PS-W-C14	Potable water	Property connection	Sydney Water	Proposed communications will cross existing potable water with approx. 850mm cover.	Low	Protect
PS-W-E21	Potable water	DN150 CICL	Sydney Water	Proposed electrical will cross existing potable water with approx. 900mm cover.	Medium	Protect
PS-C-E20	Communications	TBC	TBC	Proposed electrical will cross existing communications with approx. 500mm cover. Existing communications conduit to be demolished.	Low	Remove
PS-E-E19	Electrical	Unknown	Endeavour Energy / Council (TBC)	Proposed electrical will cross existing electrical with approx. 500mm cover. Existing electrical conduit to be demolished.	Low	Remove
PS-C-E18	Communications	TBC	TBC	Proposed electrical will cross existing communications with approx. 1.3m cover.	Low	Coordinate
PS-W-C05	Potable water	DN150 CICL	Sydney Water	Proposed communications will cross existing potable water with approx. 900mm cover.	Medium	Protect
PS-E-C06	Electrical	Unknown	Endeavour Energy / Council (TBC)	Proposed communications will cross existing electrical with approx. 500mm cover. Existing electrical conduit to be demolished.	Low	Remove
PS-C-C07	Communications	TBC	TBC	Proposed communications will cross existing communications with approx. 500mm cover. Existing communications conduit to be demolished.	Low	Remove
PS-W-D09	Potable water	DN150 CICL	Sydney Water	Proposed drainage will cross existing potable water with approx. 800mm cover.	Medium	Protect
PS-W-CW02	Potable water	Hydrant	Sydney Water	Proposed civil works clash with existing potable water hydrant.	High	Coordinate
PS-G-E22	Gas	7kPa low pressure	Jemena	Proposed electrical will cross existing gas with approx. 600mm cover.	Medium	Coordinate


EXISTING UNDERGROUND UTILITIES - PHILLIP STREET (EARLY WORKS)						
Clash ID (Phillip Street- Existing Asset- Proposed Asset [Interface Number])	Existing Asset Classification	Existing Asset Information	Asset Owner	Clash Description	Criticality	Proposed Action
PS-W-E23	Potable water	Property connection	Sydney Water	Proposed electrical will cross existing potable water with approx. 850mm cover.	Low	Protect
PS-C-R04	Communications	TBC	TBC	Existing communications pit and electrical pit to be removed cross existing communications with approx. 650mm cover.	Low	Protect
PS-D-R05	Drainage	DN300	Council	Existing conduits to be removed cross existing drainage.	Low	Protect
PS-E-R06	Electrical	"1 x 2 DN50 PVC 2 x 3 DN140 Fibro Conduit (Asbestos)"	Endeavour Energy	Existing electrical pit to be removed is adjacent to existing electrical with approx. 900mm cover.	High	Protect
PS-C-D08	Communications	TBC	TBC	Proposed drainage will cross existing communications with approx. 450mm cover.	Low	Coordinate
PS-D-E24	Drainage	Kerb inlet pit	Council	New pit to replace existing. Proposed electrical clashes with new drainage pit.	Medium	Coordinate
PS-S-E32	Sewer	DN225 VC	Sydney Water	Proposed electrical will cross existing sewer.	Low	Protect
PS-S-D06	Sewer	DN225 VC	Sydney Water	Proposed stormwater pit will cross existing sewer.	Medium	Protect
PS-G-E25	Gas	"DN110 PE 7kPa low pressure"	Jemena	Proposed electrical will cross existing gas with approx. 700mm cover.	Medium	Coordinate
PS-E-C15	Electrical	"1 x 1 DN50 PVC 3 x 2 DN140 Fibro Conduit (Asbestos)"	Endeavour Energy	Proposed communications will cross existing electrical with approx. 1.1m cover.	High	Protect
PS-E-E33	Electrical	"1 x 1 DN50 PVC 3 x 2 DN140 Fibro Conduit (Asbestos)"	Endeavour Energy	Proposed electrical will cross existing electrical with approx. 1.1m cover.	High	Protect
PS-E-C17	Electrical	Unknown	Council (TBC)	New communications pit proposed. Existing electrical conduit to be demolished.	Low	Remove
PS-E-E35	Electrical	Unknown	Council (TBC)	New electrical pit proposed. Existing electrical conduit to be demolished.	Low	Remove
PS-C-E34	Communications	TBC	TBC	New electrical pit proposed. Existing communications conduit to be demolished.	Low	Remove
PS-C-C16	Communications	TBC	TBC	New communications pit proposed. Existing communications conduit to be demolished.	Low	Remove
PS-W-C09	Potable water	DN150 CICL	Sydney Water	Proposed communications will cross existing potable water with approx. 800mm cover.	Medium	Protect
PS-W-E27	Potable water	DN150 CICL	Sydney Water	Proposed electrical will cross existing potable water with approx. 800mm cover.	Medium	Protect
PS-C-E26	Communications	TBC	TBC	Proposed electrical will cross existing communications with approx. 650mm cover.	Low	Coordinate
PS-W-R09	Potable water	Property connection	Sydney Water	Existing conduits to be removed crosses existing potable water with approx. 700mm cover.	Low	Protect
PS-W-R08	Potable water	Property connection	Sydney Water	Existing communications pit to be removed crosses existing potable water with approx. 700mm cover.	Low	Protect
PS-E-R07	Electrical	"1 x 1 DN50 PVC 3 x 2 DN140 Fibro Conduit (Asbestos)"	Endeavour Energy	Existing conduits to be removed cross existing electrical with approx. 1.1m cover.	High	Protect
PS-W-D22	Potable water	Property connection	Sydney Water	Proposed drainage pit will clash with existing potable water with approx. 500mm cover.	Low	Protect
PS-W-E31	Potable water	Property connection	Sydney Water	Proposed electrical will cross existing potable water with approx. 400mm cover.	Low	Protect
PS-C-C10	Communications	TBC	TBC	Proposed communications will cross existing communications with approx. 650mm cover.	Low	Coordinate
PS-C-E28	Communications	TBC	TBC	Proposed electrical will cross existing communications with approx. 650mm cover.	Low	Coordinate
PS-C-C11	Communications	TBC	TBC	Proposed communications will cross existing communications with approx. 650mm cover.	Low	Coordinate
PS-G-E29	Gas	Property connection	Jemena	Proposed electrical will cross existing gas with approx. 500mm cover.	Low	Coordinate
PS-G-E30	Gas	Property connection	Jemena	Proposed electrical will cross existing gas with approx. 500mm cover.	Low	Coordinate
PS-W-C13	Potable water	Property connection	Sydney Water	Proposed communications will cross existing potable water with approx. 400mm cover.	Low	Protect
PS-W-R12	Potable water	Property connection	Sydney Water	Existing conduits to be removed cross existing potable water with approx. 400mm cover.	Low	Protect
PS-E-C12	Electrical	Unknown	Council (TBC)	Proposed communications will cross existing electrical with approx. 600mm cover.	Low	Coordinate
PS-C-R11	Communications	TBC	TBC	Existing conduits to be removed cross existing communications with approx. 560mm cover.	Low	Protect
PS-E-R10	Electrical	"1 x 1 DN50 PVC 3 x 2 DN140 Fibro Conduit (Asbestos)"	Endeavour Energy	Existing conduits to be removed cross existing electrical with approx. 640mm cover.	High	Protect
PS-W-D13	Potable water	DN150 CICL	Sydney Water	Proposed drainage pit clashes with existing potable water with approx. 600mm cover.	High	Protect
PS-D-D12	Drainage	2 x DN300	Council	Proposed drainage pit will clash with existing drainage pipes.	Low	Adjust
PS-D-D23	Drainage	Kerb inlet pit	Council	Existing drainage pit to be replaced.	Low	Remove
PS-W-D14	Potable water	DN150 CICL	Sydney Water	Proposed drainage pit will be adjacent to existing potable water with approx. 900mm cover.	Medium	Protect
PS-D-D15	Drainage	Pit with concrete infill cover	Council	Existing drainage pit to be replaced.	Low	Remove
PS-G-R13	Gas	"DN110 PE 7kPa low pressure"	Jemena	Existing conduits to be removed cross existing gas.	Low	Protect

NOTE:


- THE CONTRACTOR SHALL LOCATE AND LEVEL ALL EXISTING SERVICES PRIOR TO COMMENCING CONSTRUCTION AND SHALL MAKE ALL NECESSARY ARRANGEMENTS WITH THE RELEVANT AUTHORITY TO RELOCATE, ADJUST OR PROTECT AS REQUIRED.
- ALL COSTS TO BE BORNE BY THE APPLICANT, ADDITIONALLY WHERE DIRECTED BY AUTHORITY, CCTV (OR OTHER INVESTIGATIVE ACTIONS) SHOULD BE COMPLETED TO ASSESS CURRENT CONDITION OF ASSETS AND ALLOW AUTHORITY AN OPPORTUNITY TO INCLUDE REPLACEMENT AS A PART OF SCOPE.
- UTILITIES REGISTER IS INDICATIVE AND BASED ON PLAN VIEW CLASHES BETWEEN EXISTING AND PROPOSED UTILITIES. CLASHES BETWEEN DESIGN LEVEL CHANGES, PAVEMENT, KERB/GUTTER, STRUCTURES, LANDSCAPE ETC. HAVE NOT BEEN NOTED. CONTRACTOR TO SPATIALLY PROOF ALL EXISTING AND PROPOSED UTILITIES IN ACCORDANCE WITH RELEVANT AUTHORITIES' GUIDELINES. APPROVAL FROM RELEVANT AUTHORITIES MUST BE OBTAINED PRIOR TO CONSTRUCTION.
- REFER TO GENERAL NOTES & EXISTING UNDERGROUND SERVICES NOTES ON DRAWING CL3-AAP-DD-PS-DRG-CI-0021

																				<div>Surveyor</div> <div><div></div><div></div></div>										<div>Client</div> <div><div>CITY OF PARRAMATTA</div></div>										<div>Status</div> <div>PRELIMINARY NOT TO BE USED FOR CONSTRUCTION</div> <div>© Copyright reserved</div> <div><div>Original Issue Signatures</div><div><div>Drawn</div><div>R. SANTOS</div><div>Original Size</div><div>A1</div><div>Designed</div><div>C. NUGPO</div><div>Height Datum</div><div>AHD</div><div>Project Manager</div><div>S. GEERDINK</div><div>Grid</div><div>MGA/20-56</div><div>Verified</div><div>G. DUNSTAN</div></div></div>										<div>Project</div> <div>PARRAMATTA CIVIC LINK PHILLIP STREET WORKS</div> <div><div>Title</div><div>UTILITIES REGISTER</div></div>										<div></div> <div>Arcadis Australia Pacific Pty Limited Level 16, 580 George Street SYDNEY NSW 2000 ABN 76 104 485 289 Tel No: +61 2 8907 9000 www.arcadis.com/au</div> <div><div>Project Number</div><div>30286862</div><div>Issue</div><div>01</div></div>																																																																																																																																																																																																																																																																																																																																																																																																																																																																																																																																																																																																																																																																																																																																																																																																																																																																																																																																																																																																																																																																																																																																																																																																																																																																																																																																																																																																																																																																																																																																																																																																																																																																																																																																																																																																																																																																																																																																																																																																																																																																																																																																																																																																																																																																																																																																																																																																																																																																																																																																																																																																																																																																																																																																																																																																																																																																																																																																																																																																																																																																																																																																																																																																																																																																																																																																																																																																																																																																																																																																																																																																																																																																																																																																																																																																																																																																																																																																																																																																																																																																																																																																																																																																																																																																																																																																																																																																																																																																																																																																																																																																																																																																																																																																																																																																																																																																																																																																																																																																																																																																																																																																						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

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
03	ISSUED FOR INFORMATION - 100% DETAILED DESIGN	RS	SA	GD	03.10.2025
02	ISSUED FOR INFORMATION - 95% DETAILED DESIGN	RS	SA	GD	10.09.2025
01	ISSUED FOR INFORMATION - 80% DETAILED DESIGN	RS	CR	MK	18.07.2025
Issue	Description	DR	CH	VE	Date

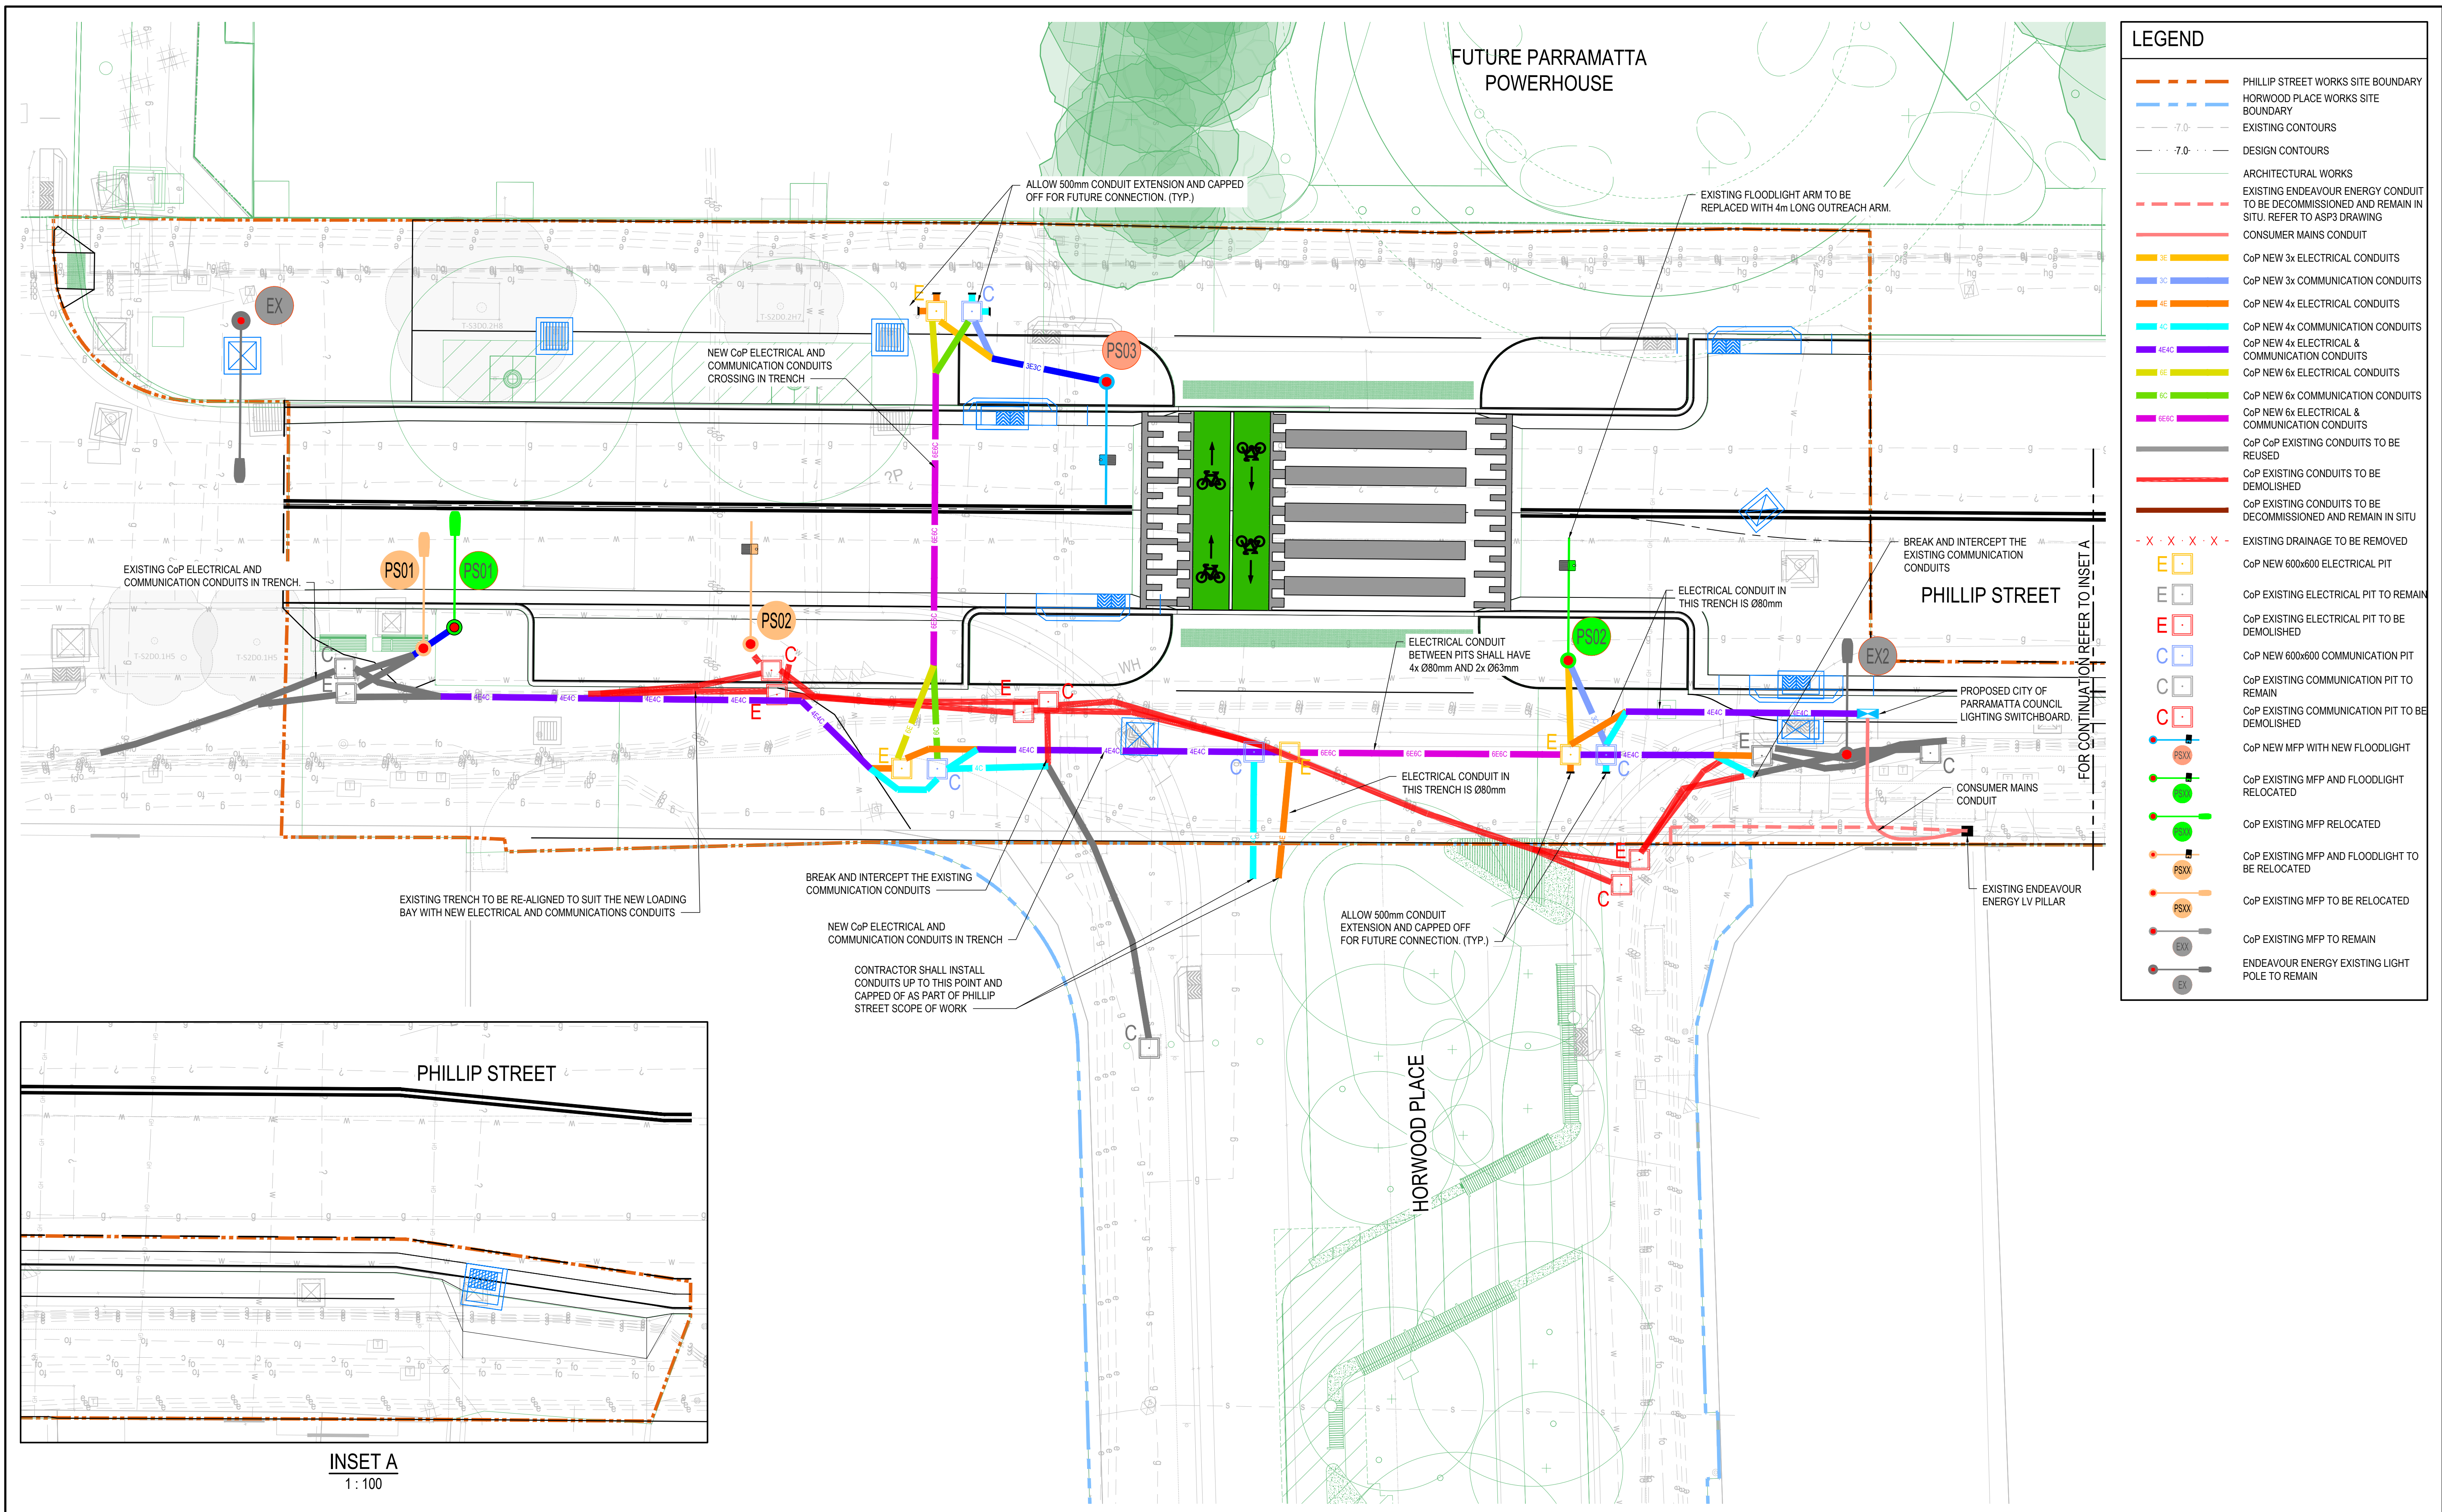

Surveyor

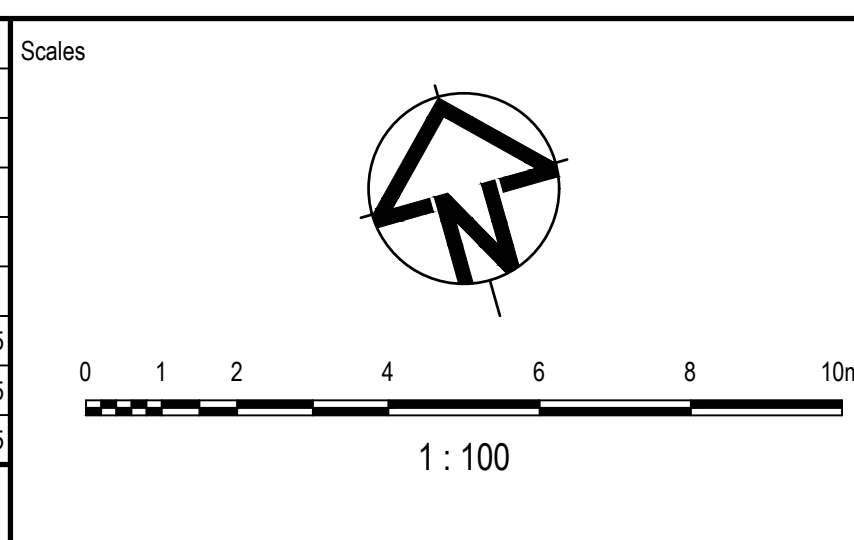
Architect





Status	<h1 style="text-align: center;">PRELIMINARY</h1> <h2 style="text-align: center;">NOT TO BE USED FOR CONSTRUCTION</h2>		
© Copyright reserved			
Original Issue Signatures			
Drawn	R. SANTOS	Original Size	A1
Designed	H. THIAUW	Height Datum	AHD
Project Manager	S. GEERDINK	Grid	MGA/20-56
Verified	S. ASHMAN		

Project	PARRAMATTA CIVIC LINK PHILLIP STREET WORKS
Title	LIGHTING PLAN




ARCADIS

Arcadis Australia Pacific Pty Limited
 Level 16, 580 George Street
 SYDNEY NSW 2000
 ABN 76 104 485 289
 Tel No: +61 2 8907 9000
 www.arcadis.com/au

Project Number	30286862
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Drawing No.

CL3-AAP-DD-PS-DRG-CI-0701	Issue	03
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TYPICAL ELECTRICAL & COMMUNICATION CONDUIT TRENCH DETAILS
(UNDER FOOTPATH PAVEMENT, IN VERGE OR GENERAL FILL)

1 : 5

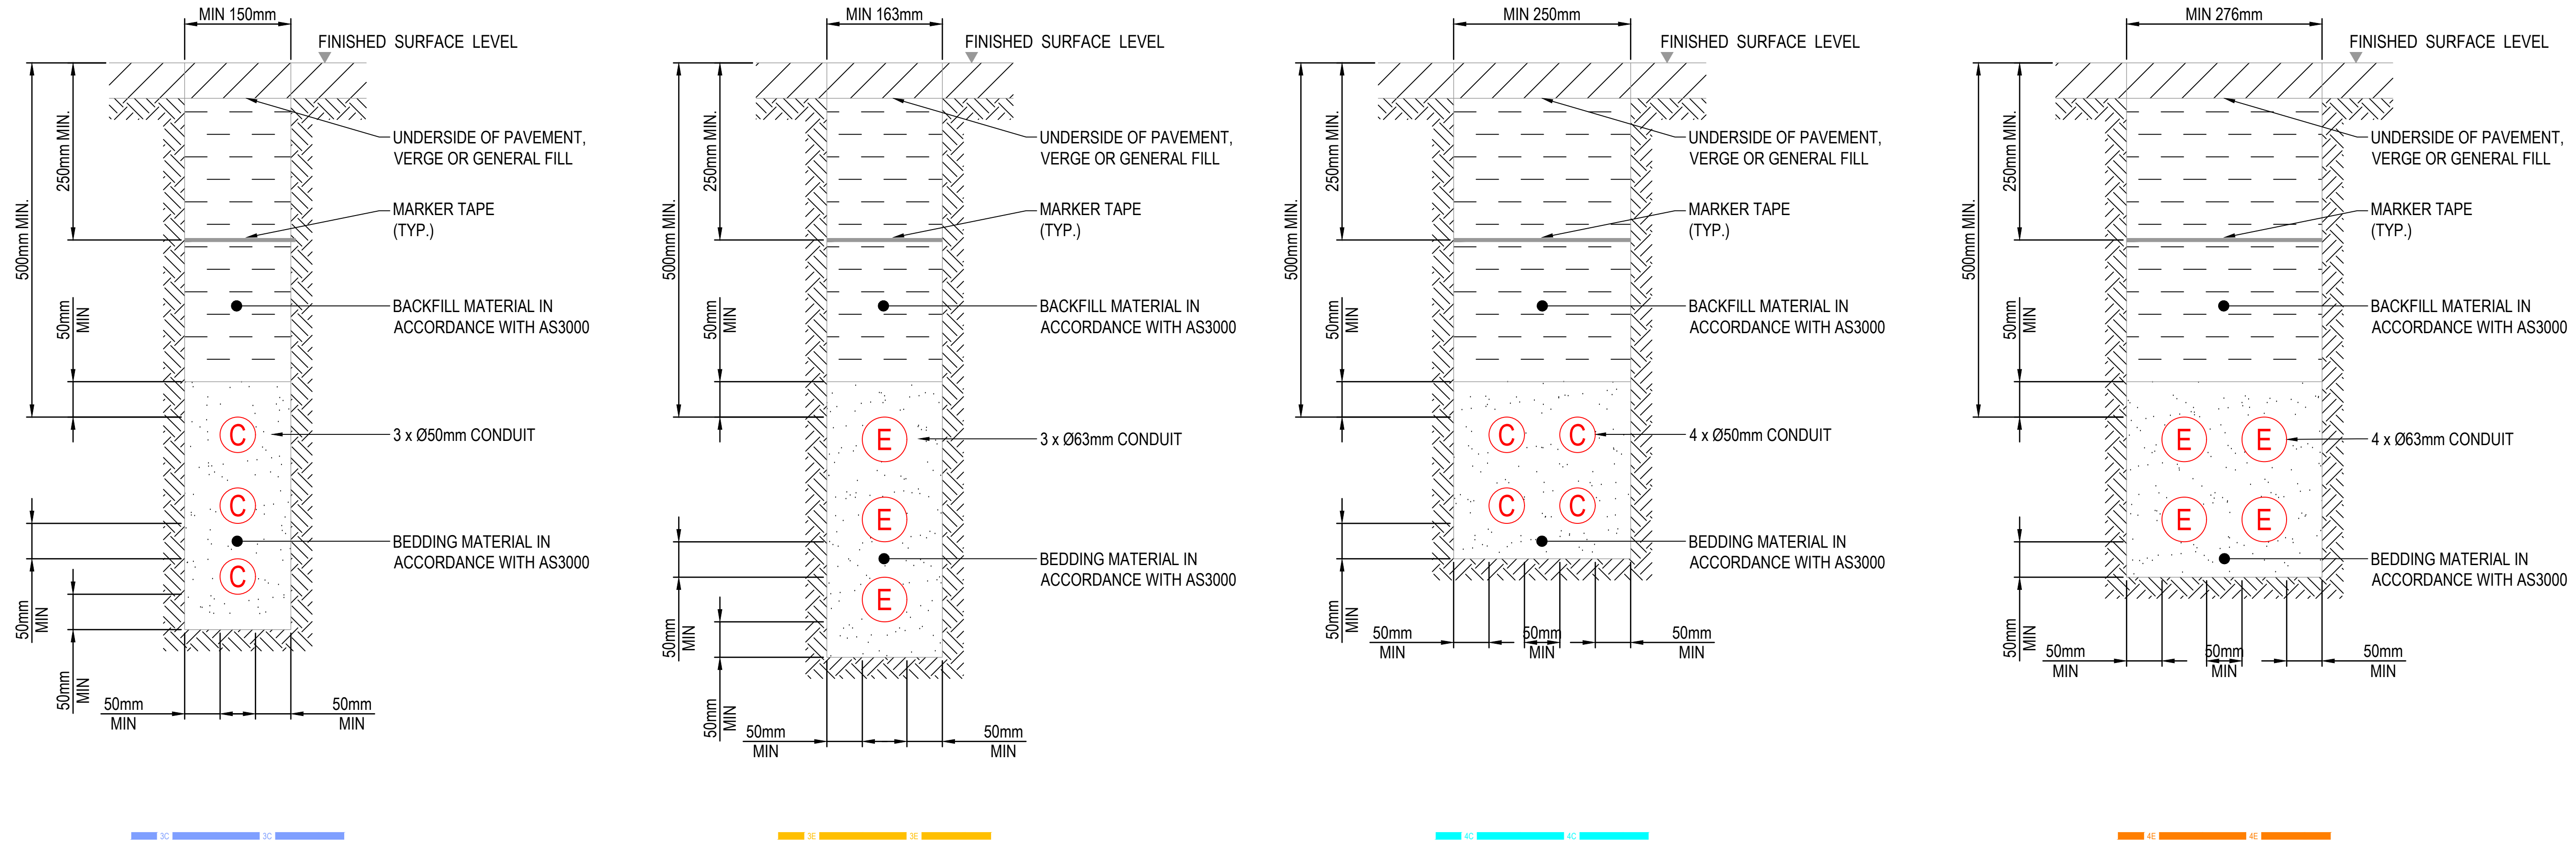
LEGEND:

- E** ELECTRICAL CONDUIT
63mm DIAMETER
- C** COMMUNICATION CONDUIT
50mm DIAMETER


NOTES:

- CONTRACTOR TO CHECK THE EXISTING CONDUITS RUN PRIOR COMMENCING WORK.
- THE ELECTRICAL CONTRACTOR SHALL UNDERTAKE A "BEFORE YOU DIG AUSTRALIA" SEARCH FOR EXISTING IN-GROUND SERVICES PRIOR TO EXCAVATION ON SITE. ANY DAMAGE TO EXISTING IN-GROUND SERVICES SHALL BE THE CONTRACTOR'S RESPONSIBILITY.
- ALL WORKS TO CONFORM WITH THE LATEST CITY OF PARRAMATTA STREET LIGHTING DESIGN GUIDE AND PUBLIC DOMAIN GUIDELINES.
- THE CONDUIT TYPE SHALL BE HDuPVC.
- THE TRENCH WIDTH AND CLEARANCE BETWEEN CONDUITS SHALL BE ADJUSTED ACCORDINGLY FOR OTHER CONDUIT SIZE. REFER TO THE PLAN FOR OTHER SIZE OF ELECTRICAL CONDUIT


					Scales					Surveyor					Client					Status					Project					ARCADIS														
										 					 CITY OF PARRAMATTA					PRELIMINARY NOT TO BE USED FOR CONSTRUCTION					PARRAMATTA CIVIC LINK PHILLIP STREET WORKS					Arcadis Australia Pacific Pty Limited Level 16, 580 George Street SYDNEY NSW 2000 ABN 76 104 485 289														
																				© Copyright reserved										Tel No: +61 2 8907 9000 www.arcadis.com/au														
										Architect										Original Issue Signatures					Title					Project Number														
										OCULUS										Drawn					R. SANTOS					Original Size					A1					Issue				
																				Designed					H.THIAUW					Height Datum					AHD					30286862				
																				Project Manager					S. GEERDINK					Grid					MGA/20-56					CL3-AAP-DD-PS-DRG-CI-0711				
																				Verified					S. ASHMAN										03									

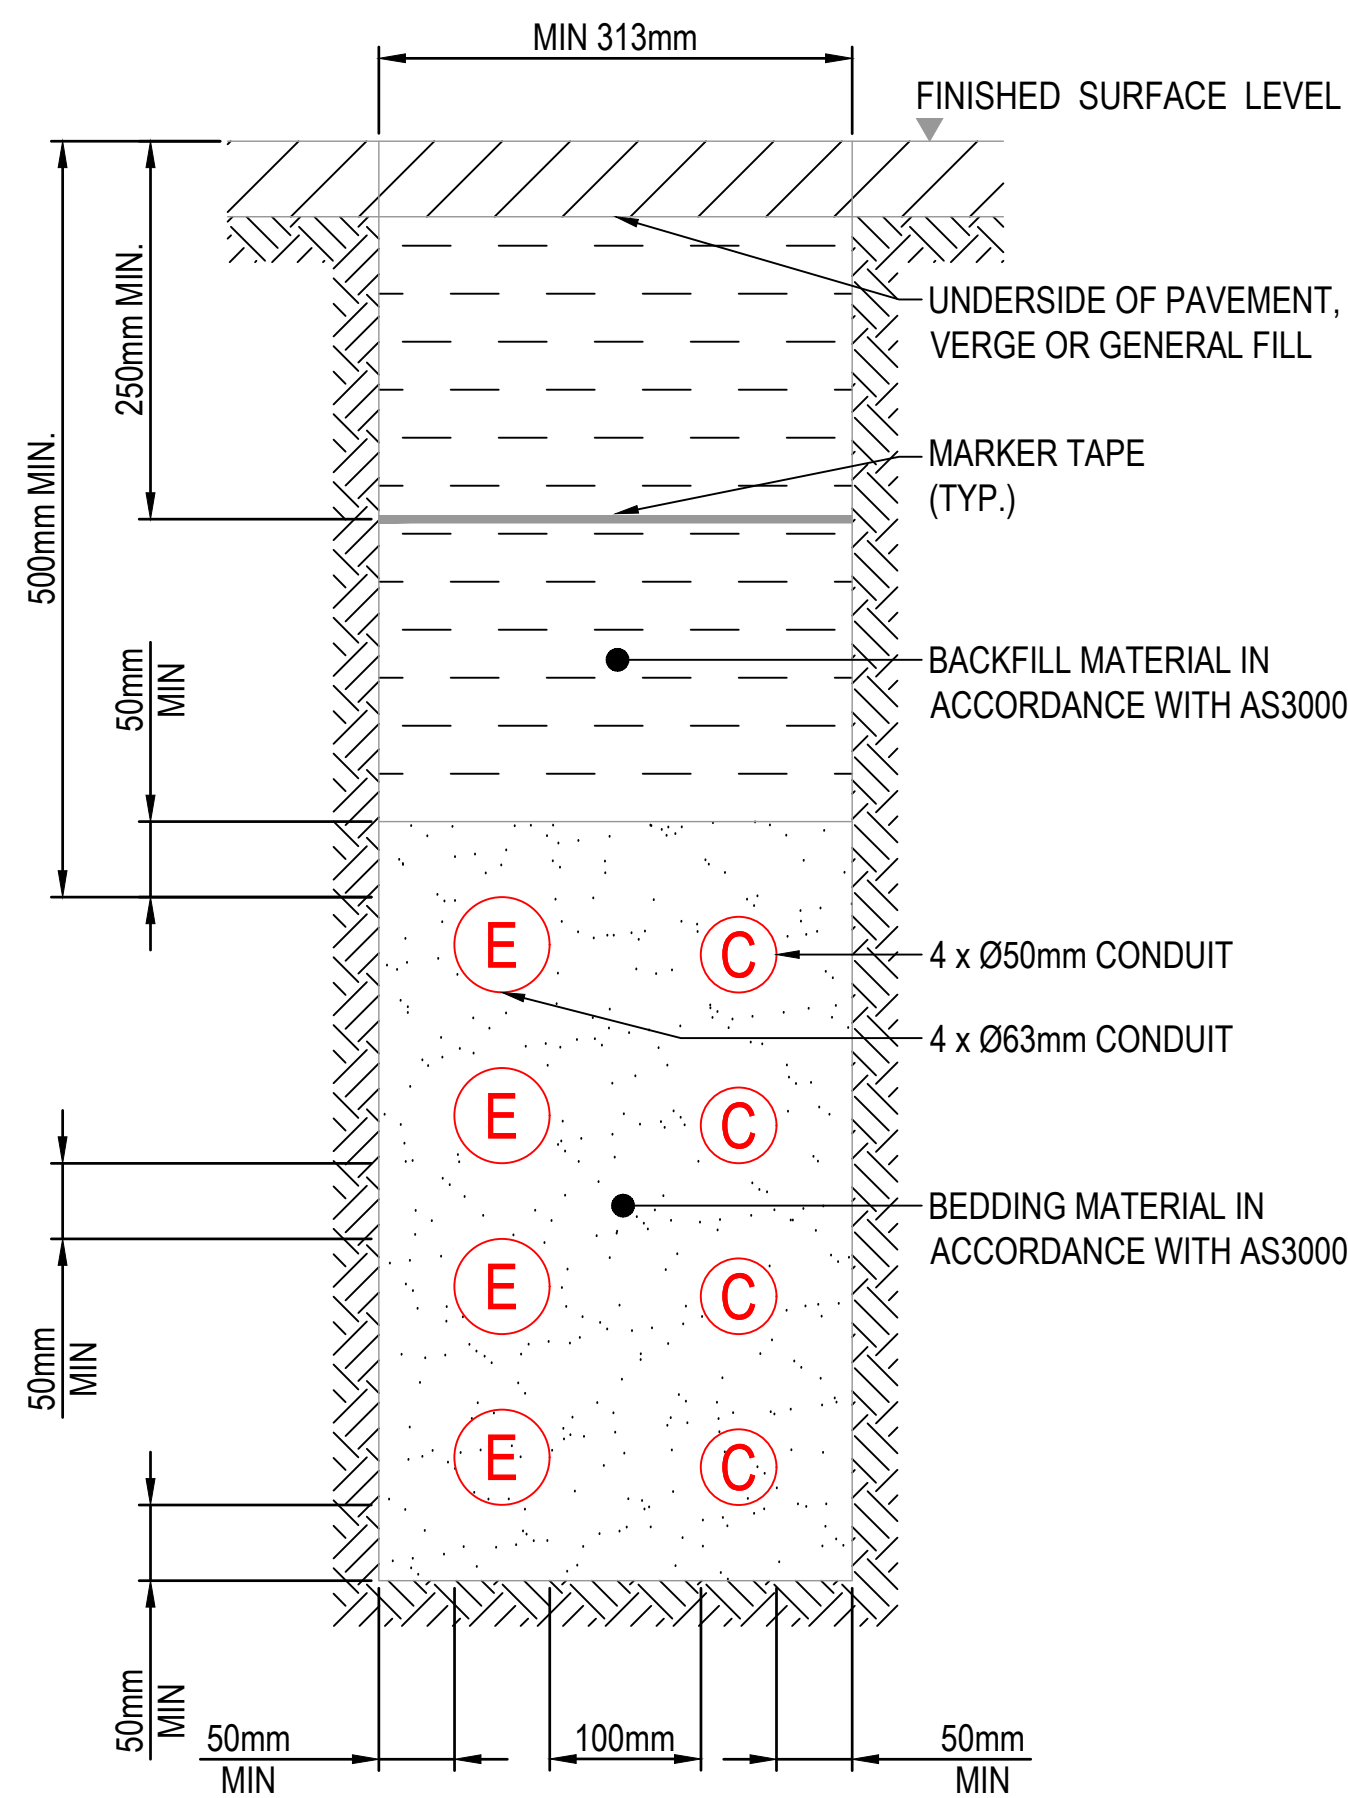


4E4C 4E4C

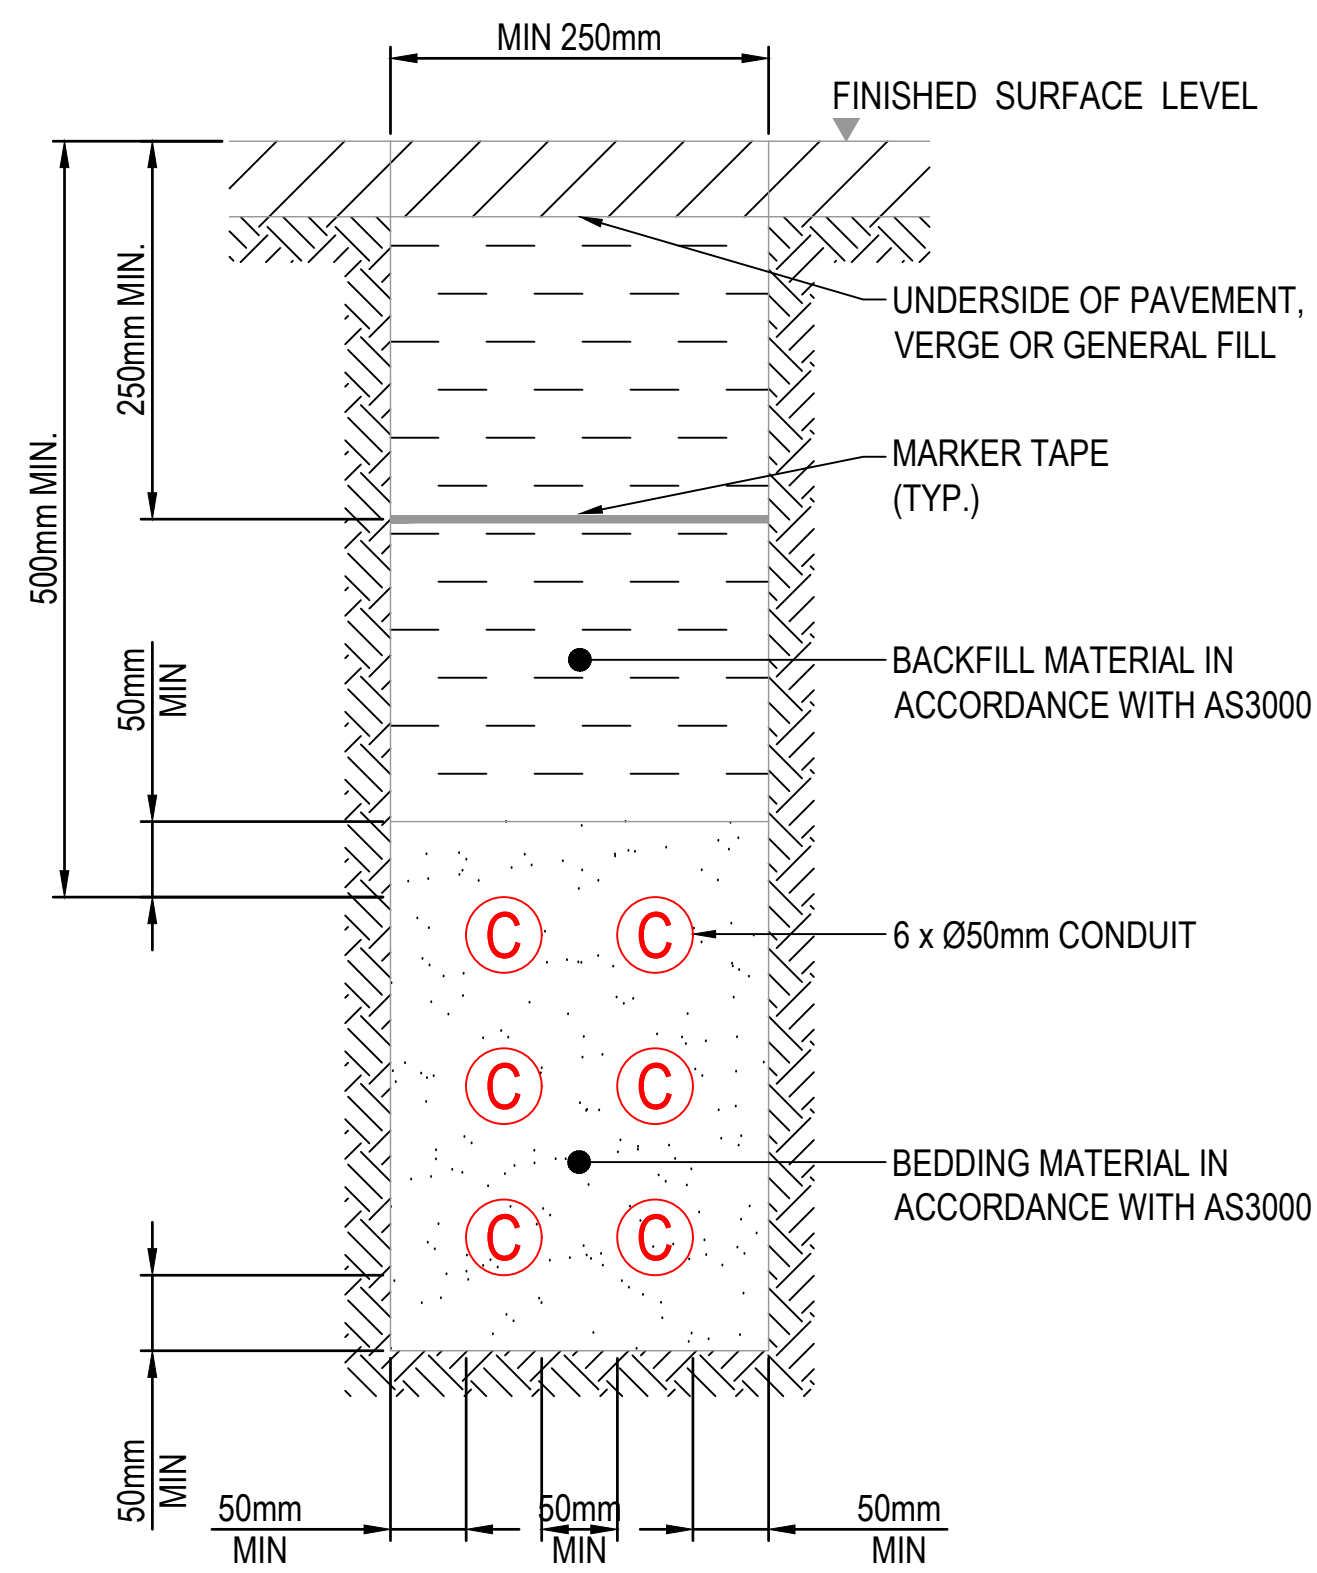

6C 6C

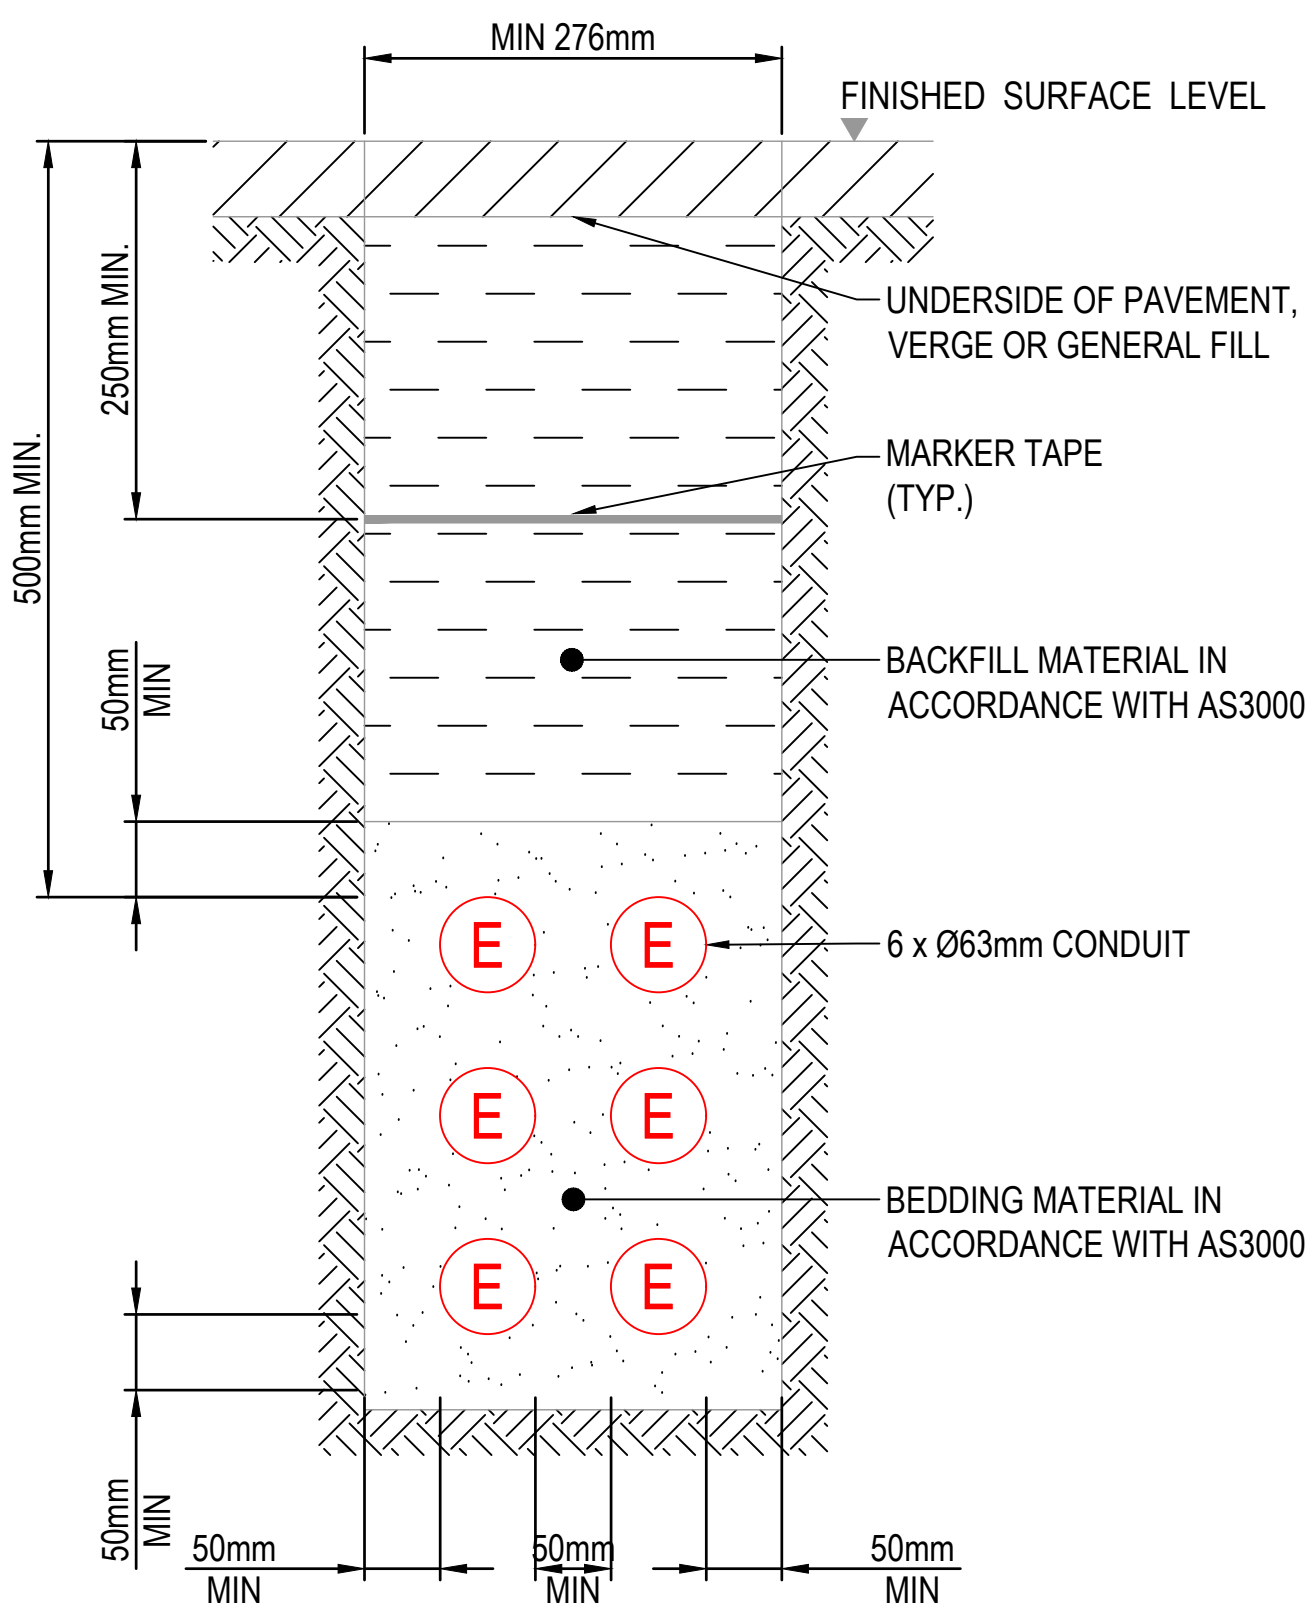

6E 6E

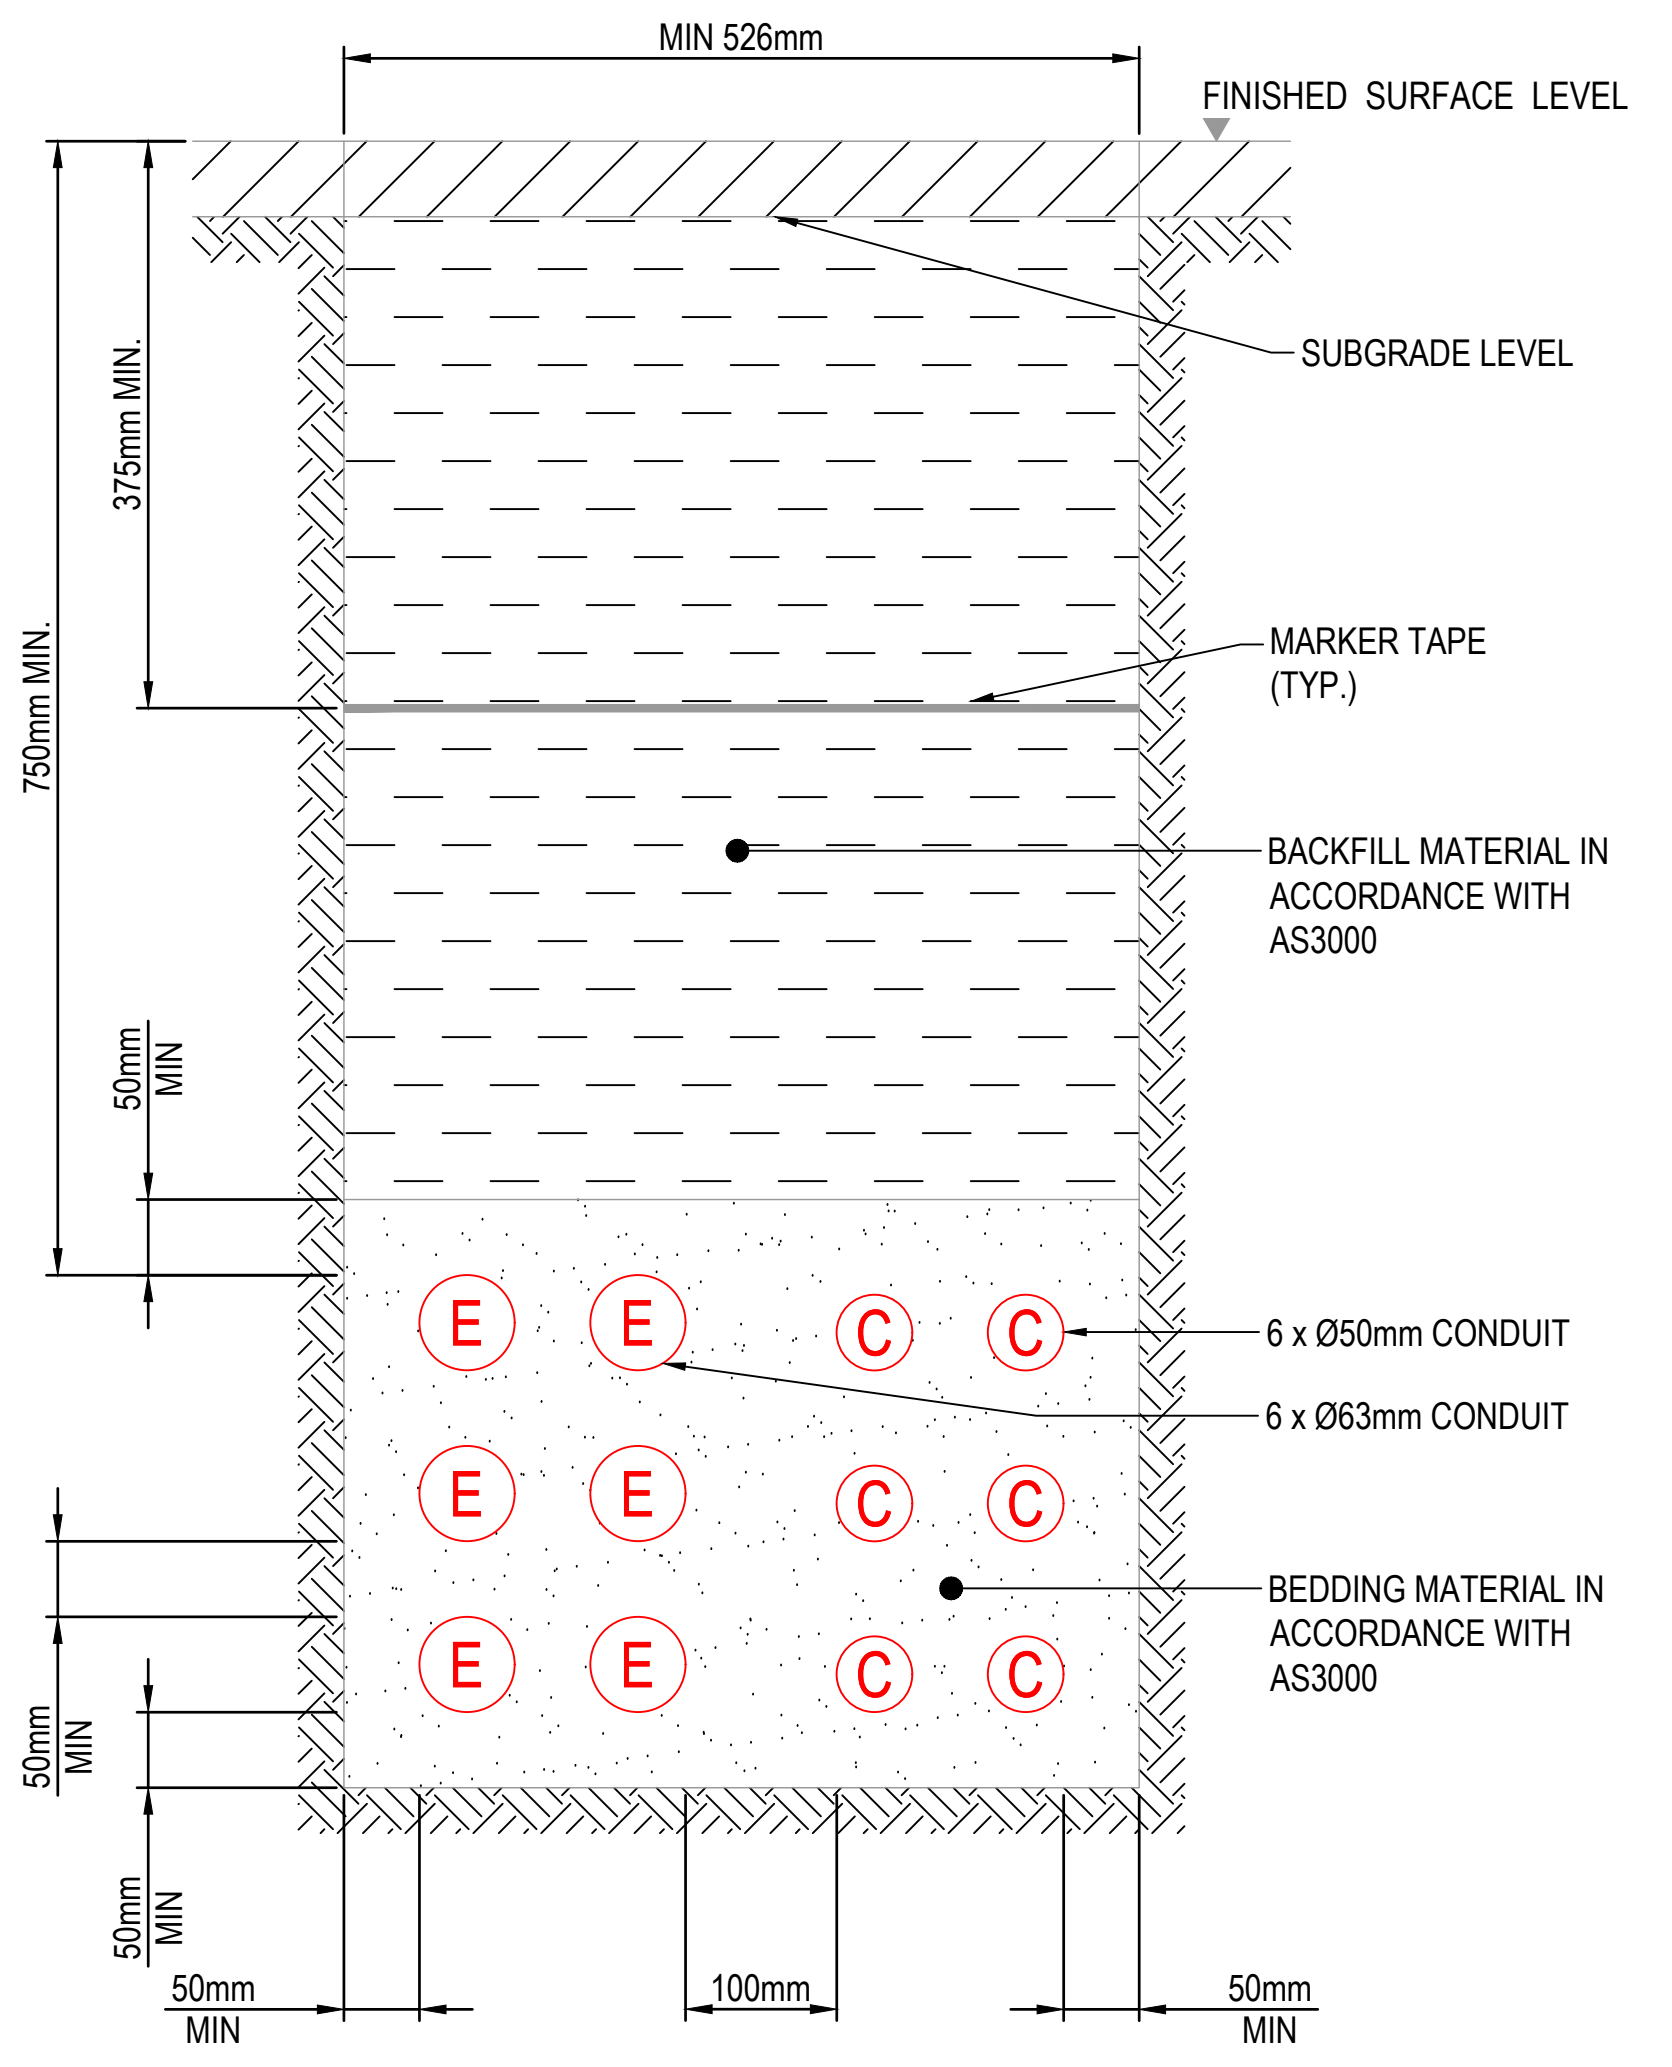

6E6C 6E6C

TYPICAL ELECTRICAL & COMMUNICATION CONDUIT TRENCH DETAILS
(UNDER FOOTPATH PAVEMENT, IN VERGE OR GENERAL FILL)
1 : 5

TYPICAL ELECTRICAL & COMMUNICATION CONDUIT TRENCH DETAILS
(CROSSING OF ROAD)
1 : 5


LEGEND:

- (E) ELECTRICAL CONDUIT
63mm DIAMETER
- (C) COMMUNICATION CONDUIT
50mm DIAMETER

NOTES:

- CONTRACTOR TO CHECK THE EXISTING CONDUITS RUN PRIOR COMMENCING WORK.
- THE ELECTRICAL CONTRACTOR SHALL UNDERTAKE A "BEFORE YOU DIG AUSTRALIA" SEARCH FOR EXISTING IN-GROUND SERVICES PRIOR TO EXCAVATION ON SITE. ANY DAMAGE TO EXISTING IN-GROUND SERVICES SHALL BE THE CONTRACTOR'S RESPONSIBILITY.
- ALL WORKS TO CONFORM WITH THE LATEST CITY OF PARRAMATTA STREET LIGHTING DESIGN GUIDE AND PUBLIC DOMAIN GUIDELINES.
- THE CONDUIT TYPE SHALL BE HDuPVC.
- THE TRENCH WIDTH AND CLEARANCE BETWEEN CONDUITS SHALL BE ADJUSTED ACCORDINGLY FOR OTHER CONDUIT SIZE. REFER TO THE PLAN FOR OTHER SIZE OF ELECTRICAL CONDUIT.

03	ISSUED FOR INFORMATION - 100% DETAILED DESIGN	RS	SA	GD	03.10.2025
02	ISSUED FOR INFORMATION - 95% DETAILED DESIGN	RS	SA	GD	10.09.2025
01	ISSUED FOR INFORMATION - 80% DETAILED DESIGN	RS	CR	MK	18.07.2025
Issue	Description	DR	CH	VE	Date

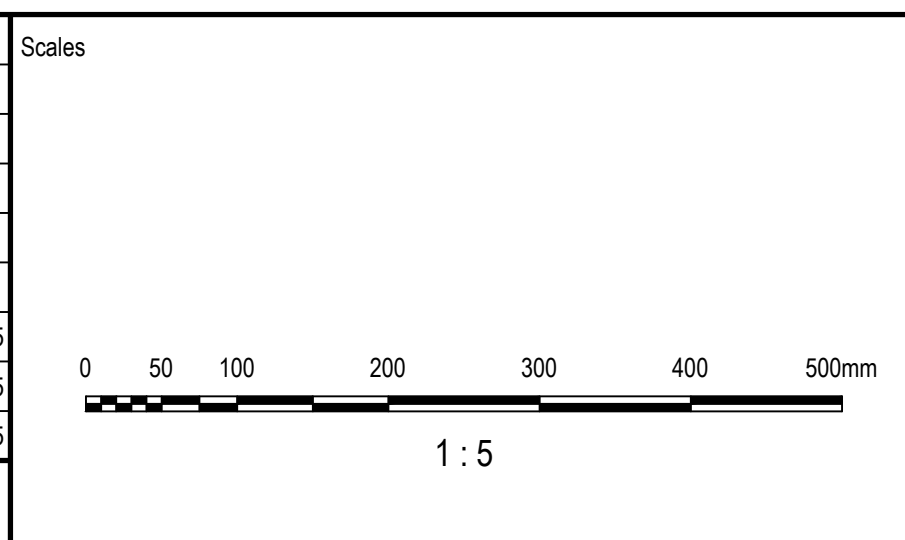

Surveyor

Architect

Client

Status	PRELIMINARY NOT TO BE USED FOR CONSTRUCTION		
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Original Issue Signatures			
Drawn	R. SANTOS	Original Size	A1
Designed	H.THIAUW	Height Datum	AHD
Project Manager	S. GEERDINK	Grid	MGA/20-56
Verified	S. ASHMAN		

Project

PARRAMATTA CIVIC LINK
PHILLIP STREET WORKS


Title

LIGHTING DETAILS
SHEET 2


Arcadis Australia Pacific Pty Limited
Level 16, 580 George Street
SYDNEY NSW 2000
ABN 76 104 485 289
Tel No: +61 2 8907 9000
www.arcadis.com/au

Project Number	30286862	Issue	03
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Drawing No. CL3-AAP-DD-PS-DRG-CI-0712

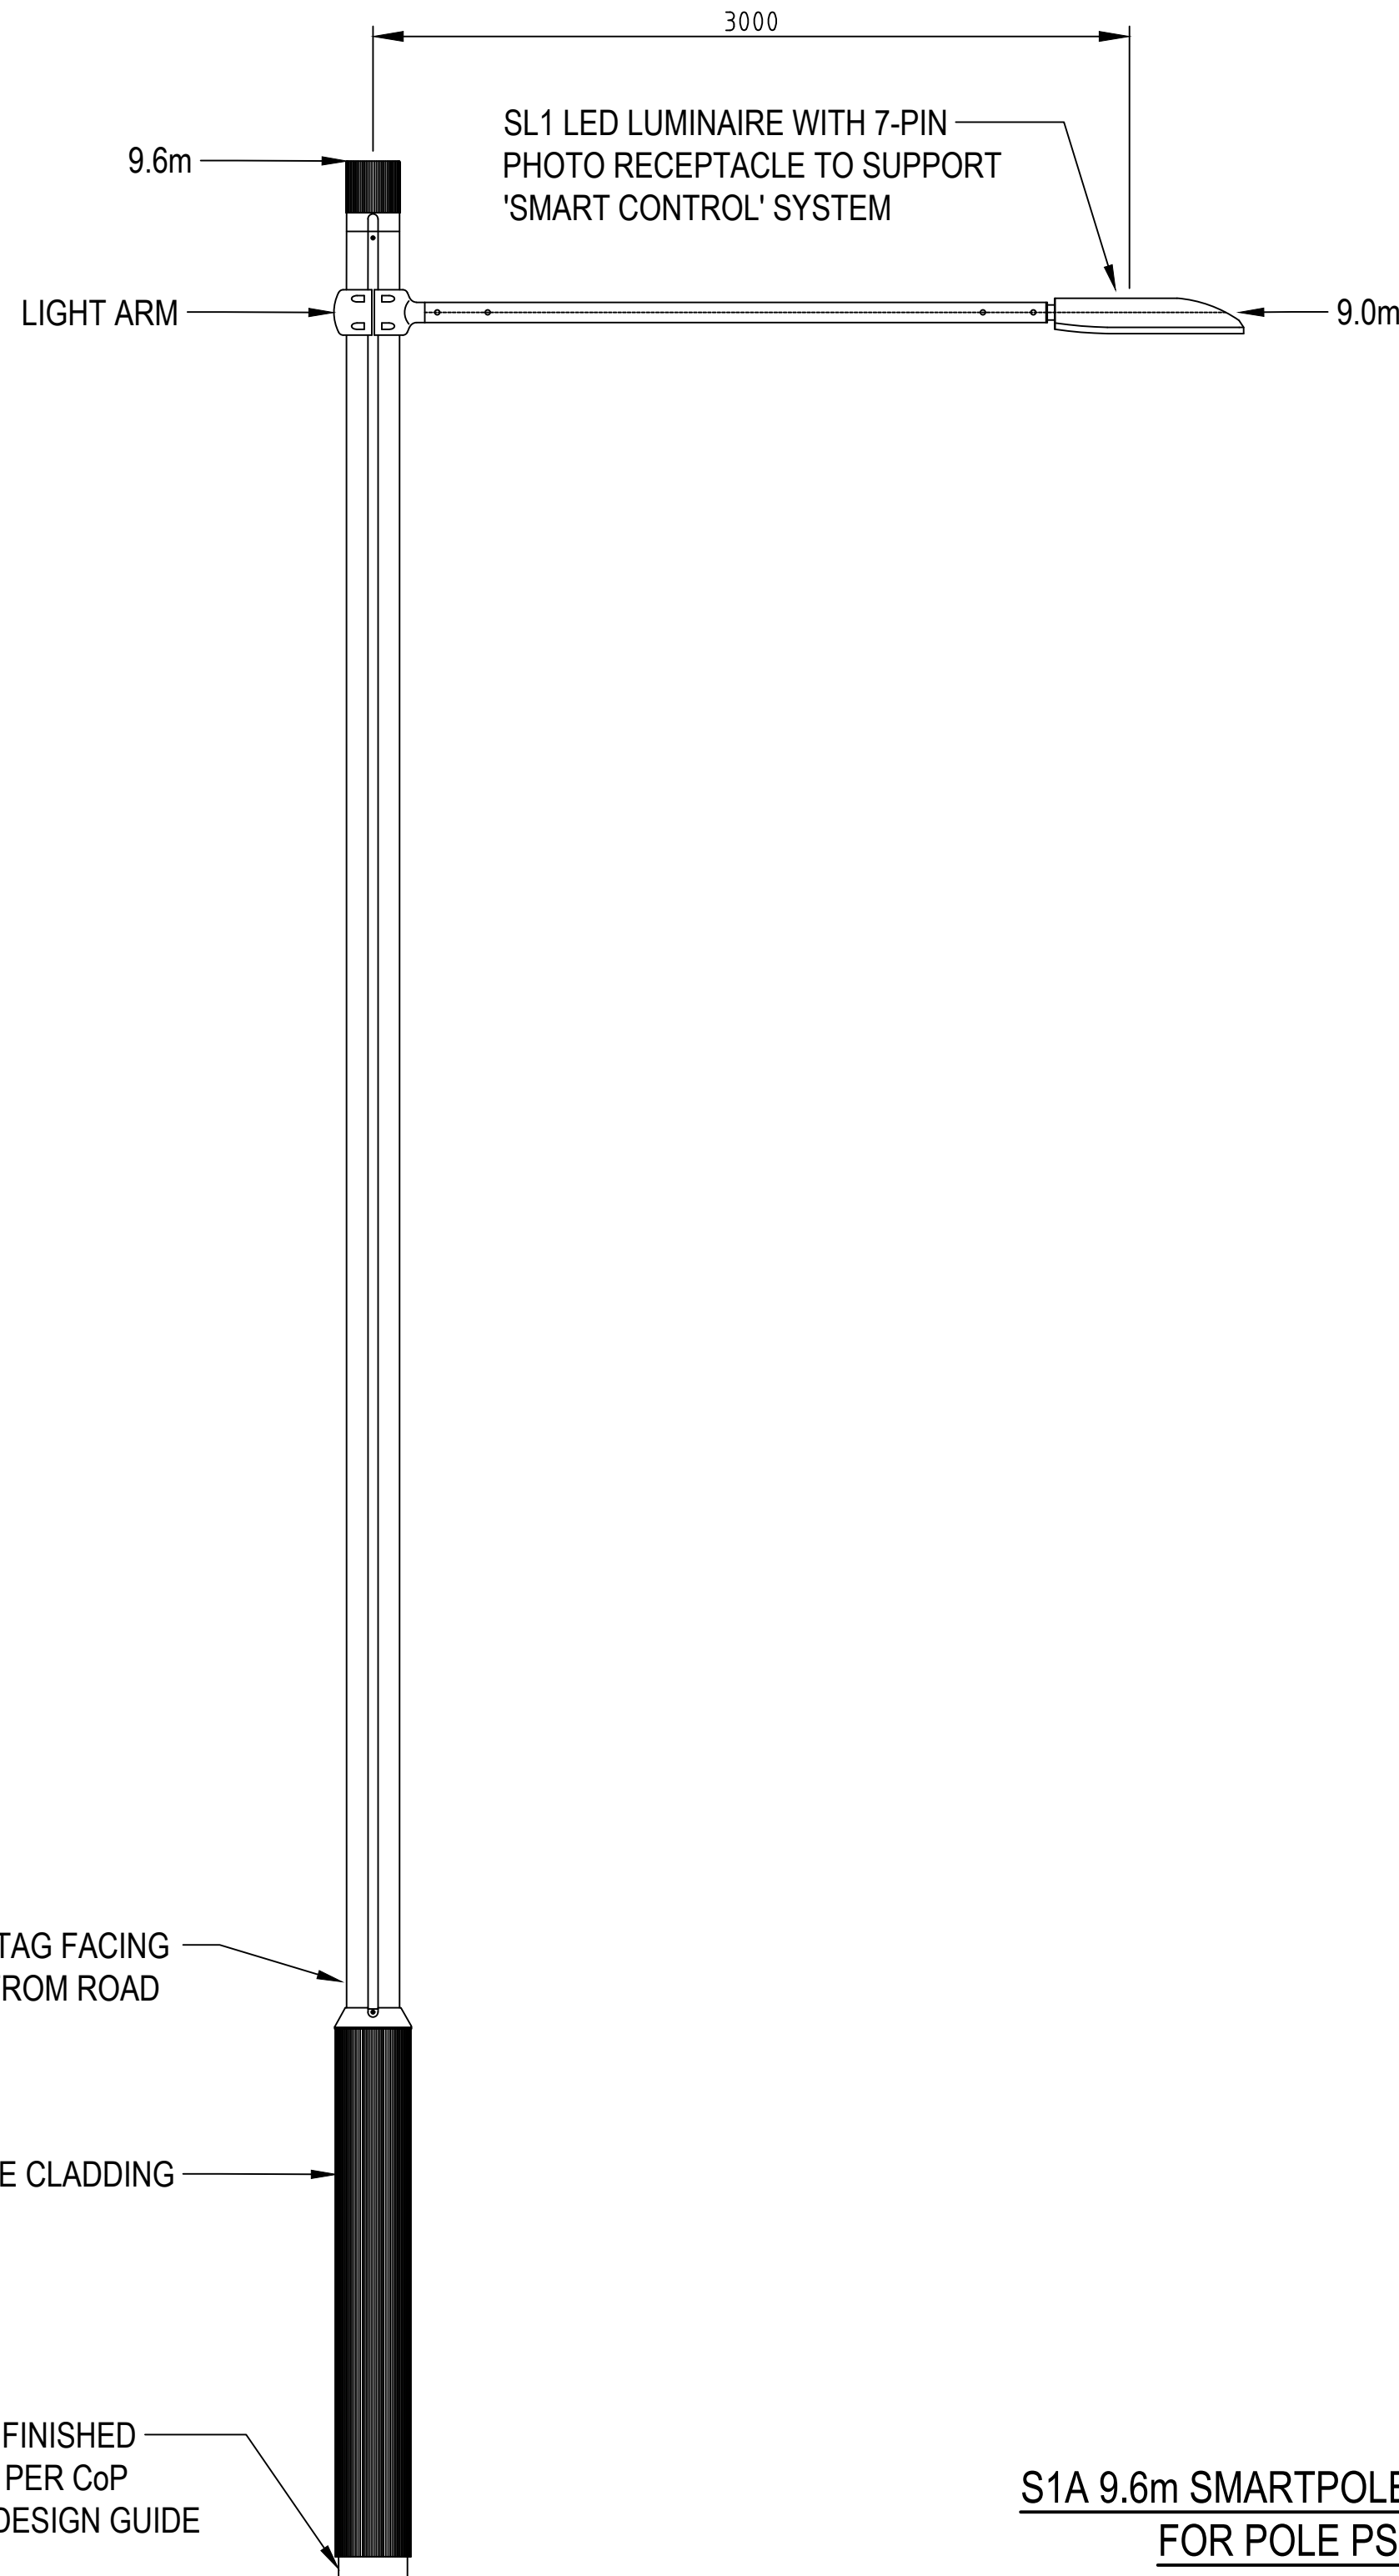

S1A 9.6m SMARTPOLE DETAILS
FOR POLE PS01
(HUB GROUP)
SCALE NTS



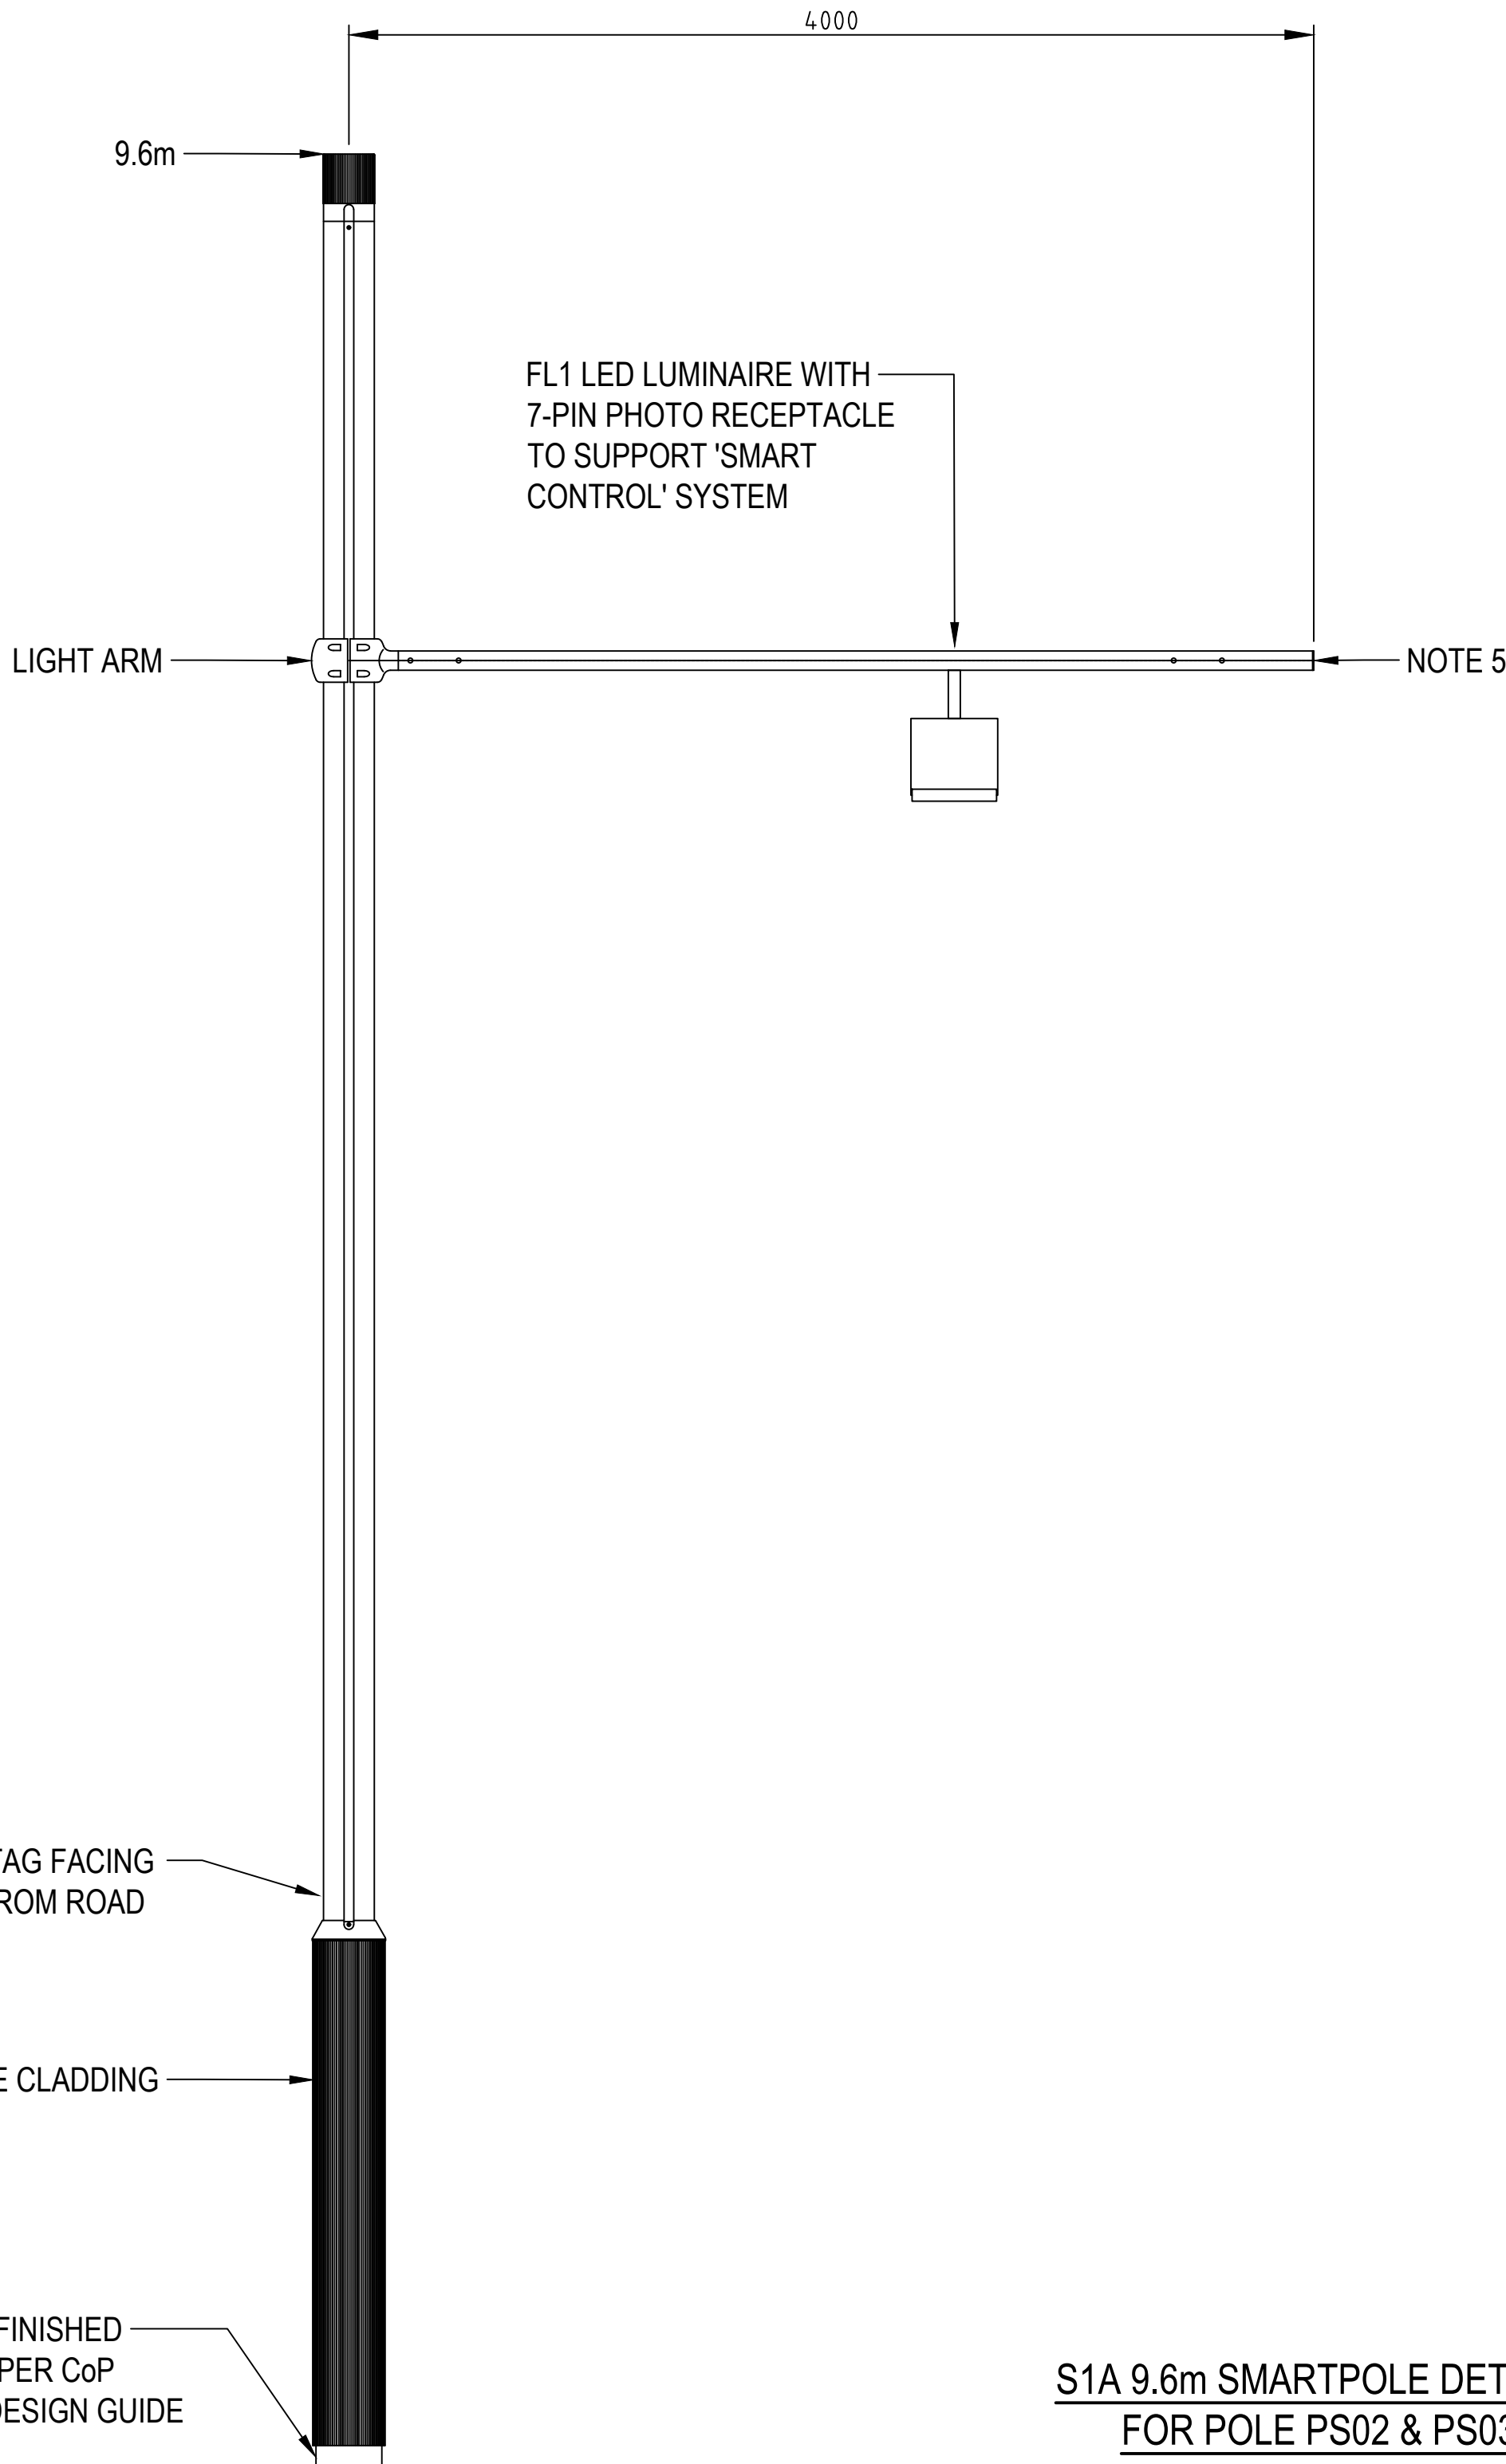


S1A 9.6m SMARTPOLE DETAILS
FOR POLE PS02 & PS03
(HUB GROUP)
SCALE NTS

- NOTES:
- SMARTPOLE DETAILS IS EXTRACTED FROM HUB GROUP DRAWINGS.
 - ALL WORKS TO CONFORM WITH THE LATEST CITY OF PARRAMATTA STREET LIGHTING DESIGN GUIDE AND PUBLIC DOMAIN GUIDELINES.
 - EVERY POLE SHALL BE SUPPLIED WITH A 10A SINGLE PHASE RCBO, INSTALLED INSIDE THE POLE BASE, TO PROTECT THE LANTERN.
 - MOUNTING PLATE FOR RECESSED WATERPROOF GPO AT SPECIFIC HEIGHT SHALL BE PROVIDED AS PER CITY OF PARRAMATTA PUBLIC DOMAIN GUIDELINES, SECTION 2.2.
 - REFER TO THE POLE SCHEDULE FOR THE REQUIRED ACCESSORIES AND EQUIPMENT FOR EACH POLE.
 - SMARTPOLE PS01 AND PS02 ARE THE EXISTING TO BE RELOCATED TO A NEW POSITION. REFER TO THE LIGHTING LAYOUT AND SCHEDULES.
 - SMARTPOLE PS01 AND PS02 HAVE TO BE ASSESSED BY A QUALIFIED STRUCTURAL ENGINEER FOR ITS LONGEVITY AND SUITABILITY TO BE RE-USED OTHERWISE NEW SMARTPOLE SHOULD BE INSTALLED.
 - SMARTPOLE PS01 AND PS02 SHOULD BE EQUIPPED WITH NEW BASE PLATE AND RAG BOLT ASSEMBLIES.
 - SMARTPOLE PS02 SHOULD BE EQUIPPED WITH NEW 4m OUTREACH ARM. THE OUTREACH ARM SHALL BE MOUNTED ACCORDINGLY TO MAINTAIN THE FLOODLIGHT FL1 AT 7.0m HIGH FROM THE GROUND LEVEL.
 - REFER TO THE POLE SCHEDULE FOR THE EXACT POLE POSITION/COORDINATE.
 - THE EXISTING COMMUNICATION CABLES HAVE TO BE RE-ROUTED THROUGH NEW CONDUITS AND PITS THEN RECONNECTED TO THE EXISTING EQUIPMENTS (CCTV CAMERAS AND WI-FI).
 - THE EXISTING COMMUNICATION CABLES HAVE TO BE REPLACED WITH NEW IF THE LENGTH IS INSUFFICIENT TO REACH THE EQUIPMENT AFTER RE-ROUTING. APPROVAL FROM CITY OF PARRAMATTA ASSET TEAM IS REQUIRED IF CONTRACTOR PROPOSES TO EXTEND THE EXISTING COMMUNICATION CABLES BY JOINING WITH NEW.

03	ISSUED FOR INFORMATION - 100% DETAILED DESIGN	RS	SA	GD	03.10.2025
02	ISSUED FOR INFORMATION - 95% DETAILED DESIGN	RS	SA	GD	10.09.2025
01	ISSUED FOR INFORMATION - 80% DETAILED DESIGN	RS	CR	MK	18.07.2025
Issue	Description	DR	CH	VE	Date


Scales
0 0.5 1 1.5 2 2.5m
1 : 25

Surveyor	 
Architect	

Client	
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Status	PRELIMINARY NOT TO BE USED FOR CONSTRUCTION		
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Original Issue Signatures			
Drawn	R. SANTOS	Original Size	A1
Designed	H.THIAUW	Height Datum	AHD
Project Manager	S. GEERDINK	Grid	MGA/20-56
Verified	S. ASHMAN		

Project	PARRAMATTA CIVIC LINK PHILLIP STREET WORKS
Title	LIGHTING DETAILS SHEET 3

	
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Project Number	30286862
Issue	03
Drawing No. CL3-AAP-DD-PS-DRG-CI-0713	


NOTES:
1. SMARTPOLE FOOTING DETAILS, CONDUIT ARRANGEMENT AND HD BOLT SETUP ARE EXTRACTED FROM HUB GROUP DRAWINGS.
2. LIGHTPOLE BASE PLATE MUST BE VERIFIED AND CHECKED BY THE MANUFACTURER.

POLE LOADING AND BASE REACTIONS TABLE									
PART No.	POLE	LOAD CASE	MOMENT		TORQUE	SHEAR		AXIAL	
			M*x(kNm)	M*y(kNm)		V*x(kNm)	V*y(kNm)		
SAS-101	S1A 12.0m	A - Wind from side	96	13	27	0	15	10	
		B - Wind from back	12	67	3	9	2	10	
SAS-102	S1A 9.6m	A - Wind from side	96	13	27	0	15	10	
		B - Wind from back	12	67	3	9	2	10	
SAS-103	S1B 9.6m	A - Wind from side	58	0	2	0	11	5	
		B - Wind from back	0	38	0	7	0	5	
SAS-104	S1B 7.2m	A - Wind from side	37	0	1	0	7	5	
		B - Wind from back	0	37	1	7	0	5	
SAS-105	S1B 4.8m	A - Wind from side	18	0	1	0	5	5	
		B - Wind from back	0	18	1	5	0	5	
SAS-106	S2B 7.2m	A - Wind from side	46	5	3	1	10	4	
		B - Wind from back	3	23	1	5	1	4	
SAS-107	S2C 7.2m	A - Wind from side	44	5	3	1	10	4	
		B - Wind from back	2	21	1	5	1	4	
SAS-108	S2C 4.8m	A - Wind from side	18	2	1.5	1	6	3	
		B - Wind from back	2	18	1.5	6	1	3	
SAS-109	S2D 5.0m	A - Wind from side	13	1	1	0	4	2	
		B - Wind from back	1	13	1	4	0	2	


FOUNDATION TABLE				
POLE Type	SQUARE Dim	PAD DEPTH	PAD REINFORCEMENT Top & Bottom	PIER DEPTH
S1A 12-9.6m	2.5m	0.75m	9N16	2.8m
S1B 9.6m	2.0m	0.7m	7N16	2.0m
S1B 7.2-4.8m	1.5m	0.8m	6N12	1.8m
S2B 7.2m	1.5m	0.6m	N16-200	2.0m
S2C 7.2m	1.5m	0.6m	N16-200	2.0m
S2C 4.8m	1.2m	0.45m	N16-250	1.3m
S2D 5.0m	1.2m	0.45m	N16-250	1.3m
S2 4.75m	1.2m	0.5m	N16-200	1.2m

NOTE: Design based on following conditions.
1. Concrete cover to reinforcement 50mm
2. Concrete strength f'c=32MPa
3. Soil Parameters:
peirs - Cu = 40kPa
pad - minimum bearing capacity 150kPa
4. A Geo Technical survey is required to determine each specific sites conditions.
5. The following is for comparison only.
6. Refer to Fully Loaded Dwg's for detailed pole configuration.

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INFORMATION ONLY

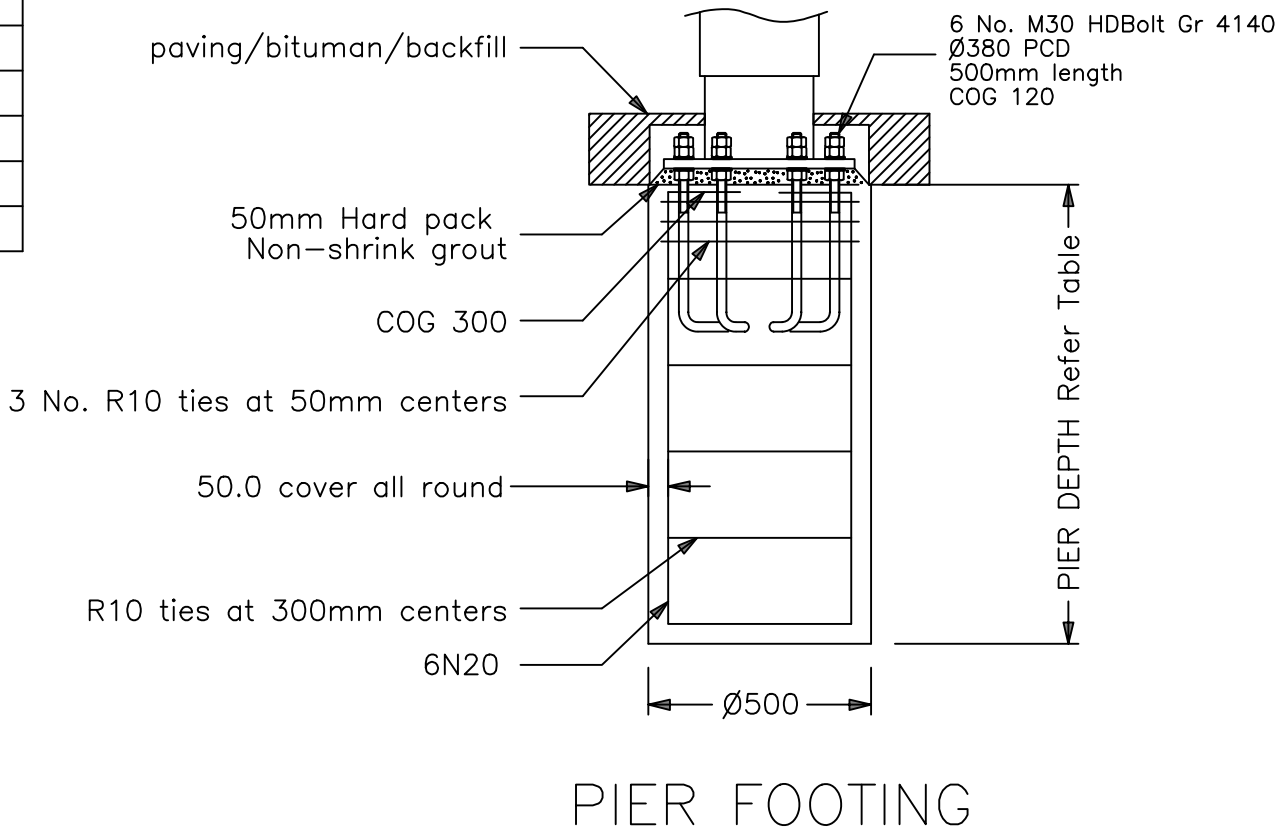


TYPICAL FOOTING DETAILS
(HUB GROUP)

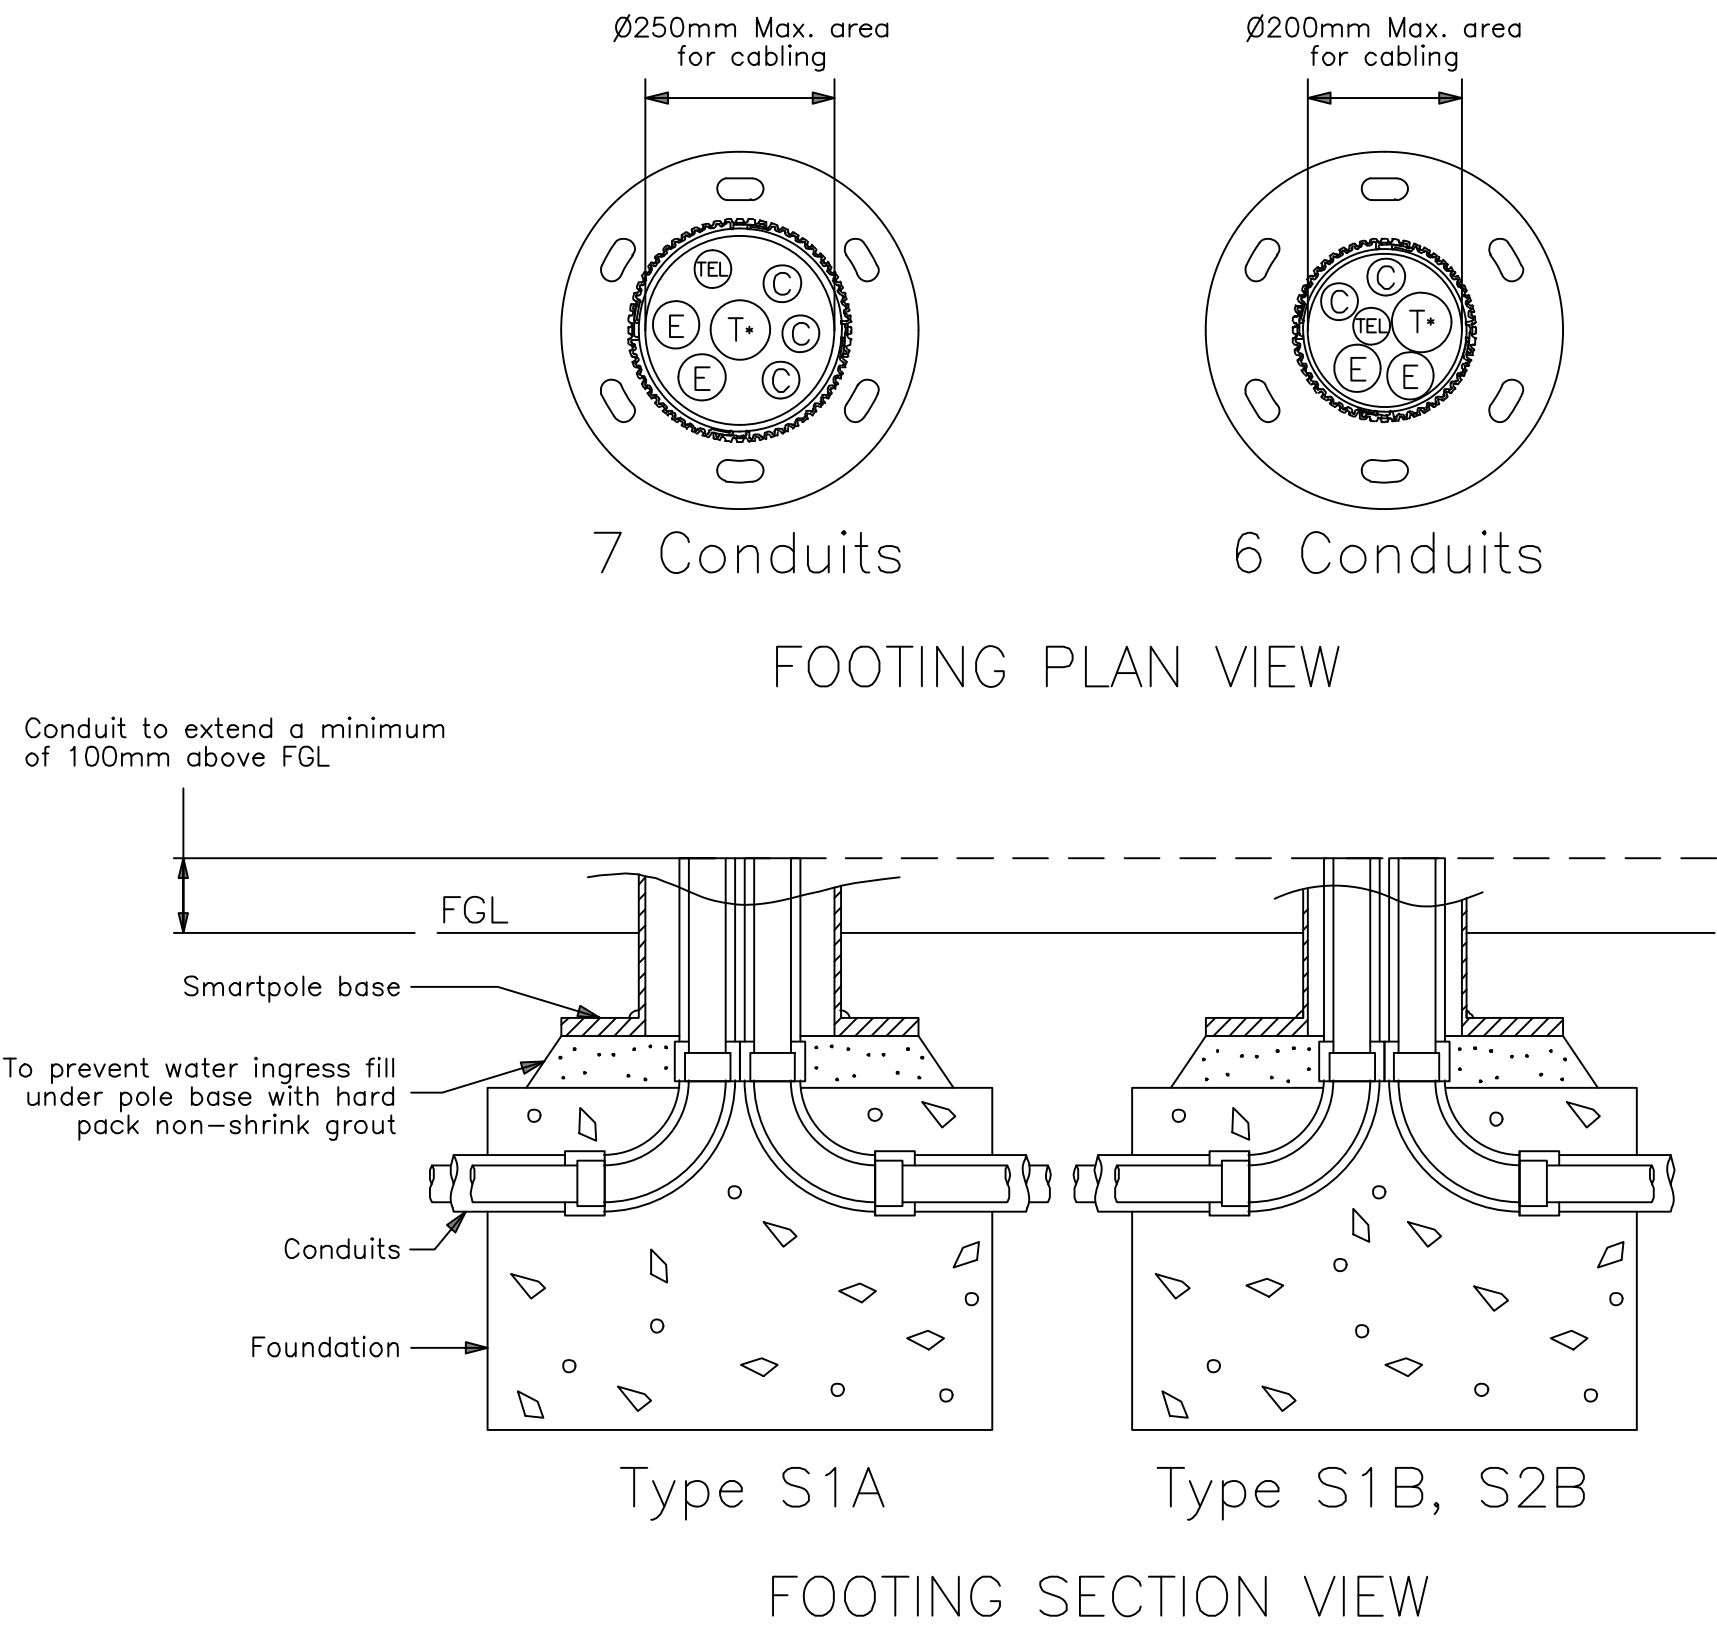

SYMBOLS	TEL	-Ø50 Teleco.
	C	-Ø50 Council
	E	-Ø63 Electricity
	T	-Ø80 Traffic Signal

NOTE: All conduits as shown in the plan views shall be placed in all Smartpoles. Where the Ø80 Traffic conduit is not used for traffic signals then the use of this conduit is at the discretion of the council. Micropalls - Where fitted to Smartpole the Ø50 Telecommunications conduit shall be segregated from the other services. This is to be achieved by running the conduit from the base of the pole to the underside of the mounted unit. Approx. 5m.

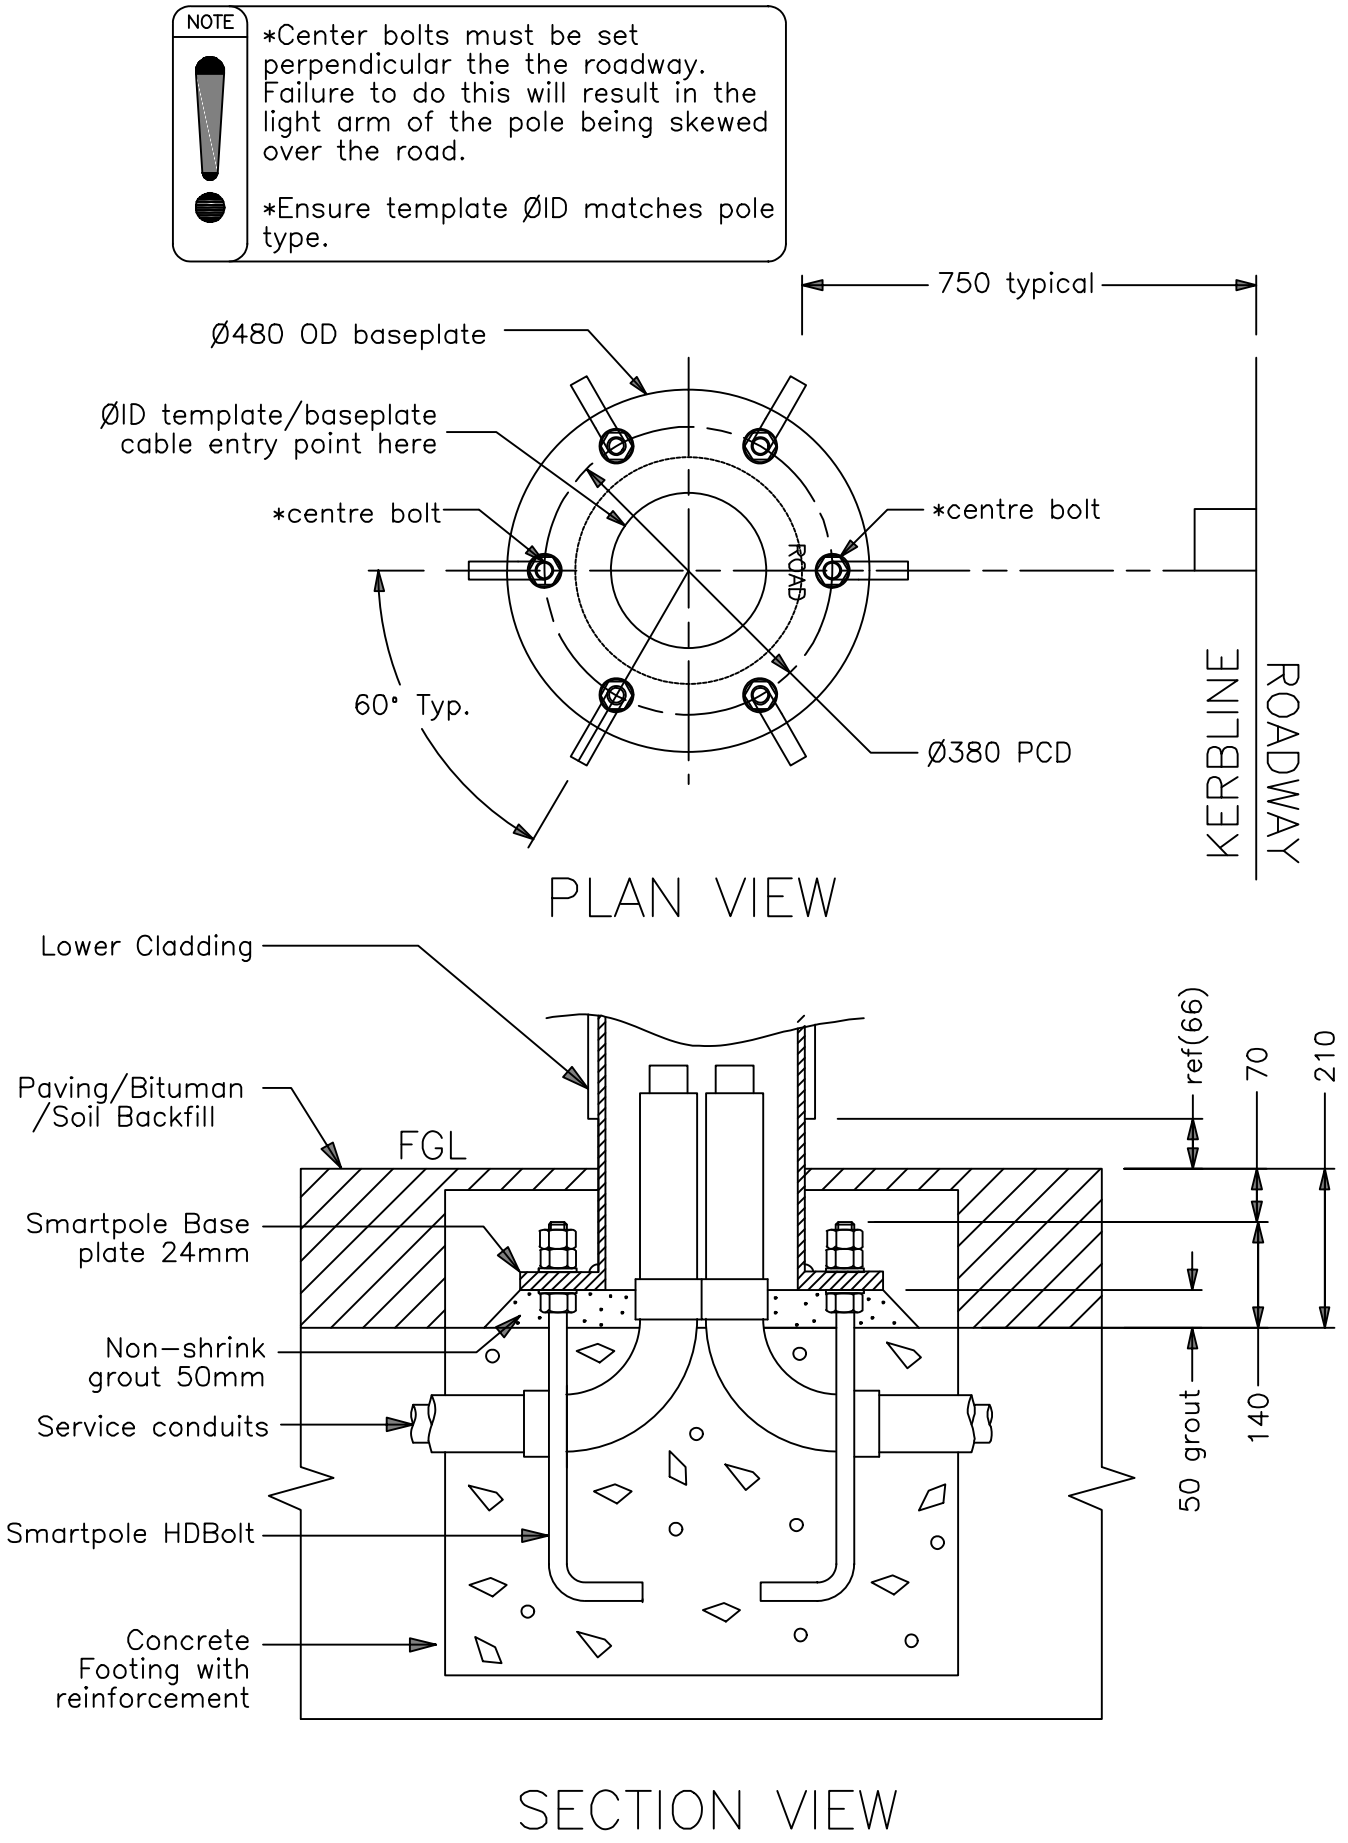


TYPICAL CONDUIT ARRANGEMENT
(HUB GROUP)



SECTION VIEW
TYPICAL HDBOLT SETUP
(HUB GROUP)

03	ISSUED FOR INFORMATION - 100% DETAILED DESIGN	RS	SA	GD	03.10.2025
02	ISSUED FOR INFORMATION - 95% DETAILED DESIGN	RS	SA	GD	10.09.2025
01	ISSUED FOR INFORMATION - 80% DETAILED DESIGN	RS	CR	MK	18.07.2025
Issue	Description	DR	CH	VE	Date


Scales				
NOT TO SCALE				


Surveyor	 
Architect	

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Status		PRELIMINARY NOT TO BE USED FOR CONSTRUCTION	
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Original Issue Signatures			
Drawn	R. SANTOS	Original Size	A1
Designed	H.THIAUW	Height Datum	AHD
Project Manager	S. GEERDINK	Grid	MGA/20-56
Verified	S. ASHMAN		


Project	PARRAMATTA CIVIC LINK PHILLIP STREET WORKS		
Title	LIGHTING DETAILS SHEET 4		

		Arcadis Australia Pacific Pty Limited Level 16, 580 George Street SYDNEY NSW 2000 ABN 76 104 485 289 Tel No: +61 2 8907 9000 www.arcadis.com/au	
Project Number	30286862	Issue	03
Drawing No.		CL3-AAP-DD-PS-DRG-CI-0714	

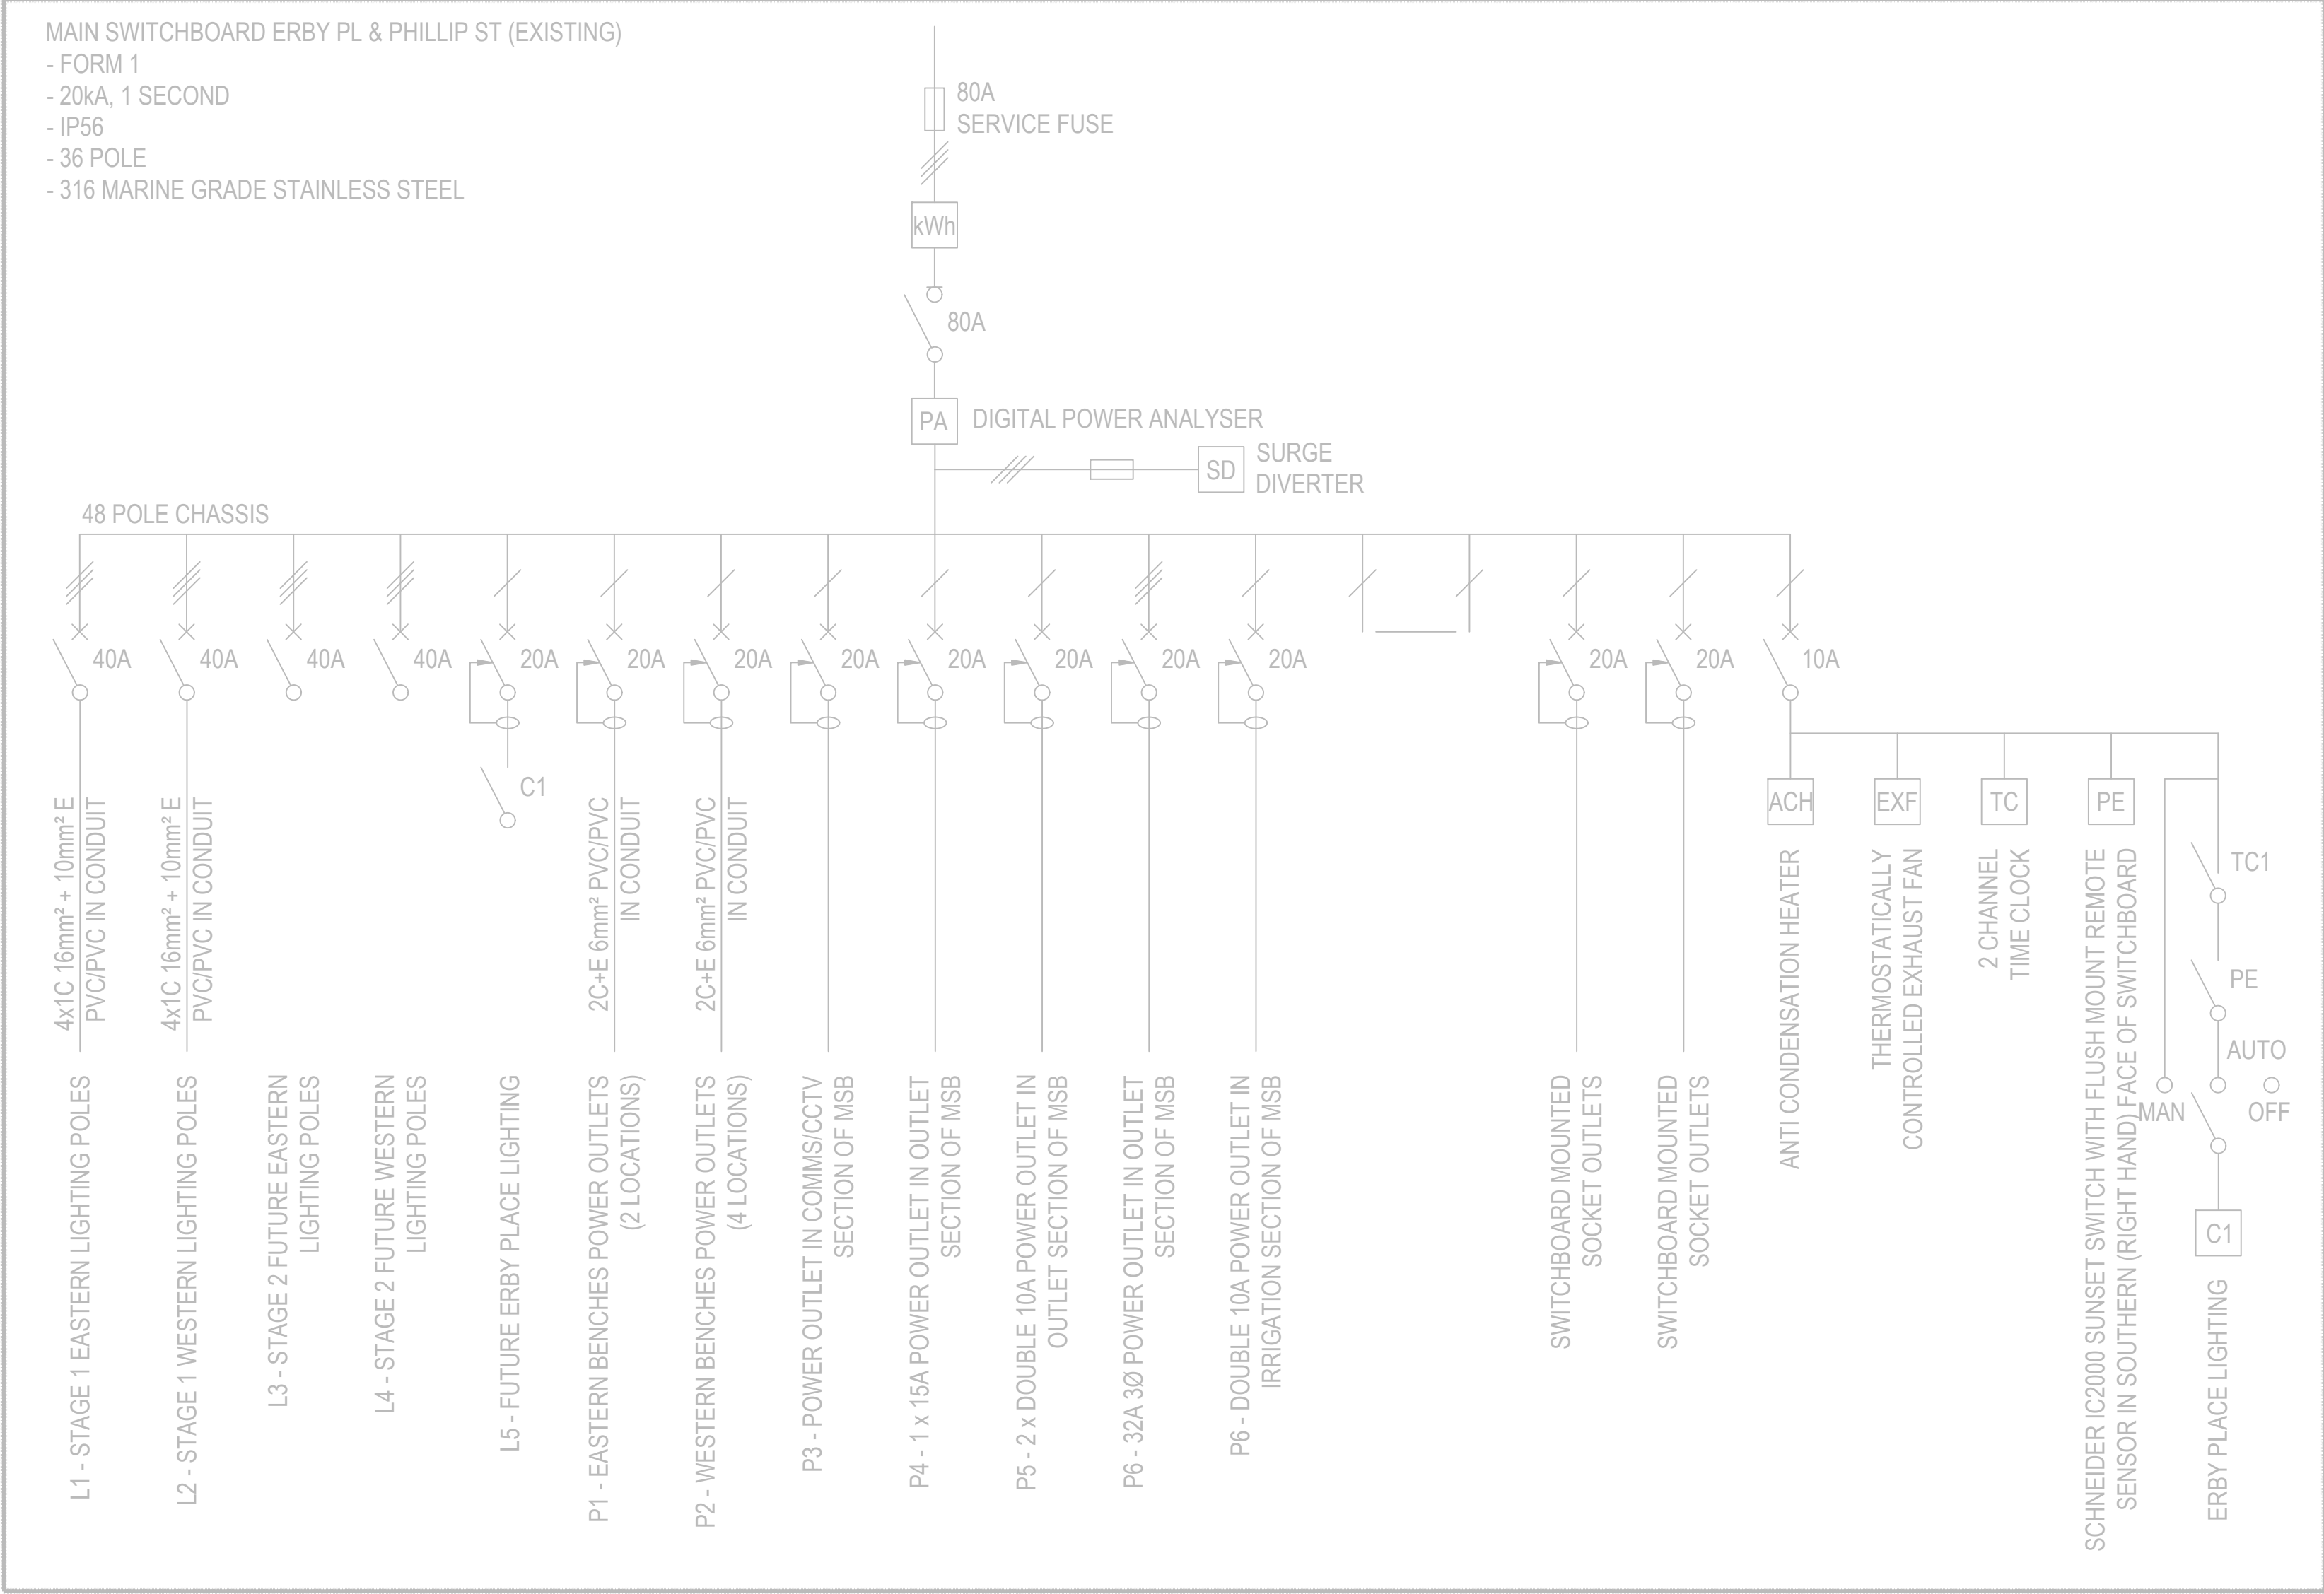


EXISTING ERBY PLACE AND PHILLIP STREET MAIN SWITCHBOARD SINGLE LINE DIAGRAM

NOT TO SCALE

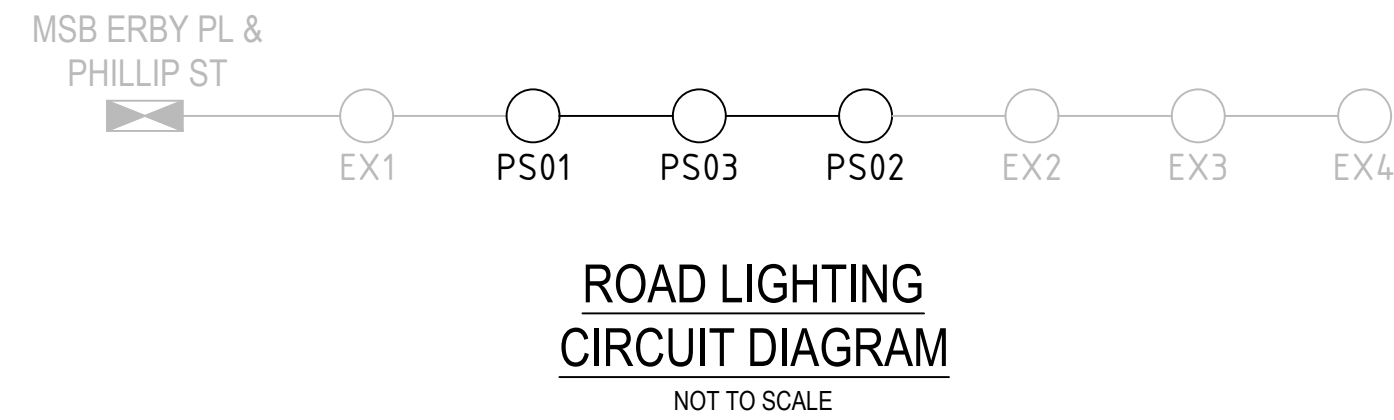

ROAD LIGHTING CIRCUIT DIAGRAM

NOT TO SCALE

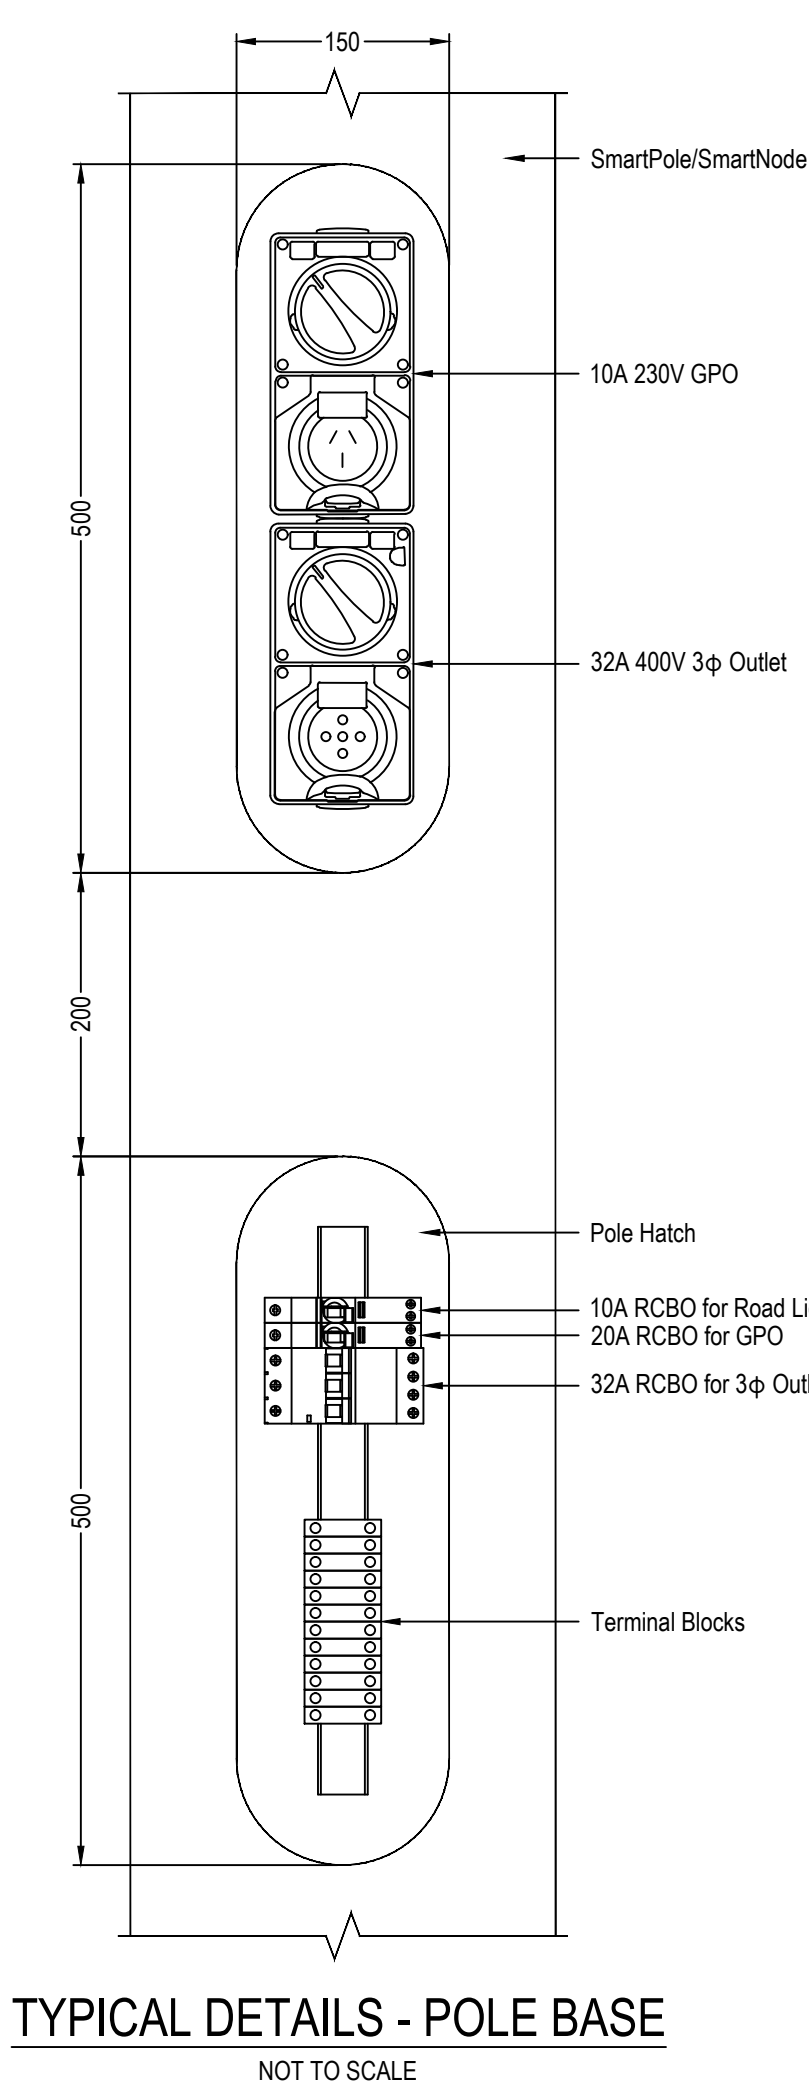

TYPICAL DETAILS - POLE BASE


NOT TO SCALE

LEGEND

- CIRCUIT BREAKER
- CIRCUIT BREAKER RCD TYPE
- ISOLATOR
- CONTACTOR
- EARTH
- SURGE PROTECTION DEVICE
- SUPPLY AUTHORITY METER
- PHOTO CELL
- TIME CLOCK
- MAIN SWITCHBOARD
- PHASE CONNECTION
- LIGHTING COLUMN

NOTES:

- THE SINGLE LINE DIAGRAM FOR ERBY PL & PHILLIP ST MAIN SWITCHBOARD IS EXTRACTED FROM LIGHTING, ART & SCIENCE (LAS) ELECTRICAL DRAWING DOCUMENTATION, ISSUE C1-CONSTRUCTION ISSUE DATED ON 25/05/20, PROVIDED BY CITY OF PARRAMATTA.
- THE CONTRACTOR SHALL CONDUCT A COMPULSORY SITE VISIT PRIOR TENDER TO CONFIRM THAT THE SWITCHGEAR, CIRCUITS AND CABLING INSTALLED ARE THE SAME AS LAS CONSTRUCTION ISSUE DOCUMENTATION. IF THERE IS A DEVIATION OR ADDITION FROM THE LAS CONSTRUCTION ISSUE DOCUMENTATION, CONTRACTOR SHALL RAISE IT TO THE CITY OF PARRAMATTA PRIOR TENDER.
- THE DETAILS ON SCHEMATIC IS APPLICABLE FOR THE LIGHTING WORK ON PHILLIP STREET.
- CONTRACTOR TO INSPECT THE ORIGIN OF THE RELOCATED ROAD LIGHT (PS01) AND PEDESTRIAN FLOODLIGHT (PS02) CIRCUITS THEN ALLOCATE THE PHASE CONNECTION FOR POLE PS03 ACCORDINGLY.
- CONTRACTOR SHOULD USE A NEW CABLING FROM THE FIRST ROAD LIGHT (EX1) TO THE RELOCATED PS01.
- CONTRACTOR SHOULD USE A NEW CABLING FROM POLE PS01 TO EX2.
- THE CABLING METHOD SHALL FOLLOW CITY OF PARRAMATTA INSTALLATION GUIDELINE, WHICH IS LOOP IN LOOP OUT.
- THE POWER SUPPLY FOR BICYCLE/SCOOTER/PEDESTRIAN COUNTING DEVICE AT PS02 SHALL BE CONNECTED TO PS02 GPO CIRCUIT.
- THE EQUIPMENT SHOWN IN THE TYPICAL DETAILS - POLE BASE ARE VARY BETWEEN POLE. CONTRACTOR SHALL REFER TO THE POLE SCHEDULE FOR THE REQUIRED EQUIPMENT ON EACH POLE THEN PROVIDE THE AMOUNT OF CIRCUIT BREAKERS AND TERMINAL BLOCKS ACCORDINGLY.

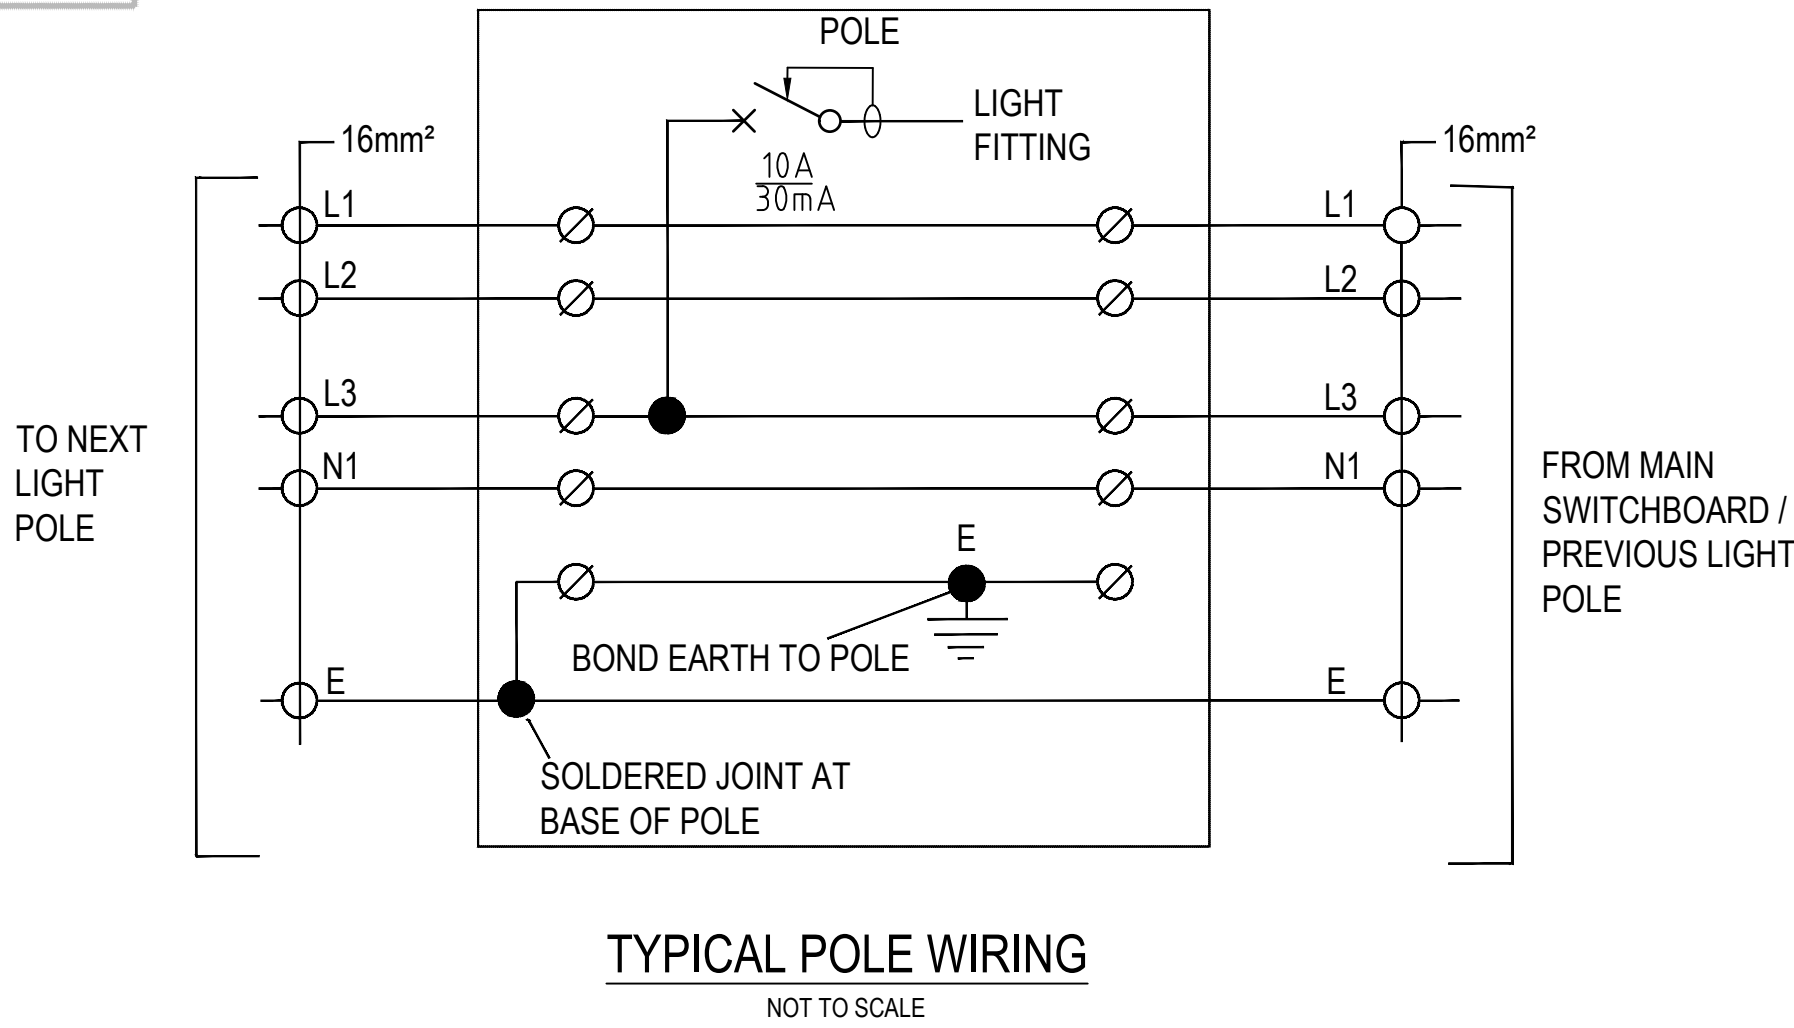




TYPICAL POLE WIRING

NOT TO SCALE

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02	ISSUED FOR INFORMATION - 95% DETAILED DESIGN	RS	SA	GD	10.09.2025
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
Scales
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Status	PRELIMINARY NOT TO BE USED FOR CONSTRUCTION		
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Original Issue Signatures			
Drawn	R. SANTOS	Original Size	A1
Designed	H.THIAUW	Height Datum	AHD
Project Manager	S. GEERDINK	Grid	MGA/20-56
Verified	S. ASHMAN		

Project	PARRAMATTA CIVIC LINK PHILLIP STREET WORKS
Title	LIGHTING DETAILS SHEET 5

	
Arcadis Australia Pacific Pty Limited Level 16, 580 George Street SYDNEY NSW 2000 ABN 76 104 485 289 Tel No: +61 2 8907 9000 www.arcadis.com/au	
Project Number	30286862
Issue	03
Drawing No: CL3-AAP-DD-PS-DRG-CI-0715	

LUMINAIRE SCHEDULE							
POLE NUMBER	CODE	DESCRIPTION	PRODUCT CODE AND NAME	FINISH	CONTROL GEAR	OPTICS	SUPPLIER
PS03	FL1	POLE MOUNTED FLOODLIGHT - SASTA LED MAXIMUS 150W, 4000K, IP66, IK07 WITH 7 PIN NEMA BASE. MOUNTED AT 7.0m HIGH	SL99Z43L150 - SLED2 150W 4K XT PES7 CO 9007	TO MATCH WITH EXISTING	INTEGRAL DALI-2 DRIVER	ASYMMETRIC	SYLVANIA SCHREDER

NOTE:

1. CONTRACTOR SHALL SUPPLY AND INSTALL THE REQUIRED ACCESSORIES IN ORDER TO ENABLE COMPLETE INSTALLATION.

POLE SCHEDULE																	
POLE NUMBER	POLE SETOUT (CENTRE OF POLE)		POLE HEIGHT (m)	OUTREACH LENGTH (m)	POLE TYPE	FINISH	STANDARD HUB PIER FOOTING	LUMINAIRE TYPE	LUMINAIRE MOUNTING HEIGHT (m)	LUMINAIRE UPCAST (°)	SMART LIGHTING CONTROLLER	3Ø OUTLET	GPO	CCTV (PTZ)	BICYCLE/SCOOTER/ PEDESTRIAN COUNTER	Wi-Fi	WAYFINDING SIGNAGE BRACKETS
	EASTING	NORTHING															
PS01 (EW01)	315383.902	6256828.370	9.6	3	EXISTING	EXISTING	STANDARD HUB	EXISTING	9	0	✓	N/A	✓	N/A	N/A	N/A	✓
PS02 (EW02)	315418.614	6256817.443	9.6	4	EXISTING	EXISTING	STANDARD HUB	EXISTING	7	0	✓	✓	✓	✓	✓	✓	✓
PS03 (EW03)	315406.580	6256830.298	9.6	4	S1A FROM HUB GROUP	TO MATCH WITH EXISTING	STANDARD HUB	FL1	7	0	✓	N/A	✓	✓	N/A	N/A	✓

NOTE:

1. THE PROPOSED POLES LOCATION HAVE BEEN COORDINATED WITH OTHER SERVICES AND AVOID THE EXISTING UNDERGROUND SERVICES. THEREFORE, THE POLE SETOUT SHALL BE FOLLOWED.

2. PS01 AND PS02 ARE AN EXISTING SMARTPOLE TO BE REUSED AND RELOCATED TO THE NEW POSITION AS PER POLE SETOUT. CONTRACTOR SHALL PERFORM CONDITION ASSESSMENT OF EXISTING POLES AND CONFIRM THEY ARE SUITABLE TO BE REUSED PRIOR TO START OF CONSTRUCTION

3. THE EXISTING FLOODLIGHT FOR POLE PS02 IS TO BE MOUNTED AT COORDINATE X = 315419.476; Y = 6256820.421

4. THE NEW FLOODLIGHT FL1 FOR POLE PS03 IS TO BE MOUNTED AT COORDINATE X = 315405.873; Y = 6256827.847

5. CONTRACTOR SHALL PROVIDE THE REQUIRED ACCESSORIES AND EQUIPMENT FOR EACH POLE AS SHOWN IN THE ABOVE TABLE.

6. CONTRACTOR SHALL LIAISE WITH HUB GROUP, COUNTCULTURE, CCTV AND WIFI SUPPLIER FOR THE REQUIRED OUTREACH ARM.

7. CONTRACTOR SHALL LIAISE WITH SCHREDER FOR THE EXEDRA TALQ OWLET SLCs SMART LIGHTING CONTROLLER.

8. THE EXISTING FIXED 4 WAY CCTV CAMERA ON POLE PS01 (EW01) SHALL BE RETAINED.

9. THE EXISTING CCTV CAMERA ON POLE PS02 (EW02) SHALL BE DECOMMISSIONED AND RETURNED TO CITY OF PARRAMATTA. IT SHALL BE REPLACED WITH A NEW MODEL FROM **HANWHA PNM-C34404RQPZ**. THE POLE PS03 SHALL BE EQUIPPED WITH THE SAME CCTV CAMERA MODEL AS POLE PS02.

10. THE EXISTING COMMUNICATION CABLES HAVE TO BE RE-ROUTED THROUGH THE NEW CONDUITS AND PITS THEN RECONNECTED TO THE EXISTING EQUIPMENTS (CCTV CAMERAS AND WI-FI).

11. THE EXISTING COMMUNICATION CABLES HAVE TO BE REPLACED WITH NEW IF THE LENGTH IS INSUFFICIENT TO REACH THE EQUIPMENT AFTER RE-ROUTING. APPROVAL FROM CITY OF PARRAMATTA ASSET TEAM IS REQUIRED IF CONTRACTOR PROPOSES TO EXTEND THE EXISTING COMMUNICATION CABLES BY JOINING WITH NEW.

12. THE GPO AND 3Ø OUTLET IN THE POLE BASE SHALL BE LOCKABLE TYPE.


EQUIPMENT SCHEDULE		
ITEM	DESCRIPTION	SUPPLIER
PIT	600x600 ELECTRICAL AND COMMUNICATION PIT WITH PAVING INFILL LID (CLASS D)	ACO CABLEMATE OR MASCOT ENGINEERING
CONTROL CABLE	DALI LIGHTING CONTROL CABLE 2x1.5mm ²	-

NOTE:


1. CONTRACTOR SHALL COORDINATE THE PIT LID PAVERS WITH LANDSCAPE ARCHITECTS.

2. THE PIT LID SHALL HAVE 'CoP ELECTRICAL' AND 'CoP COMMUNICATION' WORDING IMPRESSED ON THE LID.

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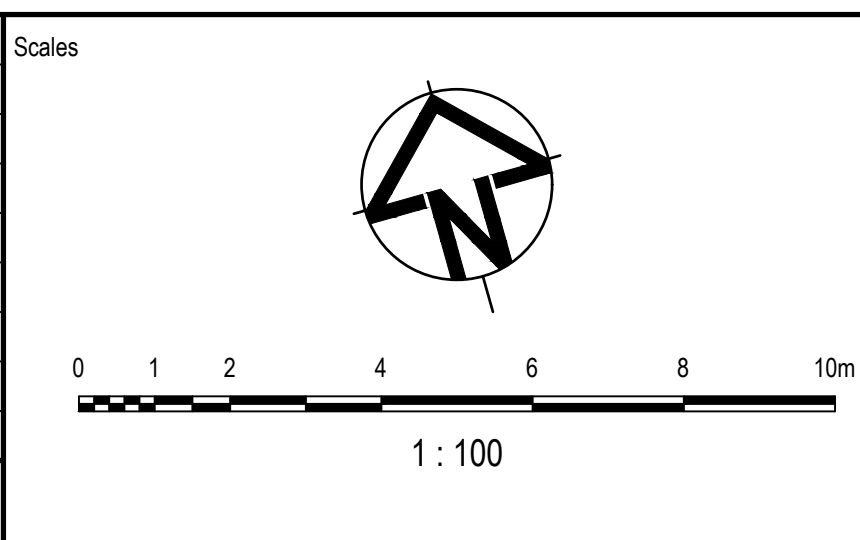


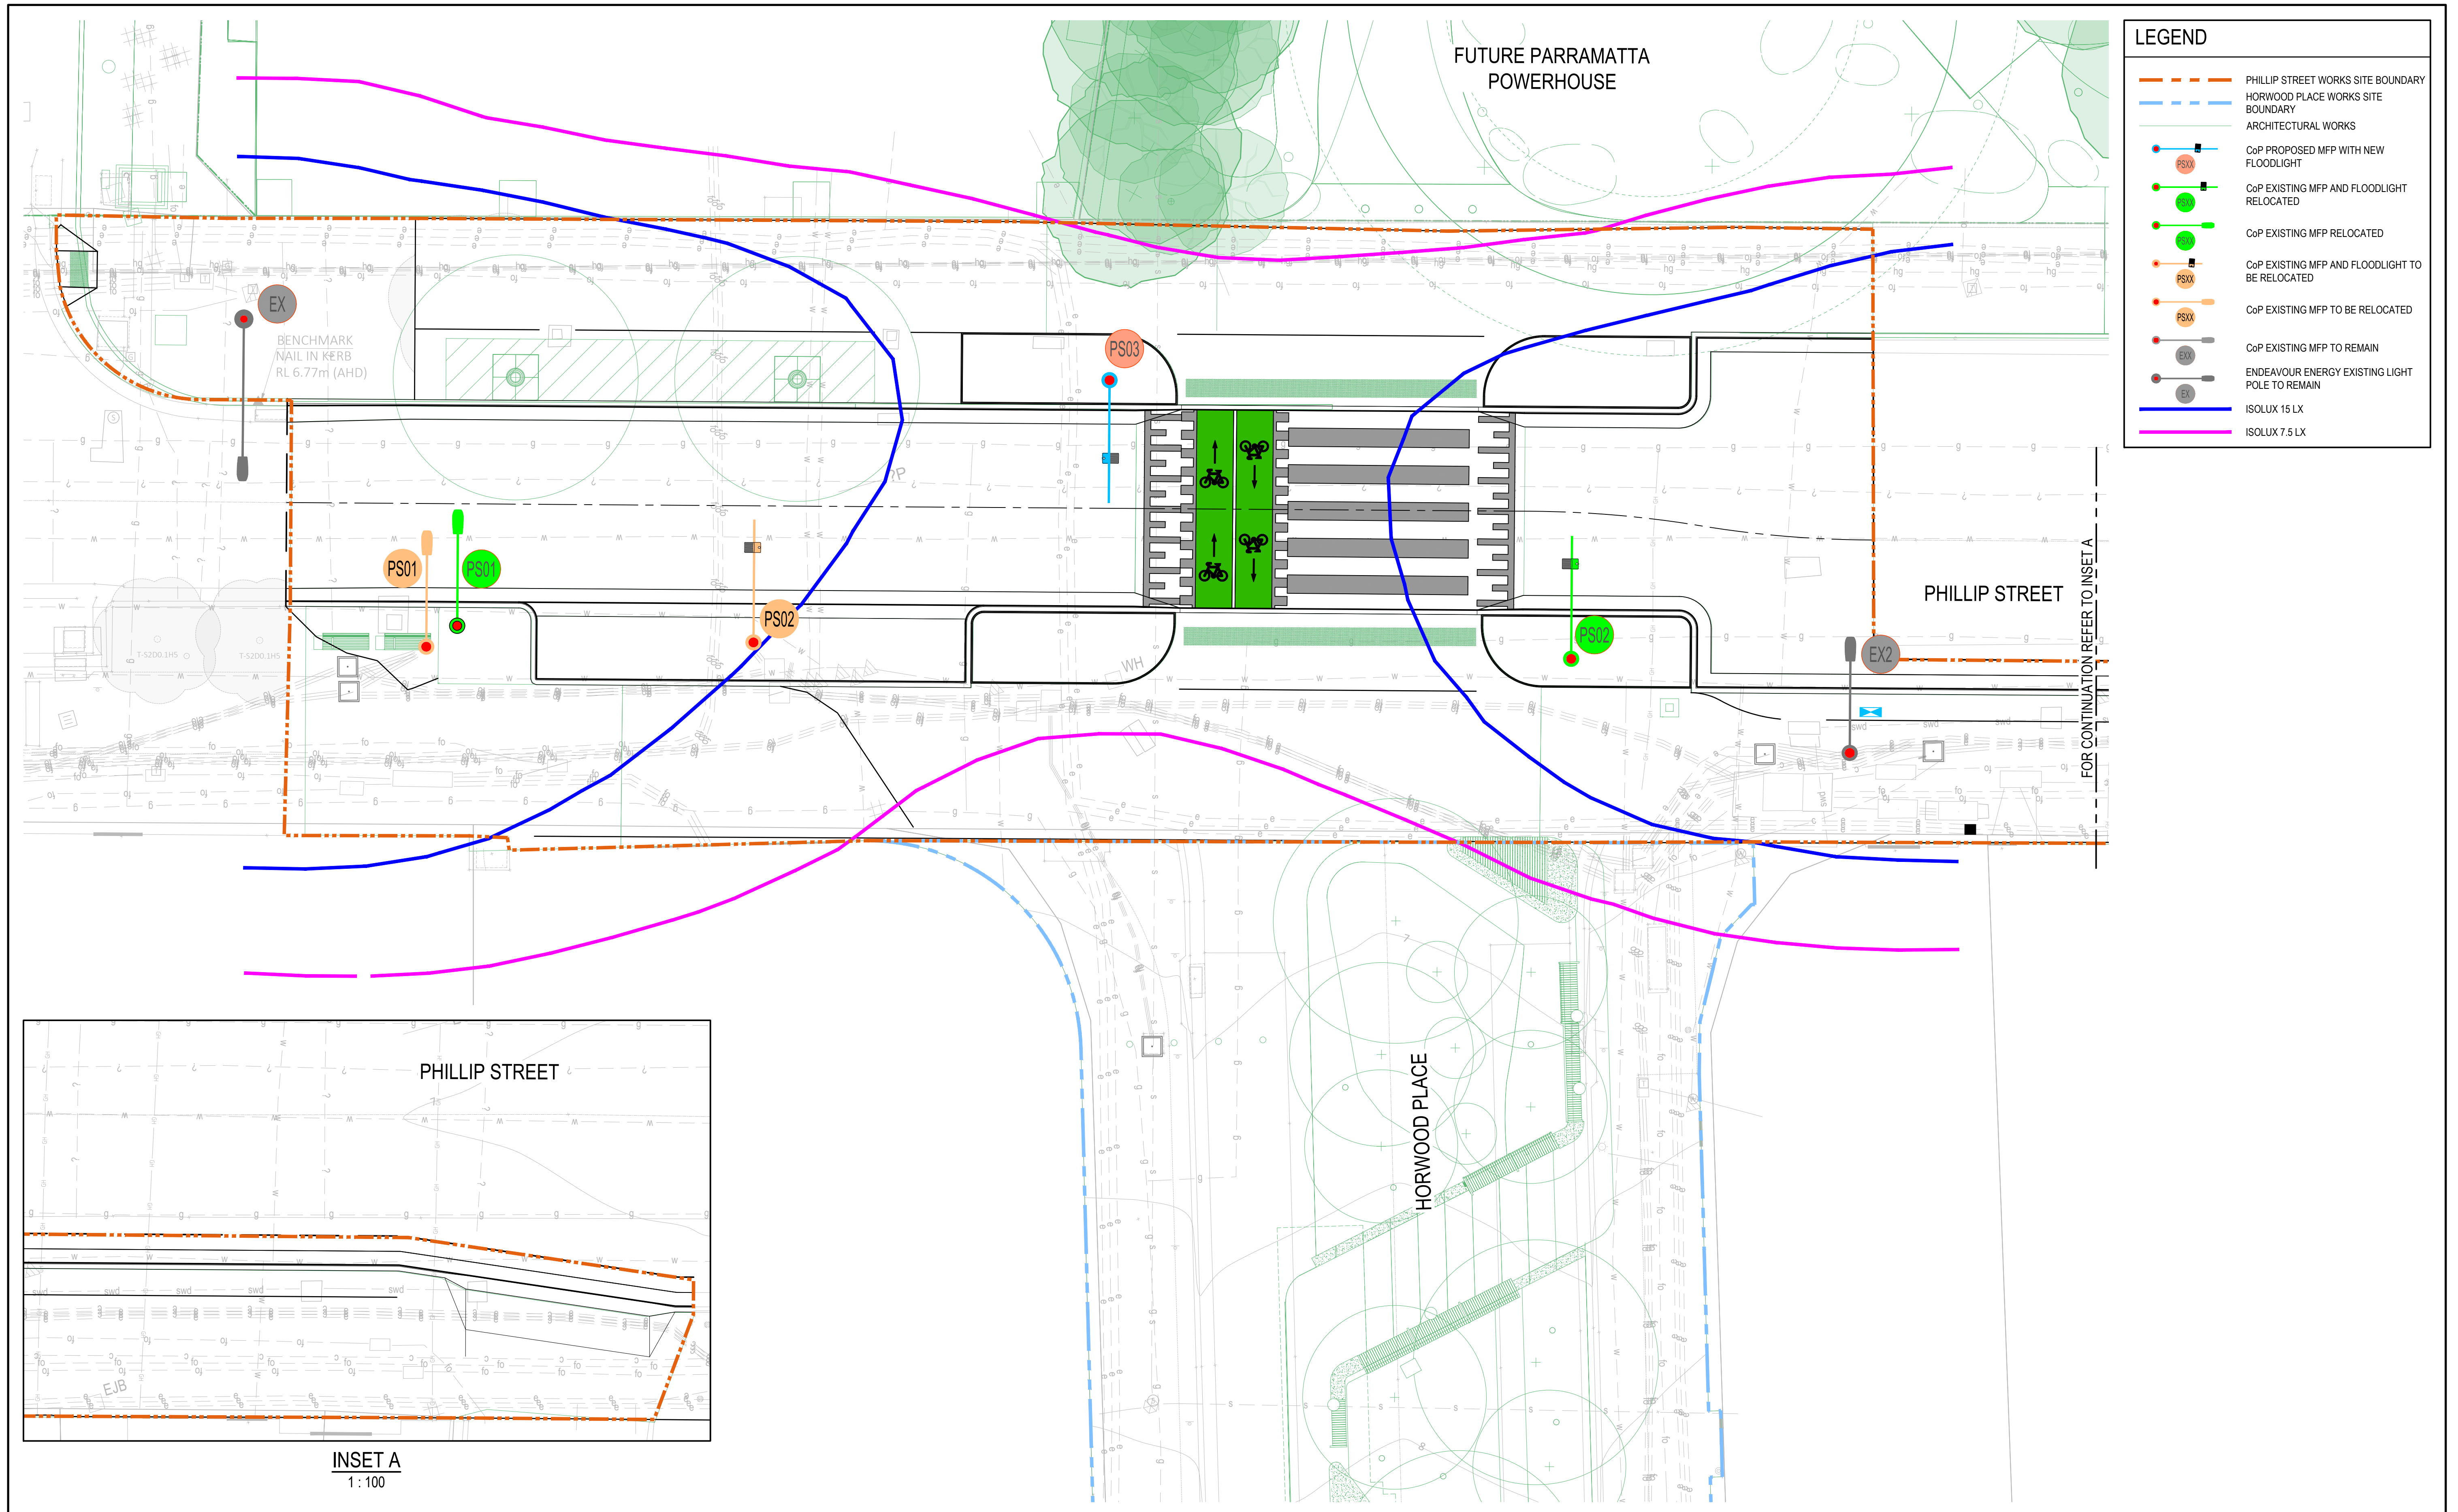LEGEND	
	PHILLIP STREET WORKS SITE BOUNDARY
	HORWOOD PLACE WORKS SITE BOUNDARY
	ARCHITECTURAL WORKS
	CoP PROPOSED MFP WITH NEW FLOODLIGHT
	CoP EXISTING MFP AND FLOODLIGHT RELOCATED
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	ENDEAVOUR ENERGY EXISTING LIGHT POLE TO REMAIN
	ISOLUX 15 LX
	ISOLUX 7.5 LX

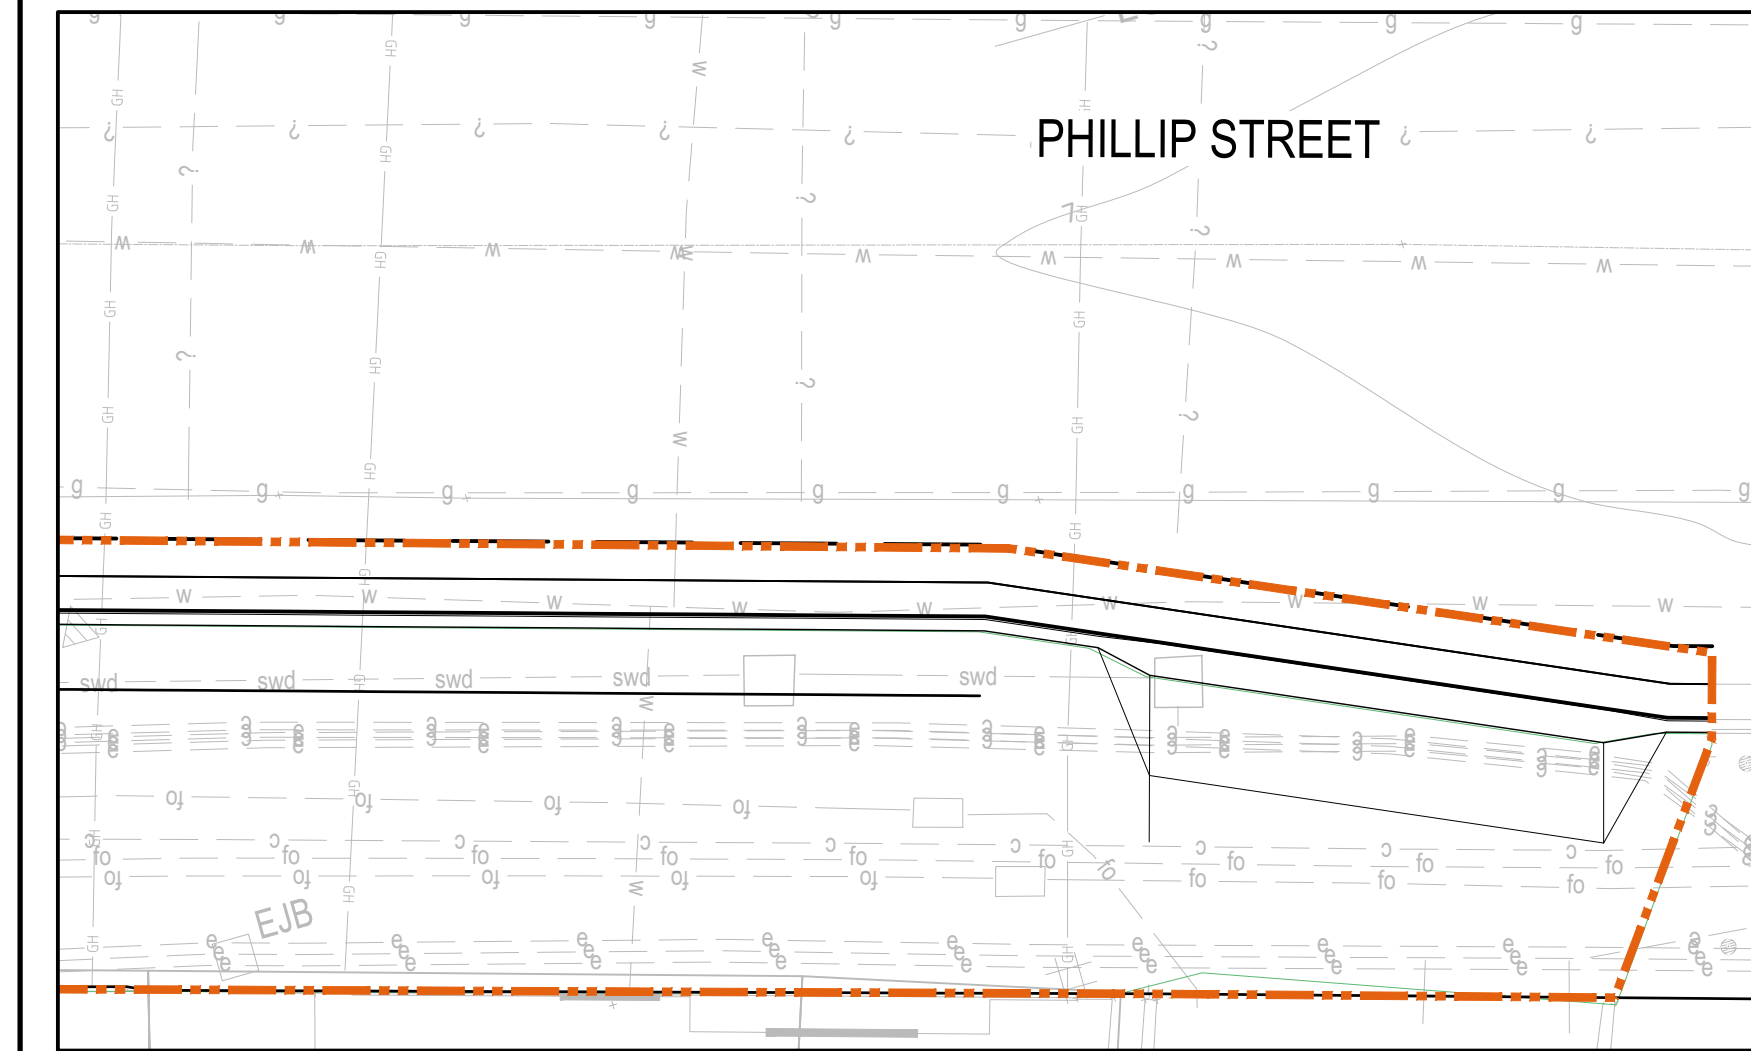

INSET A
1: 100

Issue	Description	DR	CH	VE	Date
03	ISSUED FOR INFORMATION - 100% DETAILED DESIGN	RS	SA	GD	03.10.2025
02	ISSUED FOR INFORMATION - 95% DETAILED DESIGN	RS	SA	GD	10.09.2025
01	ISSUED FOR INFORMATION - 80% DETAILED DESIGN	RS	CR	MK	18.07.2025



Surveyor

Architect

OCULUS

Client

CITY OF PARRAMATTA

Status	PRELIMINARY NOT TO BE USED FOR CONSTRUCTION		
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Original Issue Signatures			
Drawn	R. SANTOS	Original Size	A1
Designed	H.THIAUW	Height Datum	AHD
Project Manager	S. GEERDINK	Grid	MGA/20-56
Verified	S. ASHMAN		

Project
**PARRAMATTA CIVIC LINK
PHILLIP STREET WORKS**
Title
ISOLUX PLAN

Arcadis Australia Pacific Pty Limited
Level 16, 580 George Street
SYDNEY NSW 2000
ABN 76 104 485 289
Tel No: +61 2 8907 9000
www.arcadis.com/au
Project Number
30286862
Issue
03
Drawing No.
CL3-AAP-DD-PS-DRG-CI-0731